

PROJECT	DESIGNATION
2002538	2002538
CONTRACT	BRIDGE FILE
R-43470	N/A

INDIANA DEPARTMENT OF TRANSPORTATION ROAD PLANS


OAK HILL ROAD FROM LYNCH ROAD TO ST GEORGE ROAD

Note to Reviewer:


Signature Block to be added at a future submittal.

PROJECT NO. 2002538 P.E.
PROJECT NO. 2002538 R/W
PROJECT NO. 2002538 CONST.

PROJECT DESCRIPTION: This Roadway Reconstruction and Resurfacing Project is Located on Oak Hill Road from Lynch Road to St. George Road in Sections 2, 3, 10, & 11 of T 6 S, R 10 W, Center Township, Vanderburgh County, Indiana.

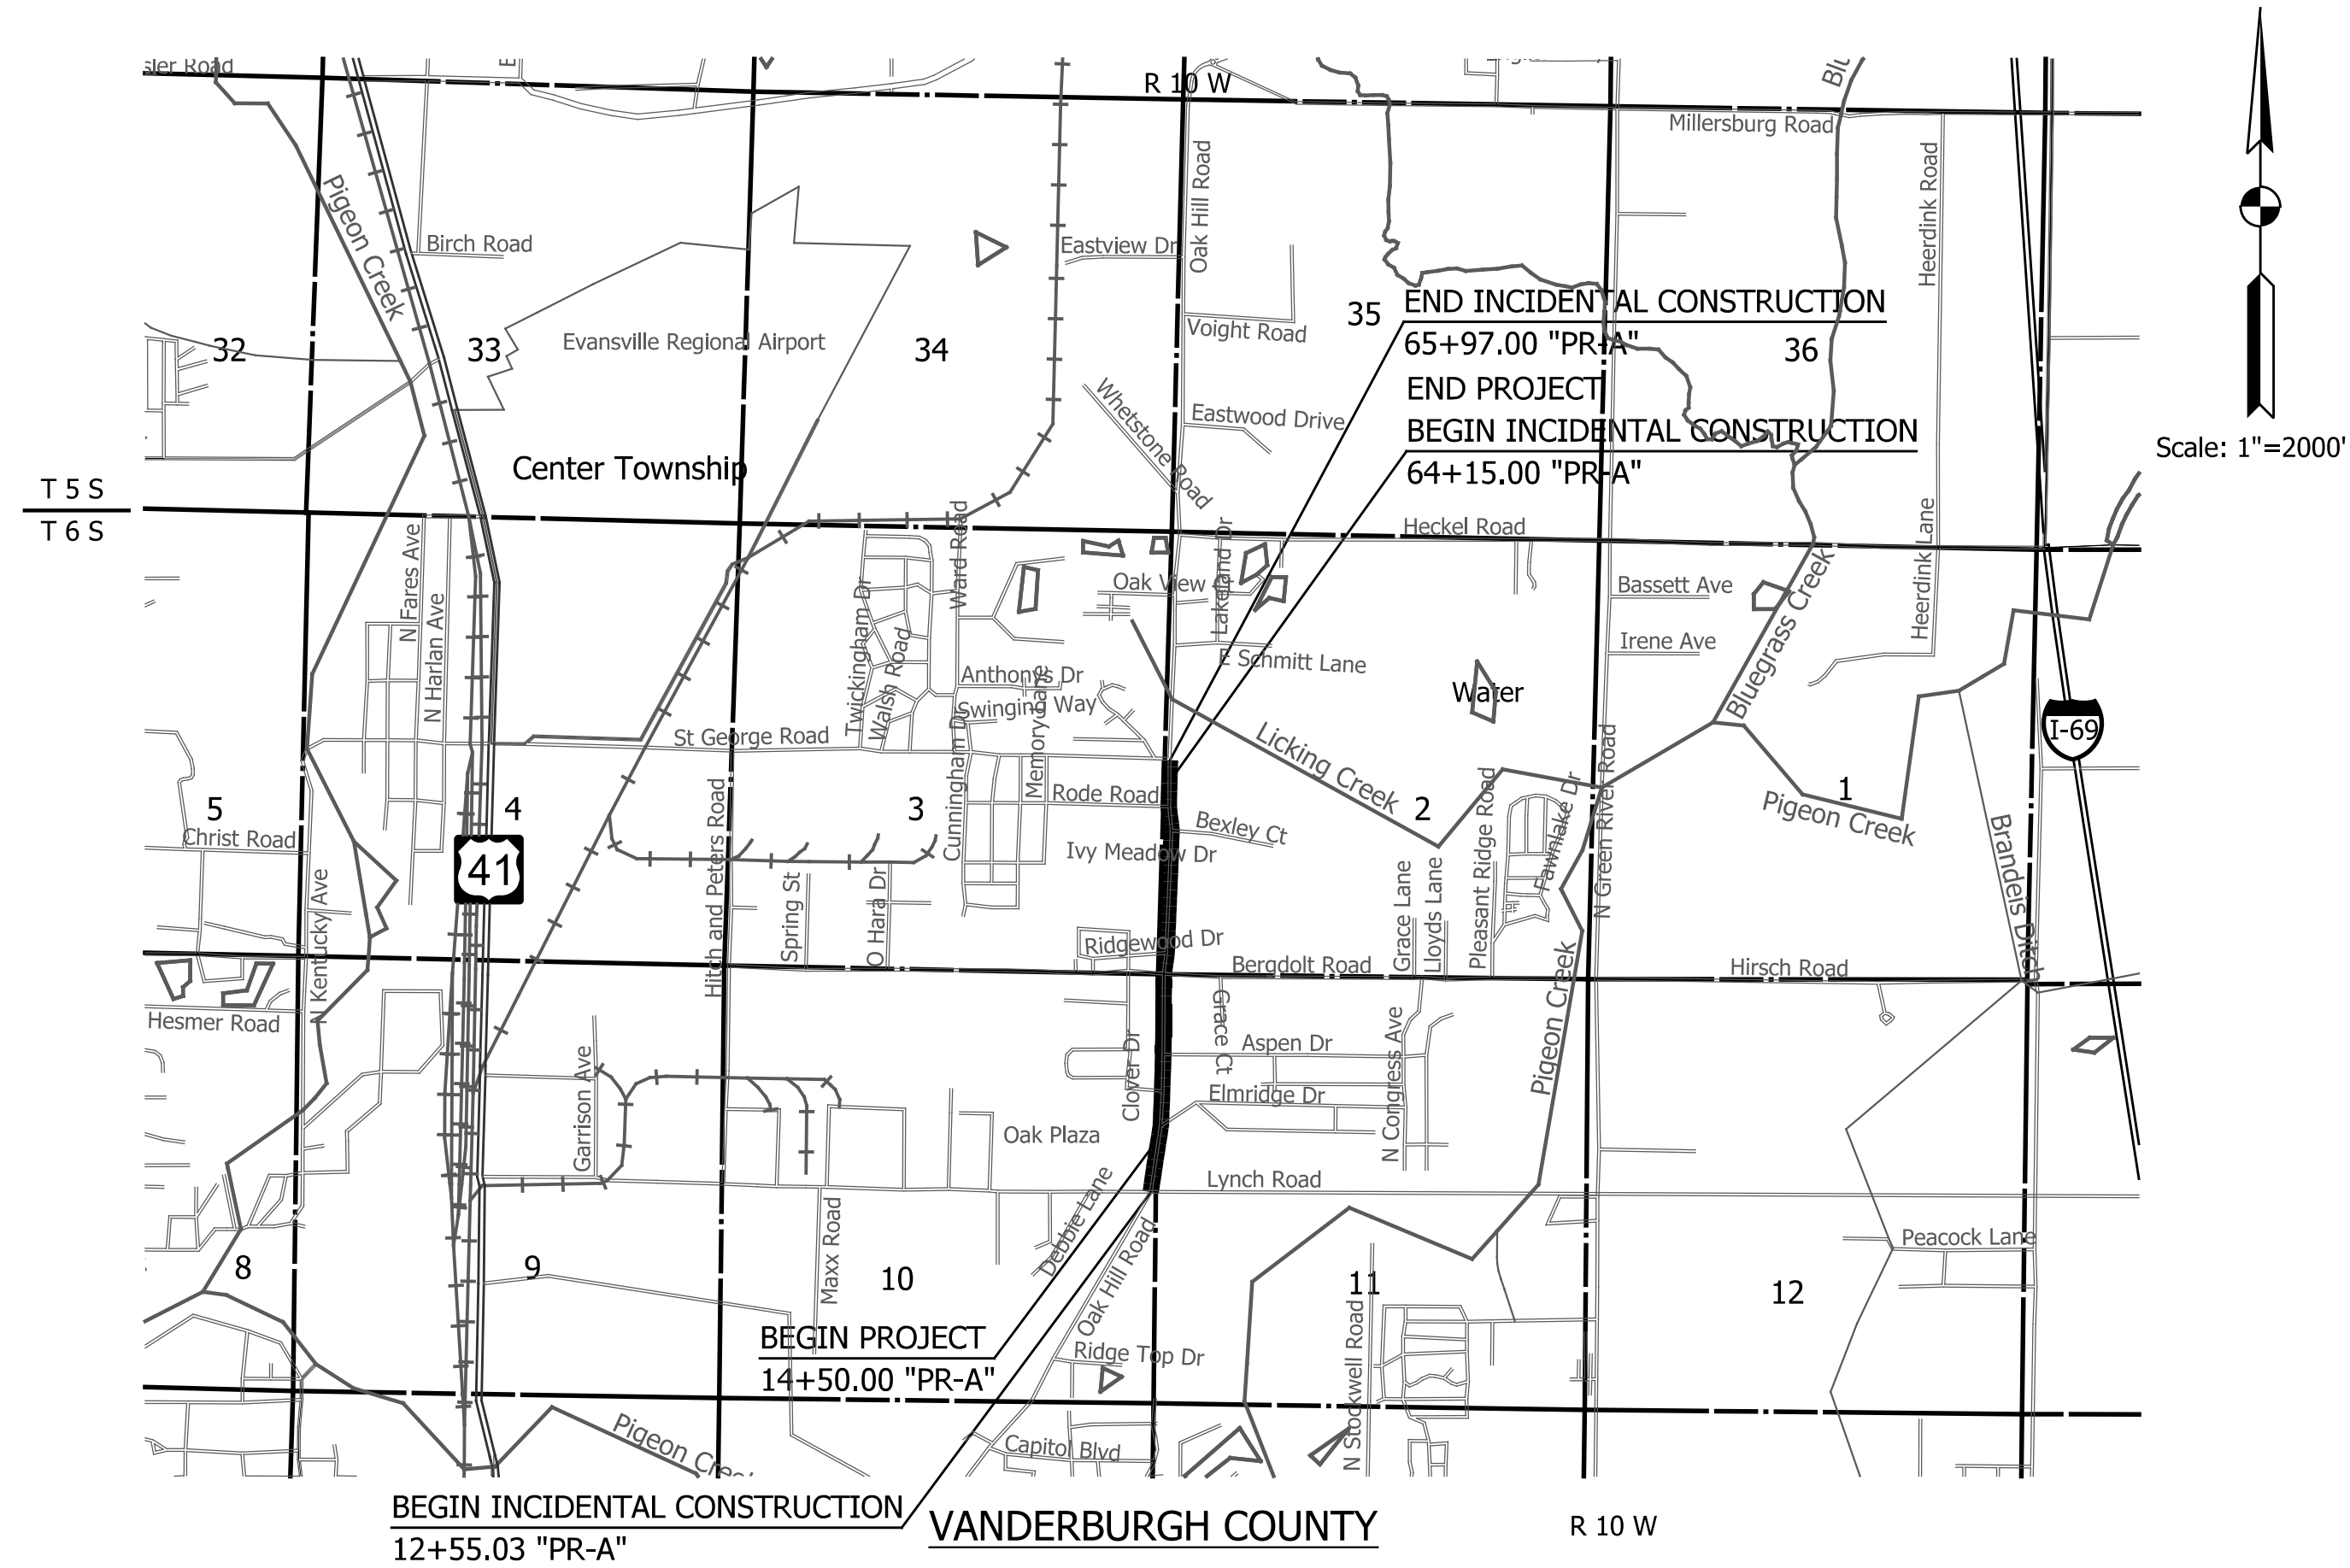

TRAFFIC DATA OAK HILL RD.	
A.A.D.T. (2025)	17,810 V.P.D.
A.A.D.T. (2045)	21,255 V.P.D.
D.H.V	1,913 V.P.H.
DIRECTIONAL DISTRIBUTION	56 %
TRUCKS	2 % A.A.D.T. 9 % D.H.V.
DESIGN DATA Lynch Rd. to St. George Rd.	
DESIGN SPEED	35 M.P.H.
PROJECT DESIGN CRITERIA	4R Reconstruction (Non-Freeway)
FUNCTIONAL CLASSIFICATION	Major Collector
RURAL/URBAN	Urban (Intermediate)
TERRAIN	Level
ACCESS CONTROL	None

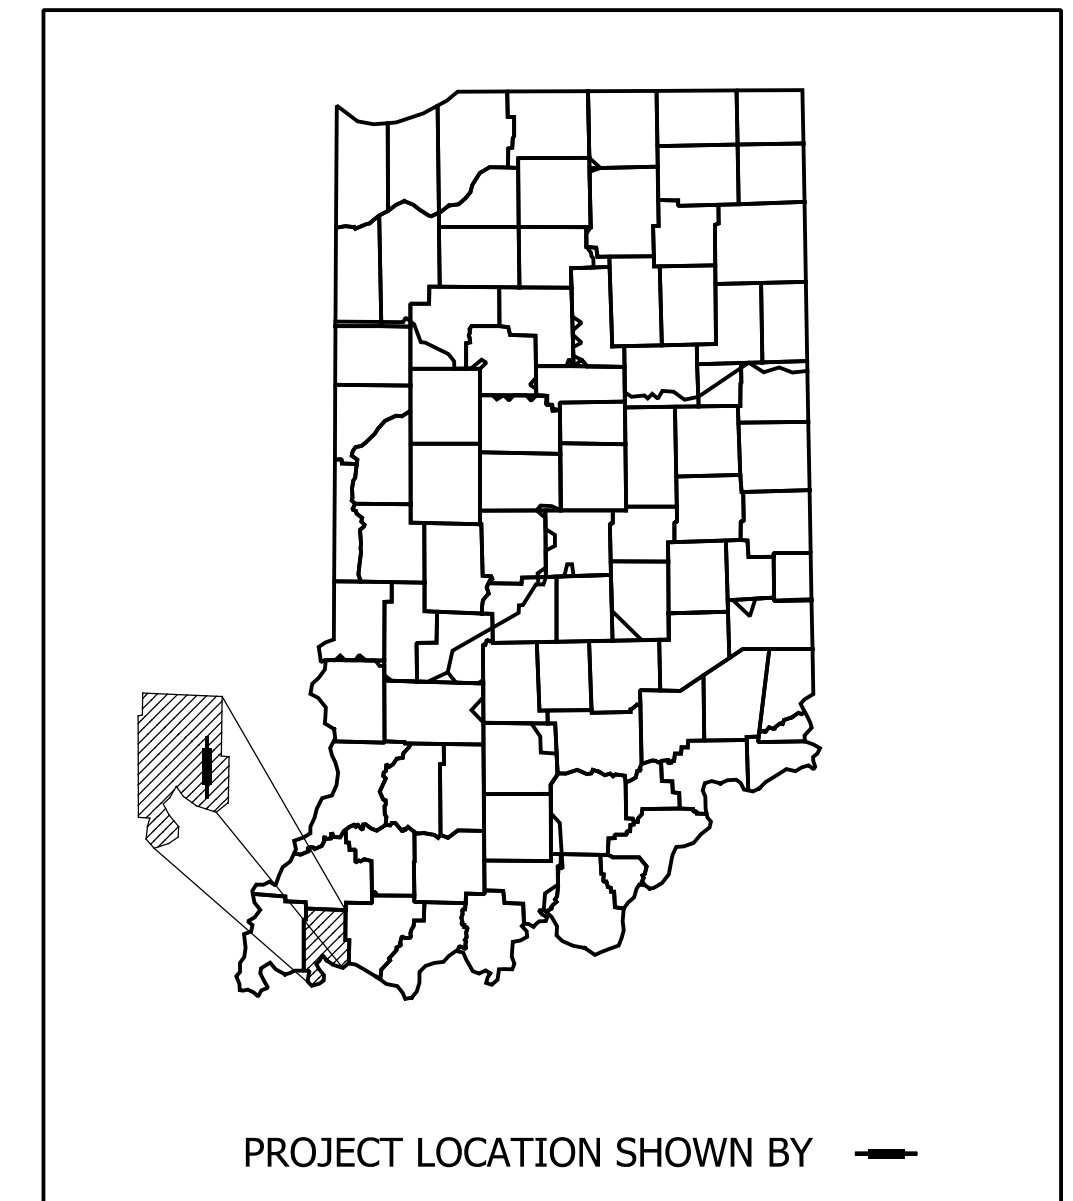

LATITUDE: 38° 01' 14" N LONGITUDE: 87° 30' 38" W

Gross Length: 1.012 MI.
Net Length: 1.012 MI.
NOT FOR CONSTRUCTION

INDIANA DEPARTMENT OF TRANSPORTATION
STANDARD SPECIFICATIONS DATED 2024
TO BE USED WITH THESE PLANS.




9025 RIVER ROAD, SUITE 200
INDIANAPOLIS, IN 46240
TEL 317.547.5580 FAX 317.543.0270
www.structurepoint.com


PLANS PREPARED BY: American Structurepoint, Inc. (317) 547-5580
PHONE NUMBER

CERTIFIED BY: _____ DATE _____


BRIDGE FILE	
N/A	
DESIGNATION	
2002538	
SURVEY BOOK	SHEETS
N/A	1 of 117
CONTRACT	PROJECT
R-43470	2002538

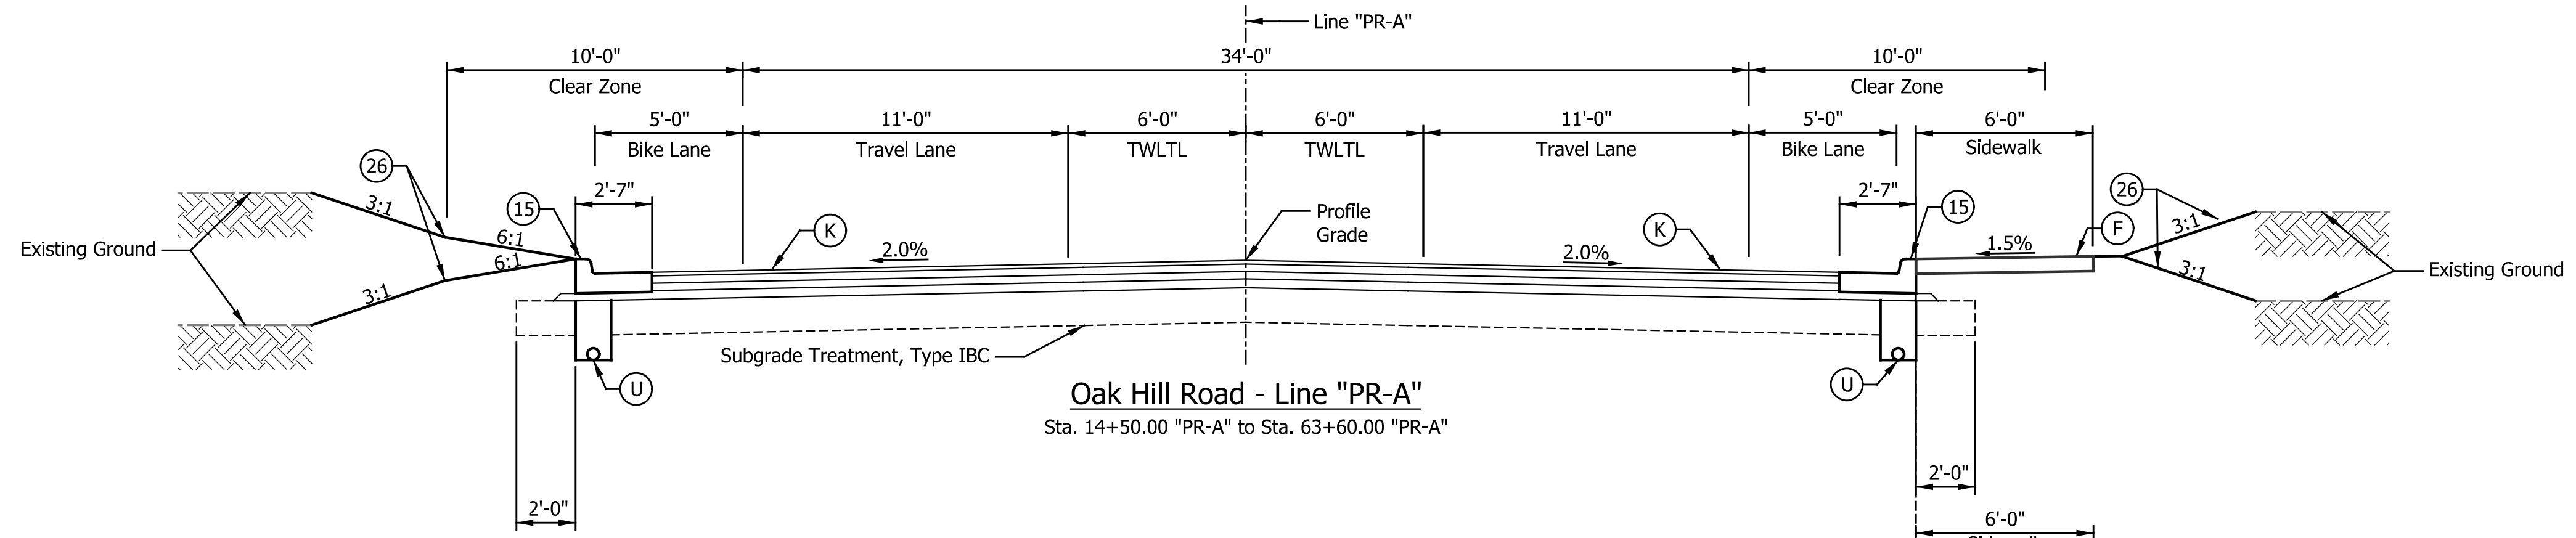

Oak Hill Road - Line "PR-A"
Sta. 14+50.00 "PR-A" to Sta. 63+60.00 "PR-A"

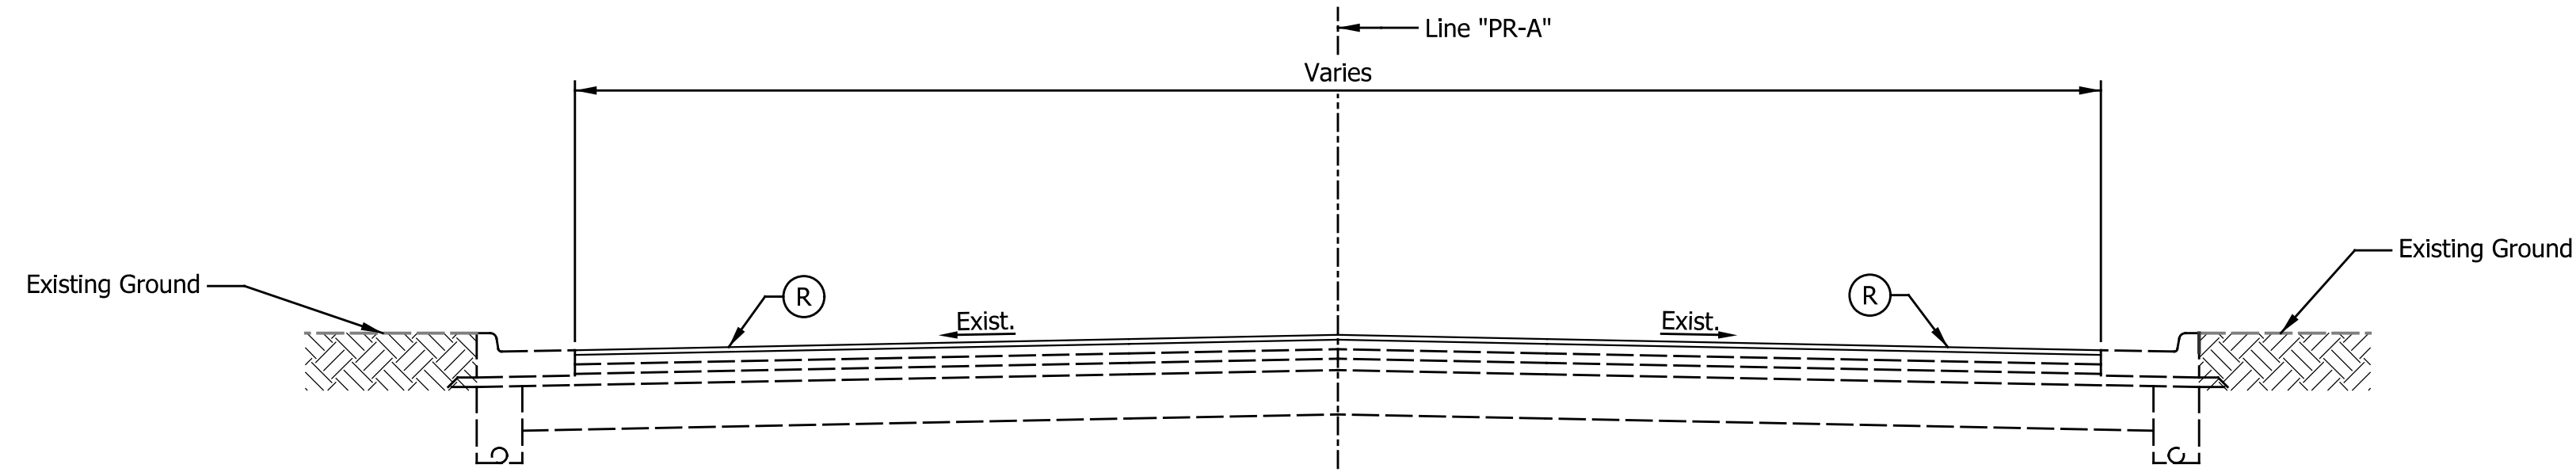


Resurface Section
Sta. 12+55.03 "PR-A" to Sta. 14+50.00 "PR-A"

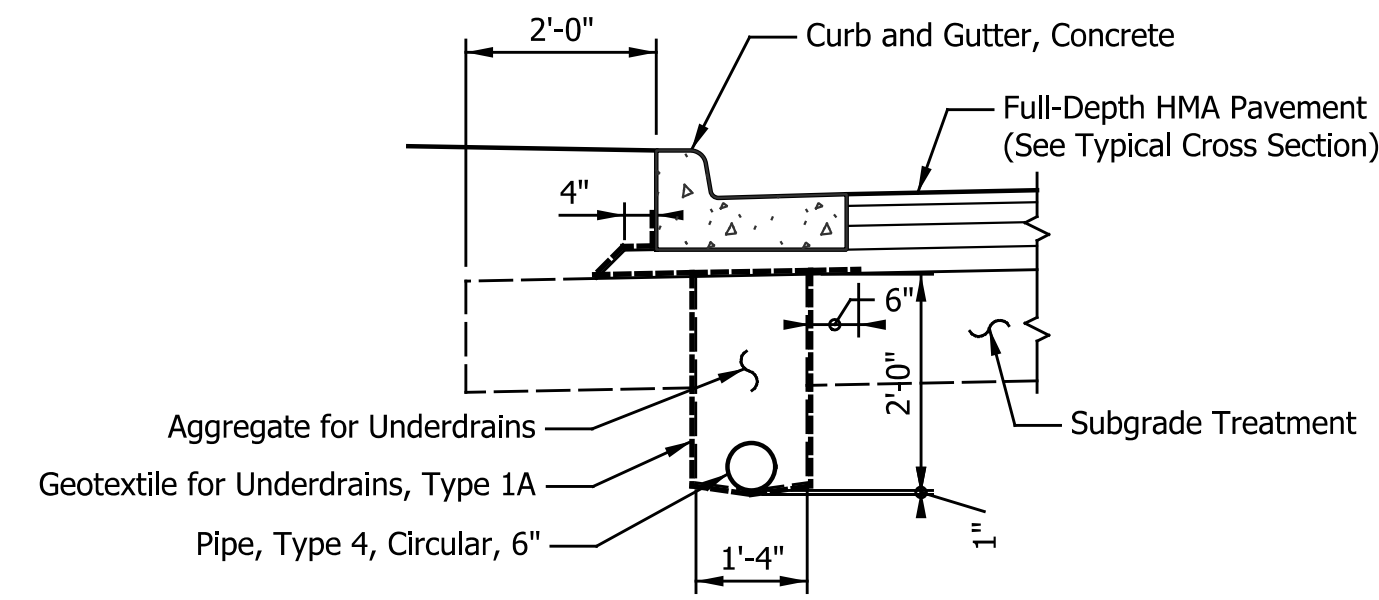

UNDERDRAIN DETAIL - CURB & GUTTER, CONCRETE

Scale: 1/2"=1'-0"

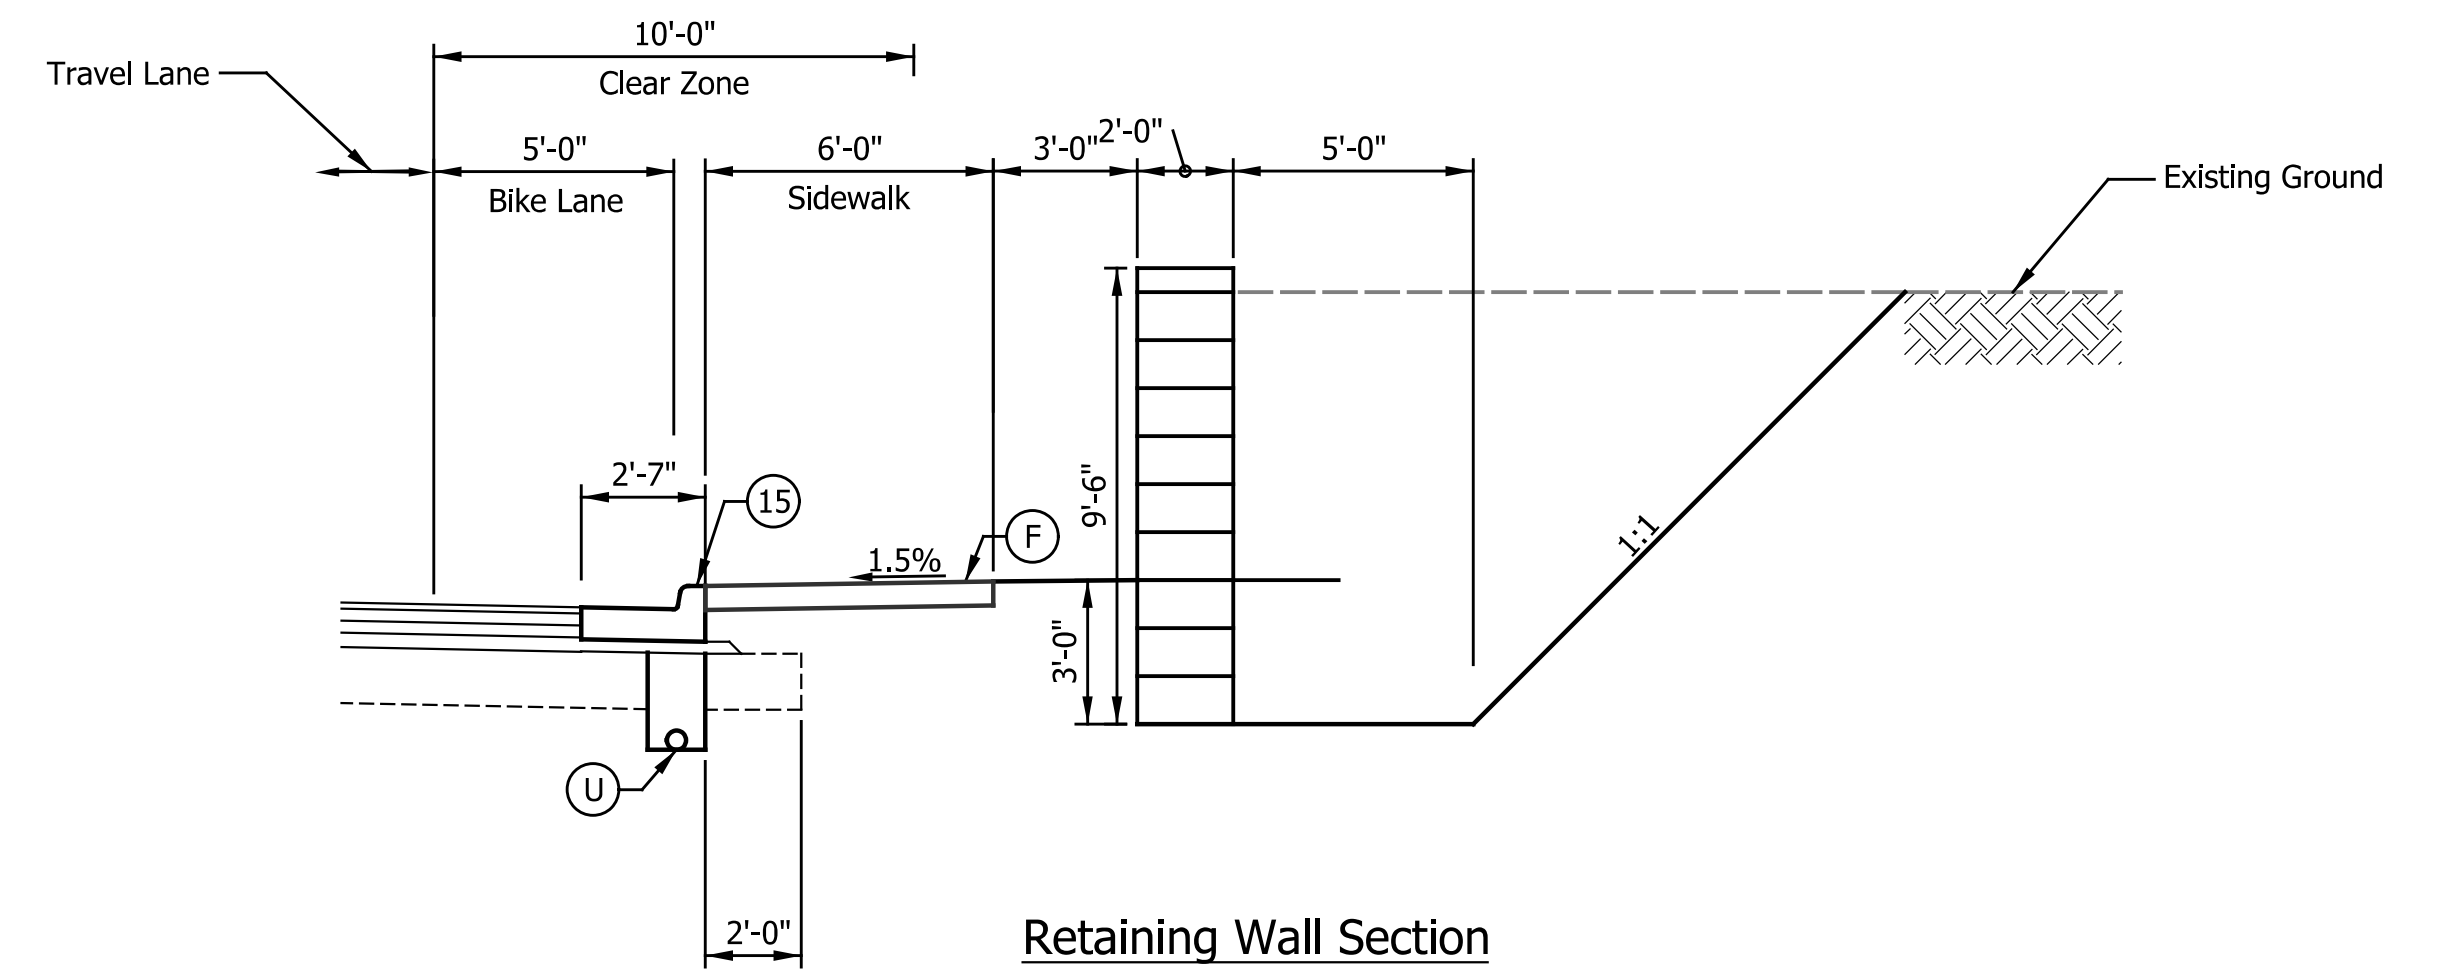

Retaining Wall Section
Sta. 17+00.00 "PR-A" to Sta. 19+00.00 "PR-A"

LEGEND

- (K) 165 #/Syd. QC/QA-HMA, 3, 70, Surface, 9.5 mm, on 330 #/Syd. QC/QA-HMA, 3, 70, Intermediate, 19.0 mm, on 385 #/Syd. QC/QA-HMA, 3, 64, Intermediate, 19.0 mm, on 3" Compacted Aggregate, No. 53
- (K1) 165 #/Syd. QC/QA-HMA, 3, 70, Surface 9.5 mm, on Variable Depth (715 #/Syd. Min.) QC/QA-HMA, 3, 70 Intermediate, 19.0 mm, on 3" Compacted Aggregate, No. 53
- (R) Milling, Transition, Then 165 #/Syd. QC/QA-HMA, 3, 70, Surface, 9.5 mm
- (F) Concrete Sidewalk, 4"
- (U) 6" Underdrain
- (15) Curb and Gutter, Concrete
- (26) Sodding, Nursery

DATE	REVISION

RECOMMENDED FOR APPROVAL _____	DESIGN ENGINEER _____	DATE _____
DESIGNED: _____ JAB _____	DRAWN: _____ JAB _____	
CHECKED: _____ TMS _____	CHECKED: _____ TMS _____	


INDIANA DEPARTMENT OF TRANSPORTATION	
TYPICAL CROSS SECTIONS	
LINE "PR-A"	

HORIZONTAL SCALE	BRIDGE FILE
1/4" = 1'-0"	N/A
VERTICAL SCALE	DESIGNATION
1/4" = 1'-0"	2002538
SURVEY BOOK	SHEETS
N/A	3 of 117
CONTRACT	PROJECT
R-43470	2002538

15

20

25

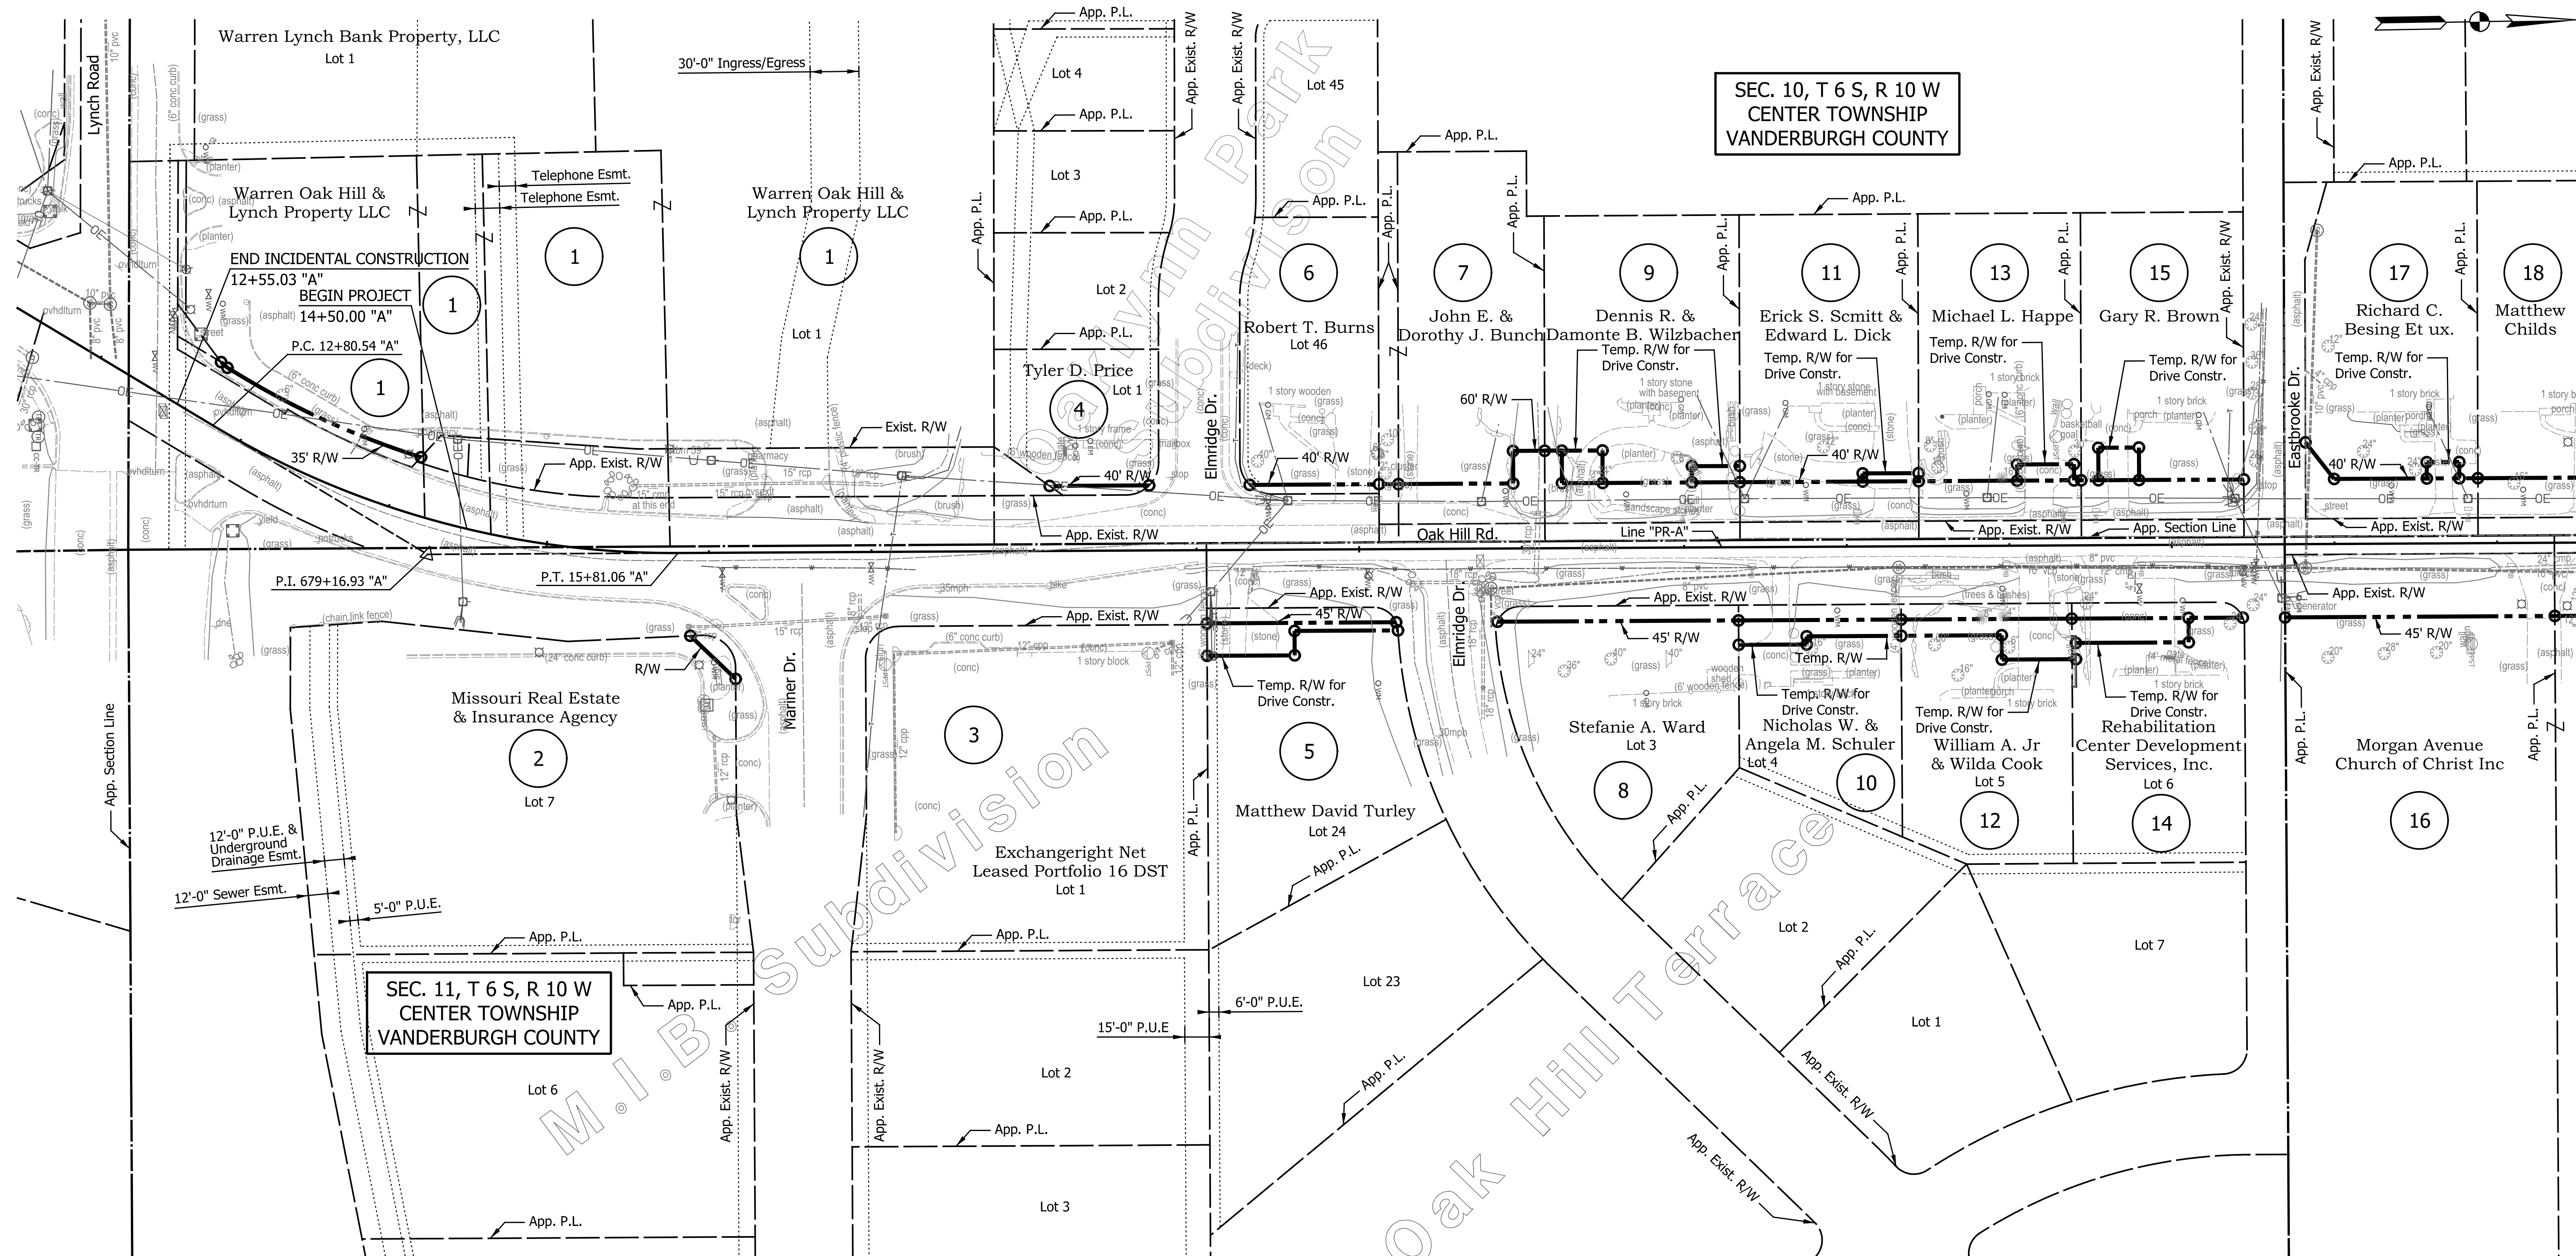

DATE	REVISION

RECOMMENDED FOR APPROVAL	DESIGN ENGINEER	DATE
DESIGNED: JKH	DRAWN: BLP	
CHECKED: DSS	CHECKED: DSS	



VANDERBURGH COUNTY DEPARTMENT OF ENGINEERING	
PLAT NO. 1 OAK HILL ROAD	

HORIZONTAL SCALE	BRIDGE FILE
1" = 50'	N/A
VERTICAL SCALE	DESIGNATION
N/A	2002538
SURVEY BOOK	SHEETS
N/A	4 of 117
CONTRACT	PROJECT
VCXX-XX-XX	N/A

30

35

40

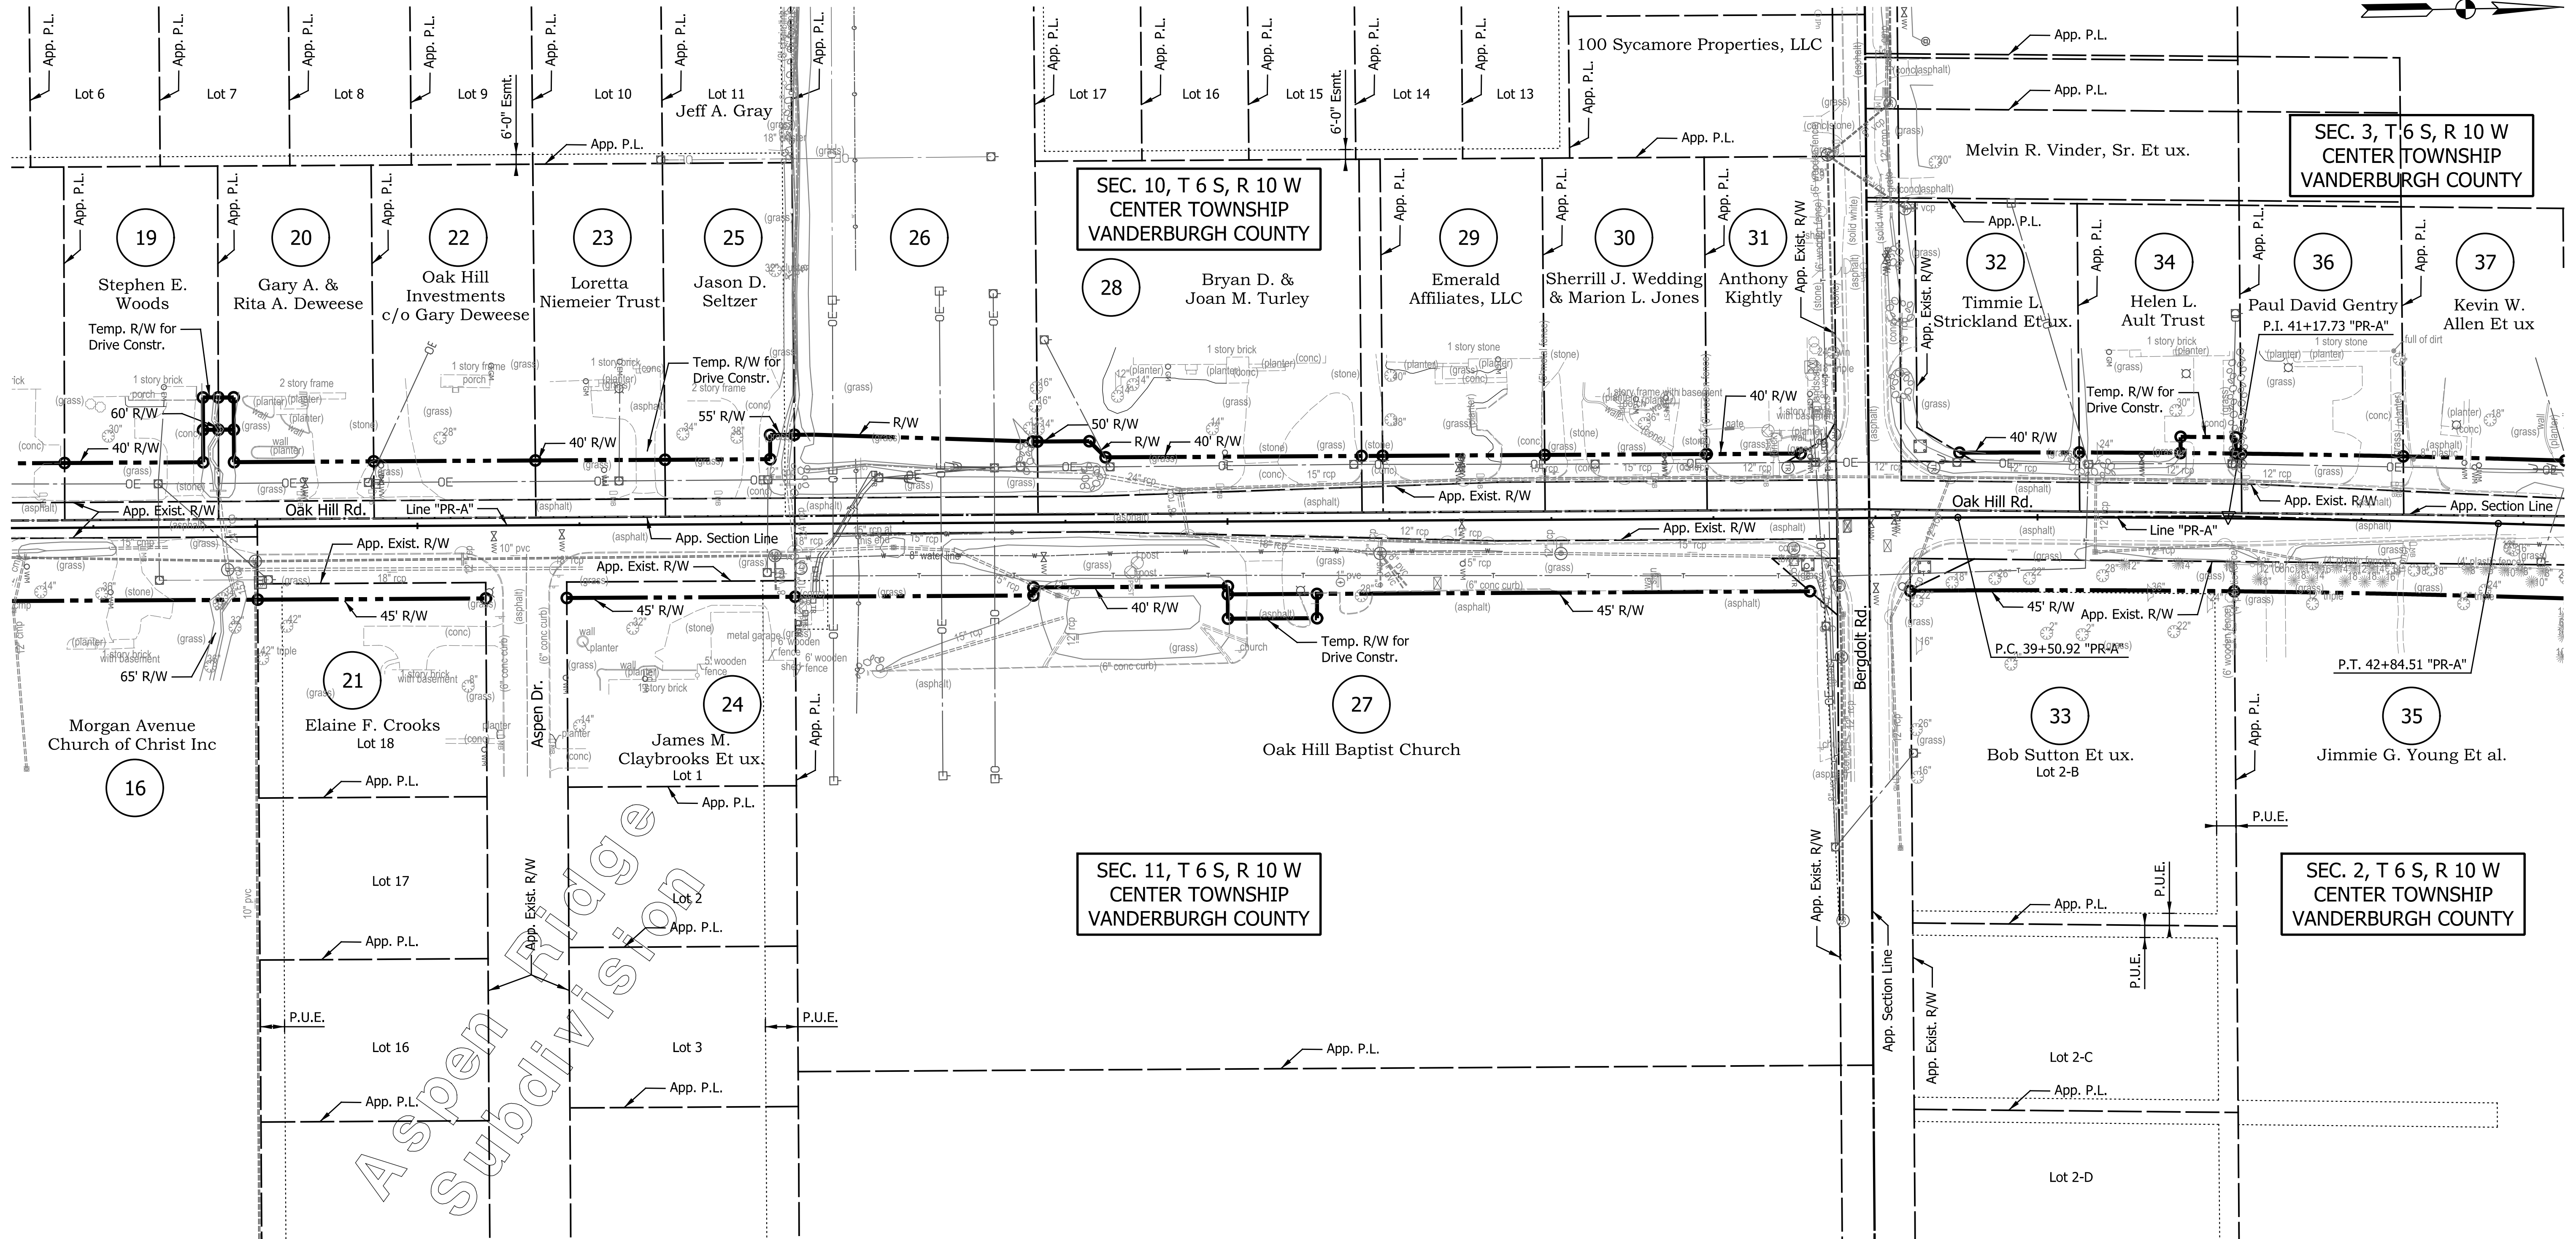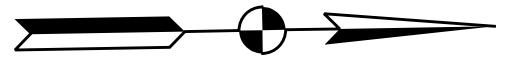

Aspen Ridge
Subdivision


DATE	REVISION

RECOMMENDED FOR APPROVAL	DESIGN ENGINEER	DATE
DESIGNED: JKH	DRAWN: BLP	
CHECKED: DSS	CHECKED: DSS	

**VANDERBURGH COUNTY
DEPARTMENT OF ENGINEERING**

**PLAT. NO. 1
OAK HILL ROAD**

HORIZONTAL SCALE	BRIDGE FILE
1" = 50'	N/A
VERTICAL SCALE	DESIGNATION
N/A	2002538
SURVEY BOOK	SHEETS
N/A	5 of 117
CONTRACT	PROJECT
VCXX-XX-XX	N/A

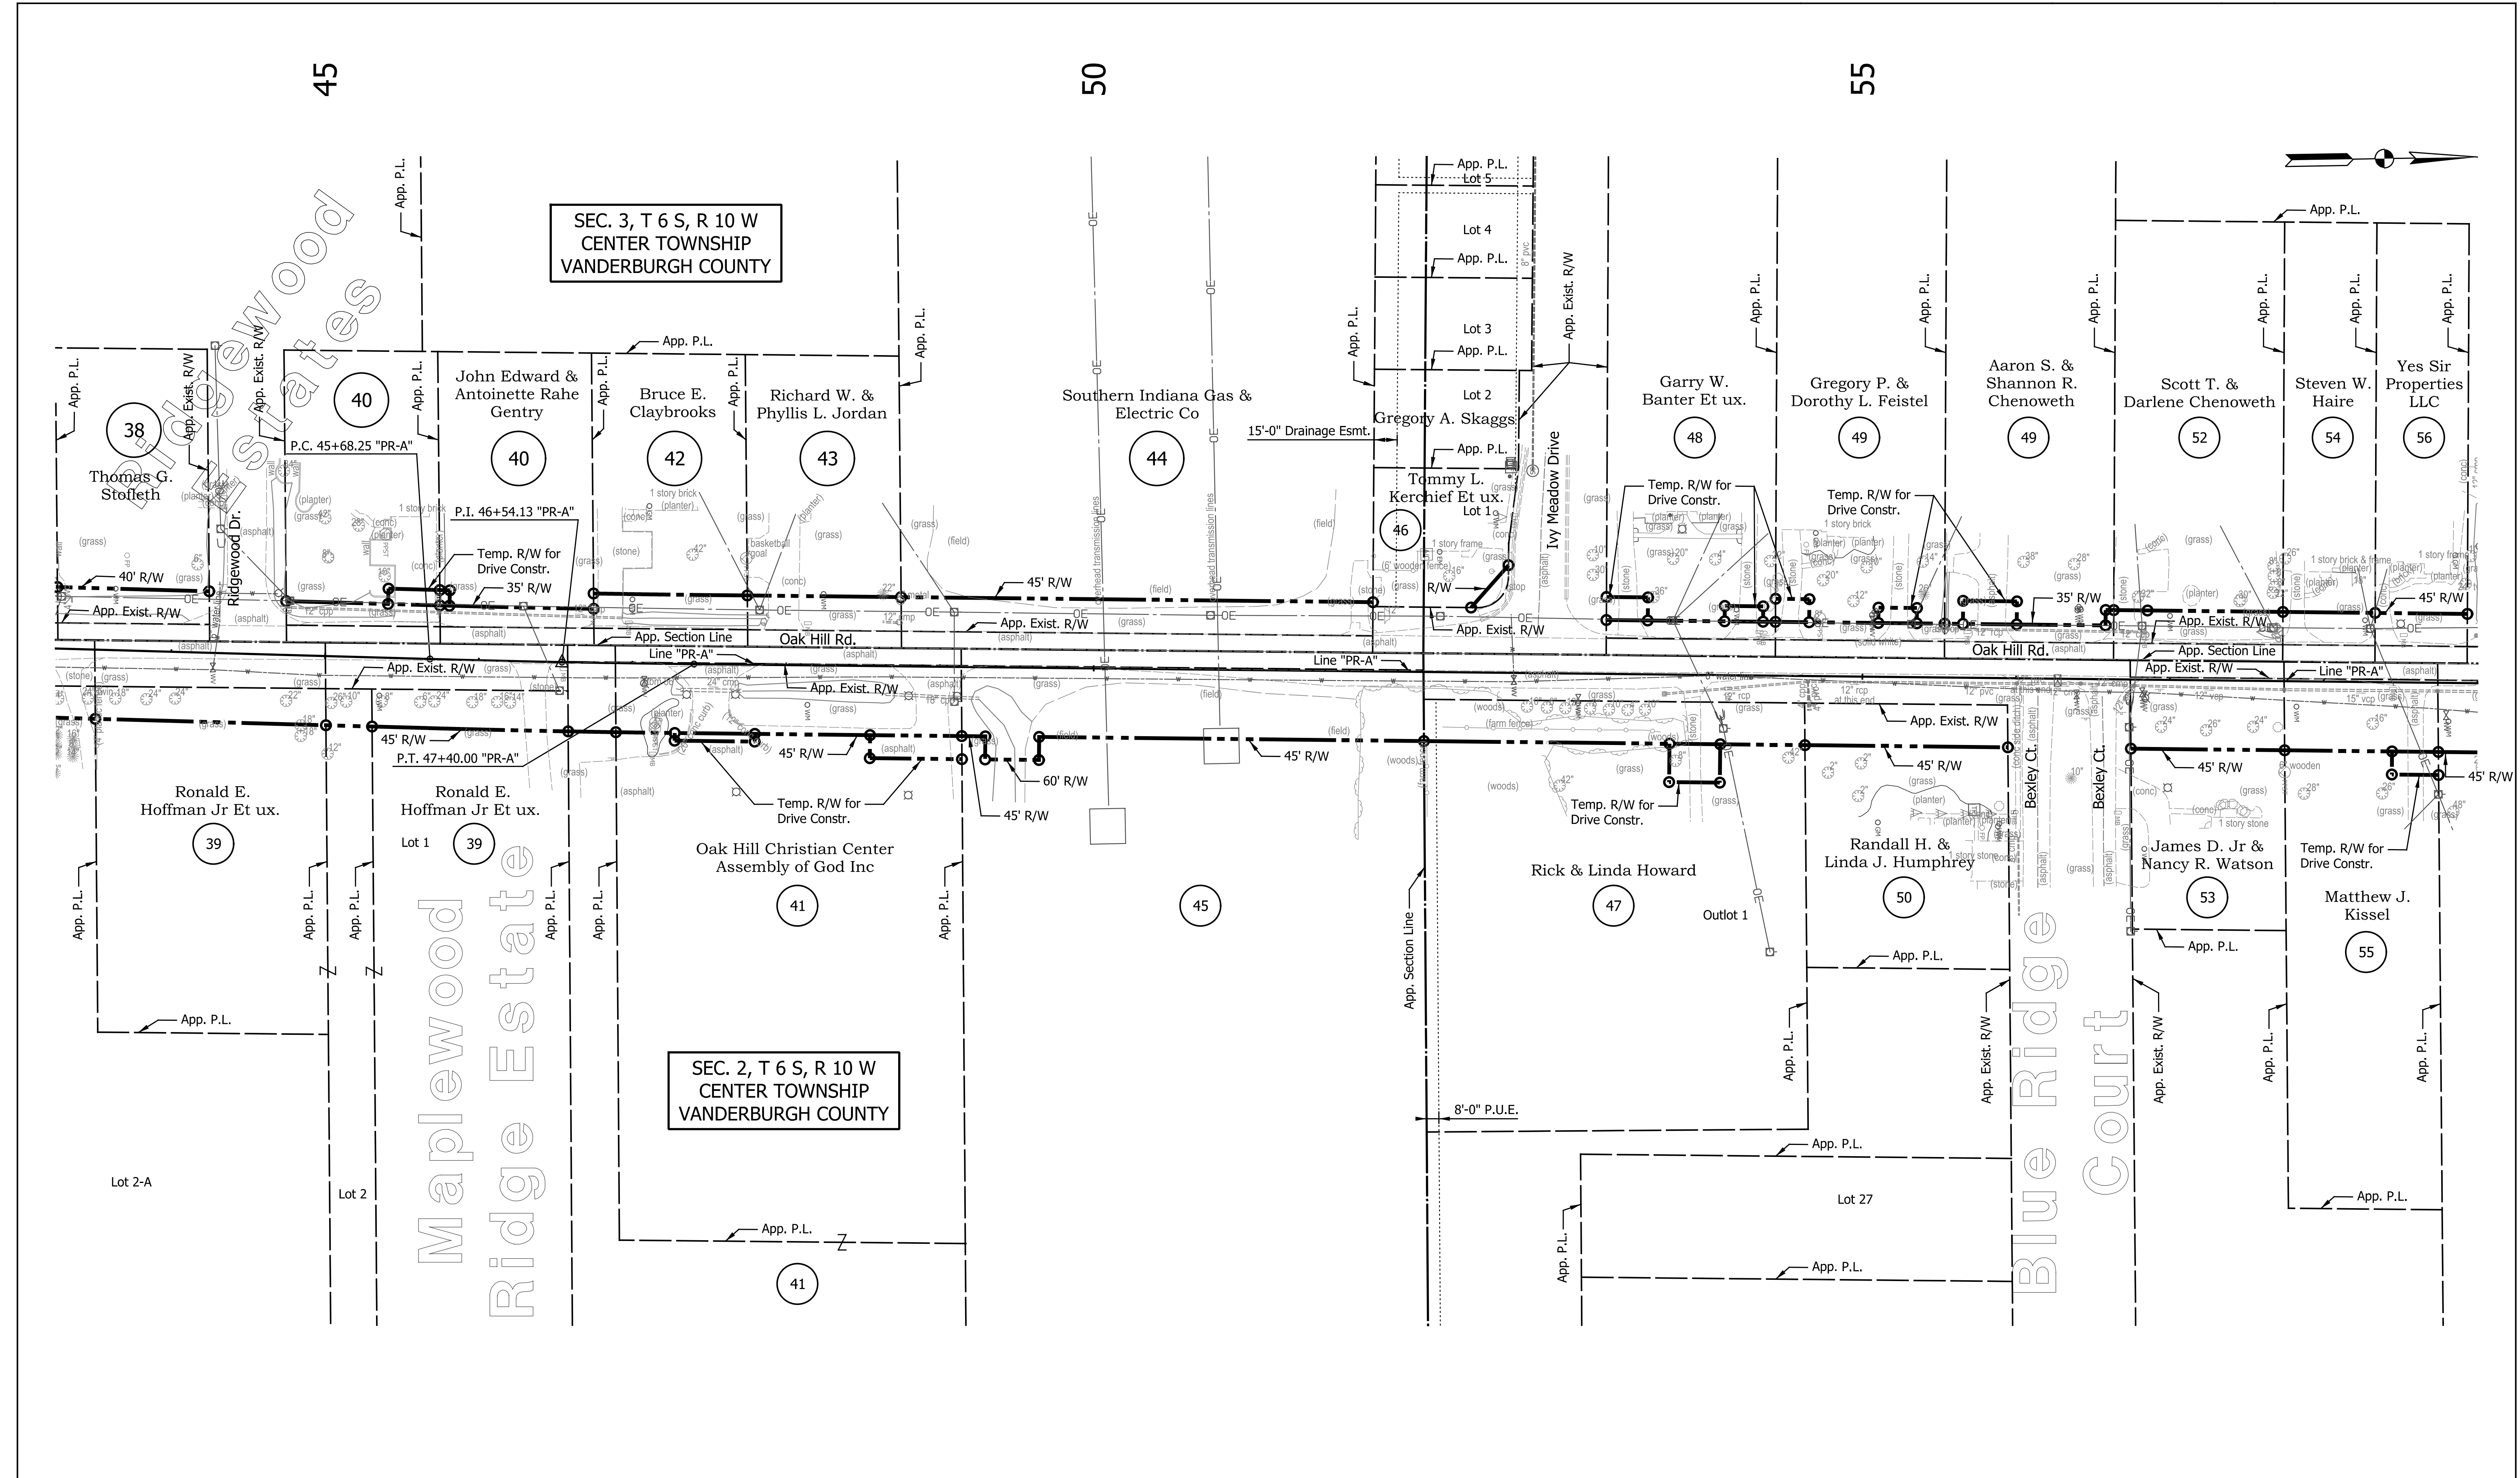

SEC. 3, T 6 S, R 10 W
CENTER TOWNSHIP
VANDERBURGH COUNTY

SEC. 2, T 6 S, R 10 W
CENTER TOWNSHIP
VANDERBURGH COUNTY

Maplewood
Ridge Estate

Blue Ridge
Court

DATE	REVISION

RECOMMENDED FOR APPROVAL	DESIGN ENGINEER	DATE
DESIGNED: JKH	DRAWN: BLP	
CHECKED: DSS	CHECKED: DSS	

VANDERBURGH COUNTY
DEPARTMENT OF ENGINEERING


PLAT NO. 1
OAK HILL ROAD

HORIZONTAL SCALE	BRIDGE FILE
1" = 50'	N/A
VERTICAL SCALE	DESIGNATION
N/A	2002538
SURVEY BOOK	SHEETS
N/A	6 of 117
CONTRACT	PROJECT
VCXX-XX-XX	N/A

60


65

70

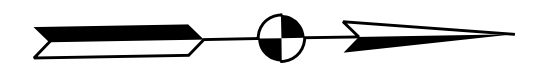

SEC. 3, T 6 S, R 10 W
CENTER TOWNSHIP
VANDERBURGH COUNTY

SEC. 2, T 6 S, R 10 W
CENTER TOWNSHIP
VANDERBURGH COUNTY

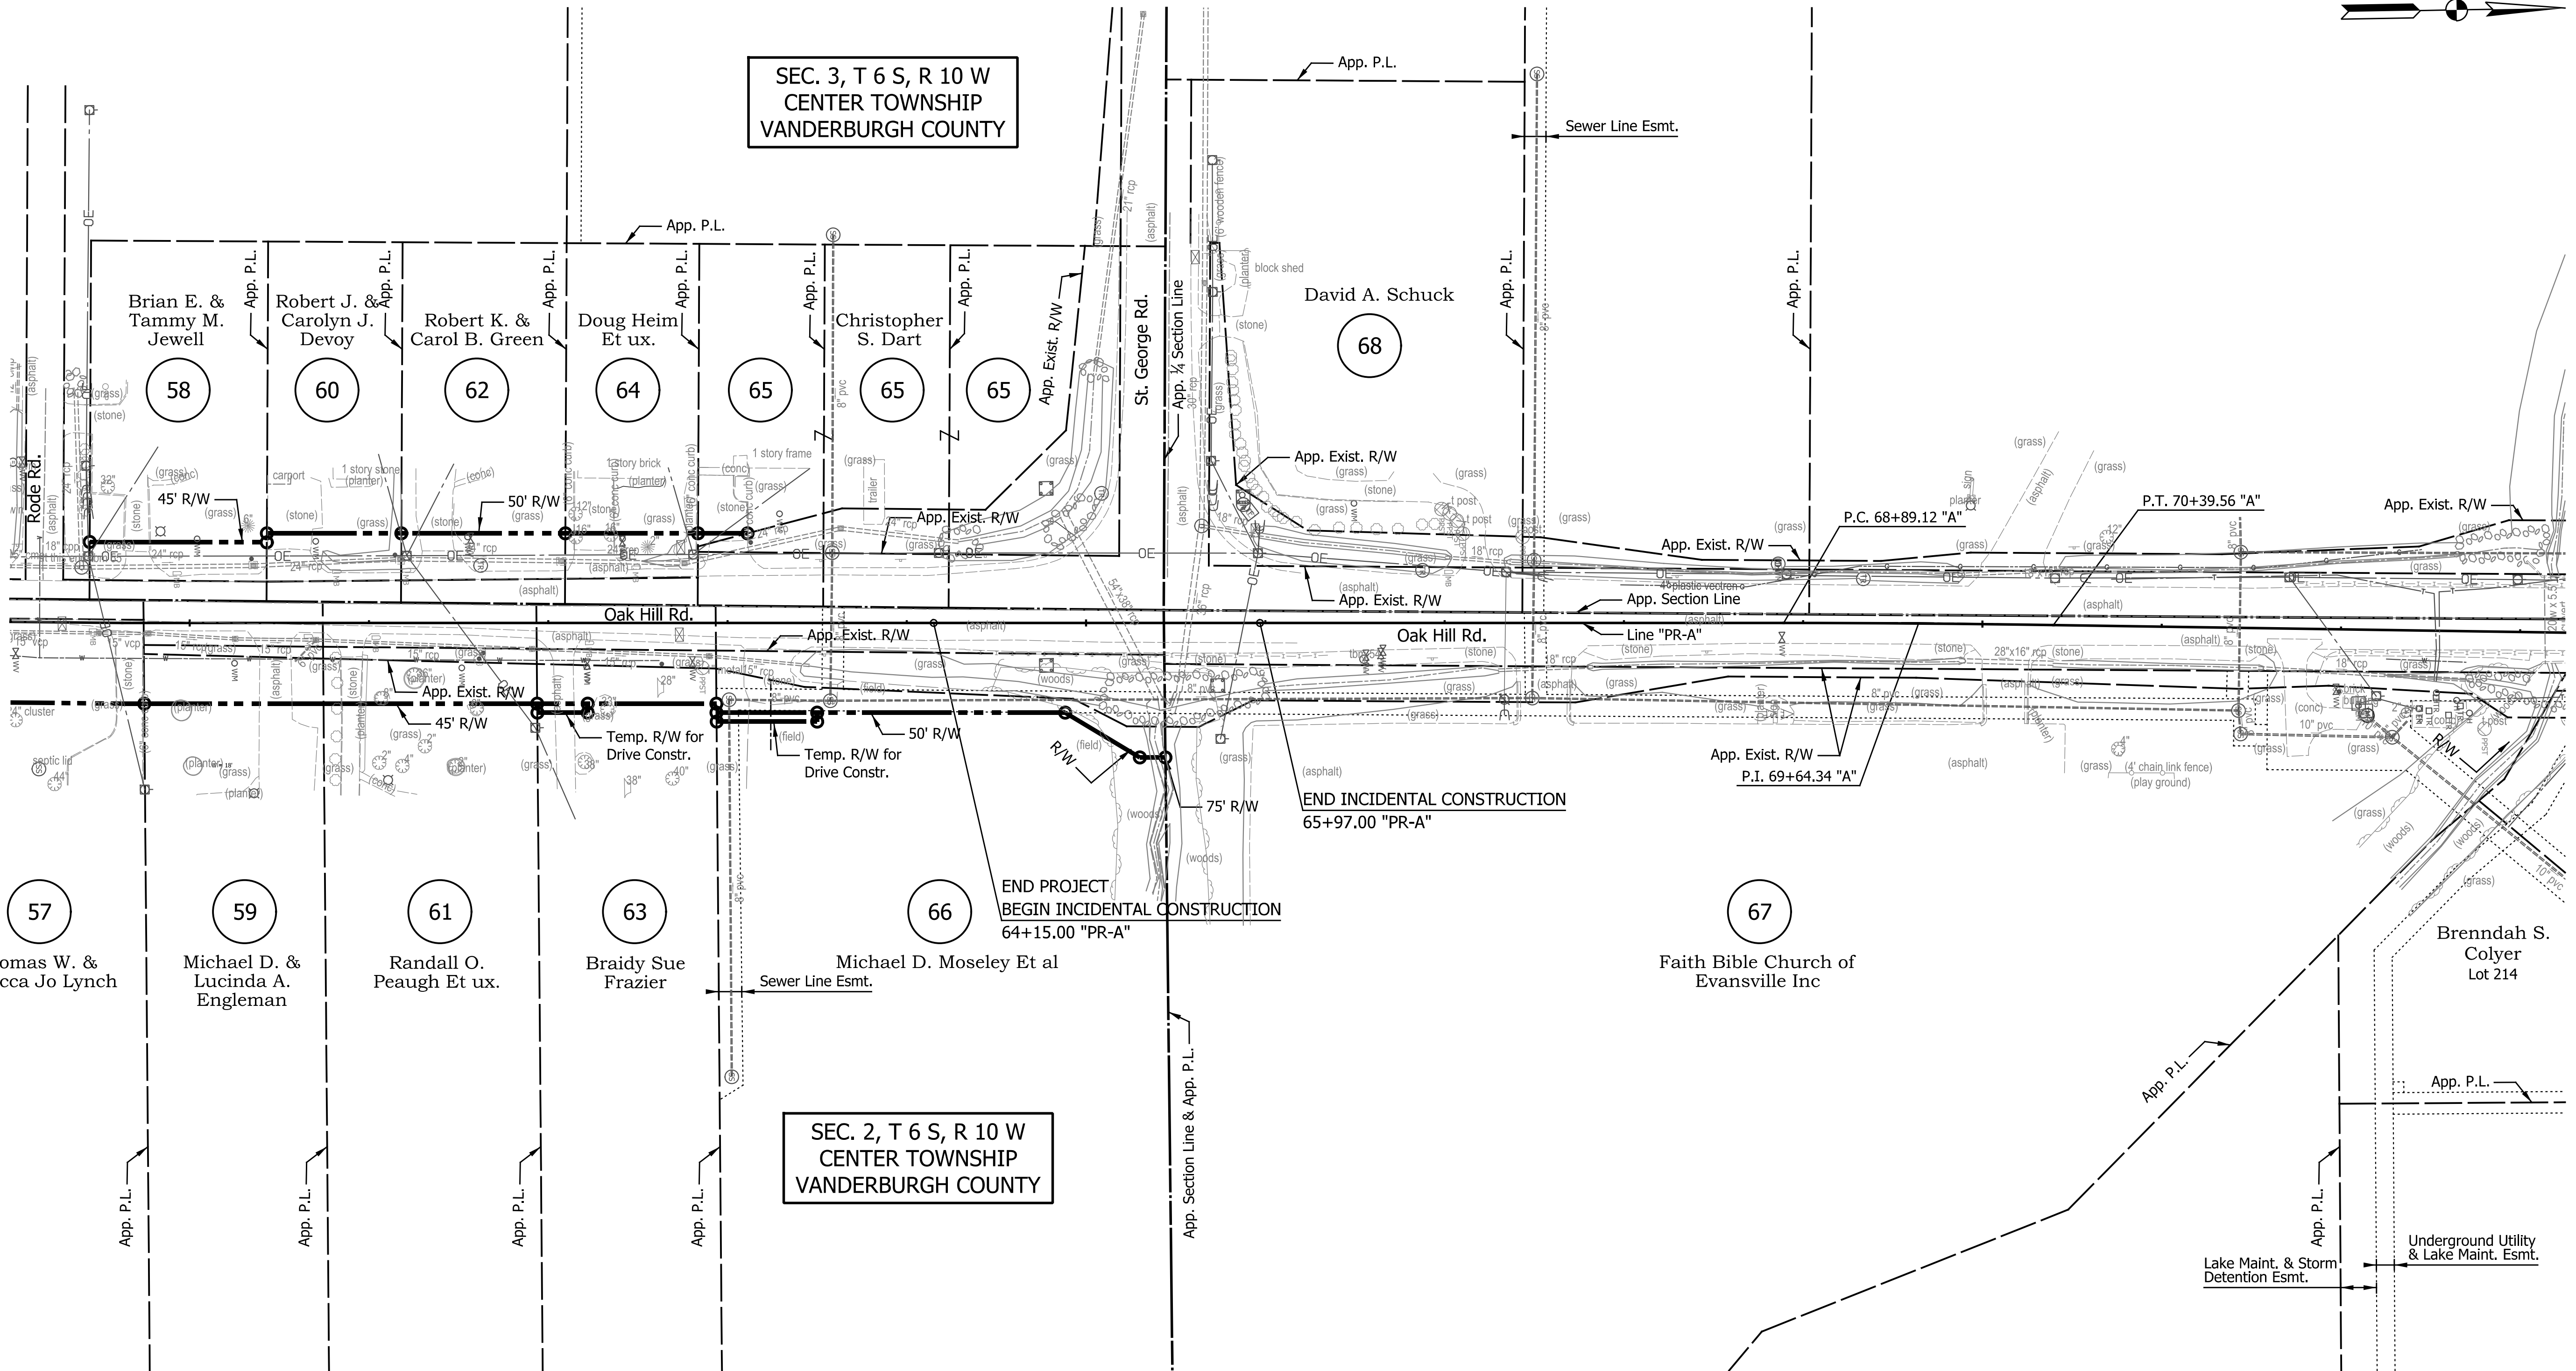

Note:
Work North of Incidental Construction
to be Completed in Phase 1.



DATE	REVISION

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DESIGNED: _____ JKH _____	DRAWN: _____ BLP _____	
CHECKED: _____ DSS _____	CHECKED: _____ DSS _____	

VANDERBURGH COUNTY
DEPARTMENT OF ENGINEERING

PLAT NO. 1
OAK HILL ROAD

HORIZONTAL SCALE	BRIDGE FILE
1" = 50'	N/A
VERTICAL SCALE	DESIGNATION
N/A	2002538
SURVEY BOOK	SHEETS
N/A	7 of 117
CONTRACT	PROJECT
VCXX-XX-XX	N/A

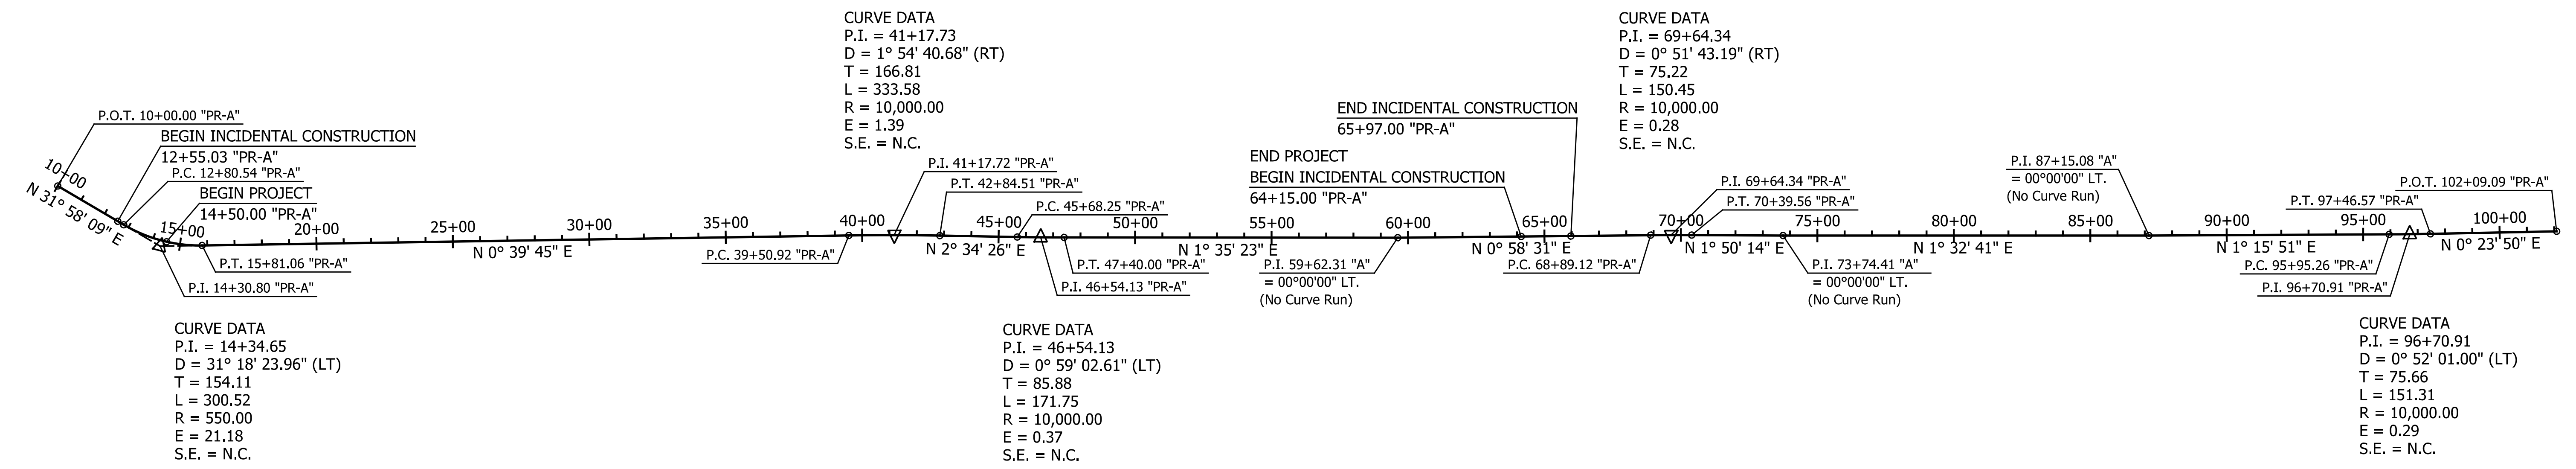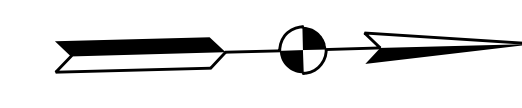

CHAIN	STATION	NORTHING	EASTING
"PR-A"	P.O.T. 10+00.00	195,574.3307	798,551.0743
	P.C. 12+80.54	195,812.3219	798,699.6097
	P.I. 14+34.65	195,943.0626	798,781.2077
	P.T. 15+81.06	196,097.167	798,782.9897
	P.C. 39+50.92	198,466.87	798,810.3914
	P.I. 41+17.73	198,633.6667	798,812.3201
	P.T. 42+84.51	198,800.3062	798,819.8109
	P.C. 45+68.25	199,083.766	798,832.5528
	P.I. 46+54.13	199,169.5568	798,836.4093
	P.T. 47+40.00	199,255.4011	798,838.7917
	P.O.T. 59+62.31	200,477.2328	798,872.7017
	P.C. 68+89.12	201,403.9069	798,888.4764
	P.I. 69+64.34	201,479.1208	798,889.7567
	P.T. 70+39.56	201,554.3069	798,892.1685
	P.O.T. 73+74.41	201,888.9801	798,902.9038
	P.O.T. 87+15.08	203,229.1622	798,939.0461
	P.C. 95+95.26	204,109.128	798,958.4628
	P.I. 96+70.91	204,184.7662	798,960.1317
	P.T. 97+46.57	204,260.4211	798,960.6561
	P.O.T. 102+09.09	204,722.9346	798,963.8616

DATE	REVISION

RECOMMENDED FOR APPROVAL _____
 DESIGN ENGINEER _____ DATE _____

DESIGNED: _____ JKH _____ DRAWN: _____ BLP _____





















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INDIANA DEPARTMENT OF TRANSPORTATION

GEOMETRIC TIE-UP DETAILS

HORIZONTAL SCALE 1" = 300'	BRIDGE FILE N/A
VERTICAL SCALE N/A	DESIGNATION 2002538
SURVEY BOOK N/A	SHEETS 8 of 117
CONTRACT R-43470	PROJECT 2002538

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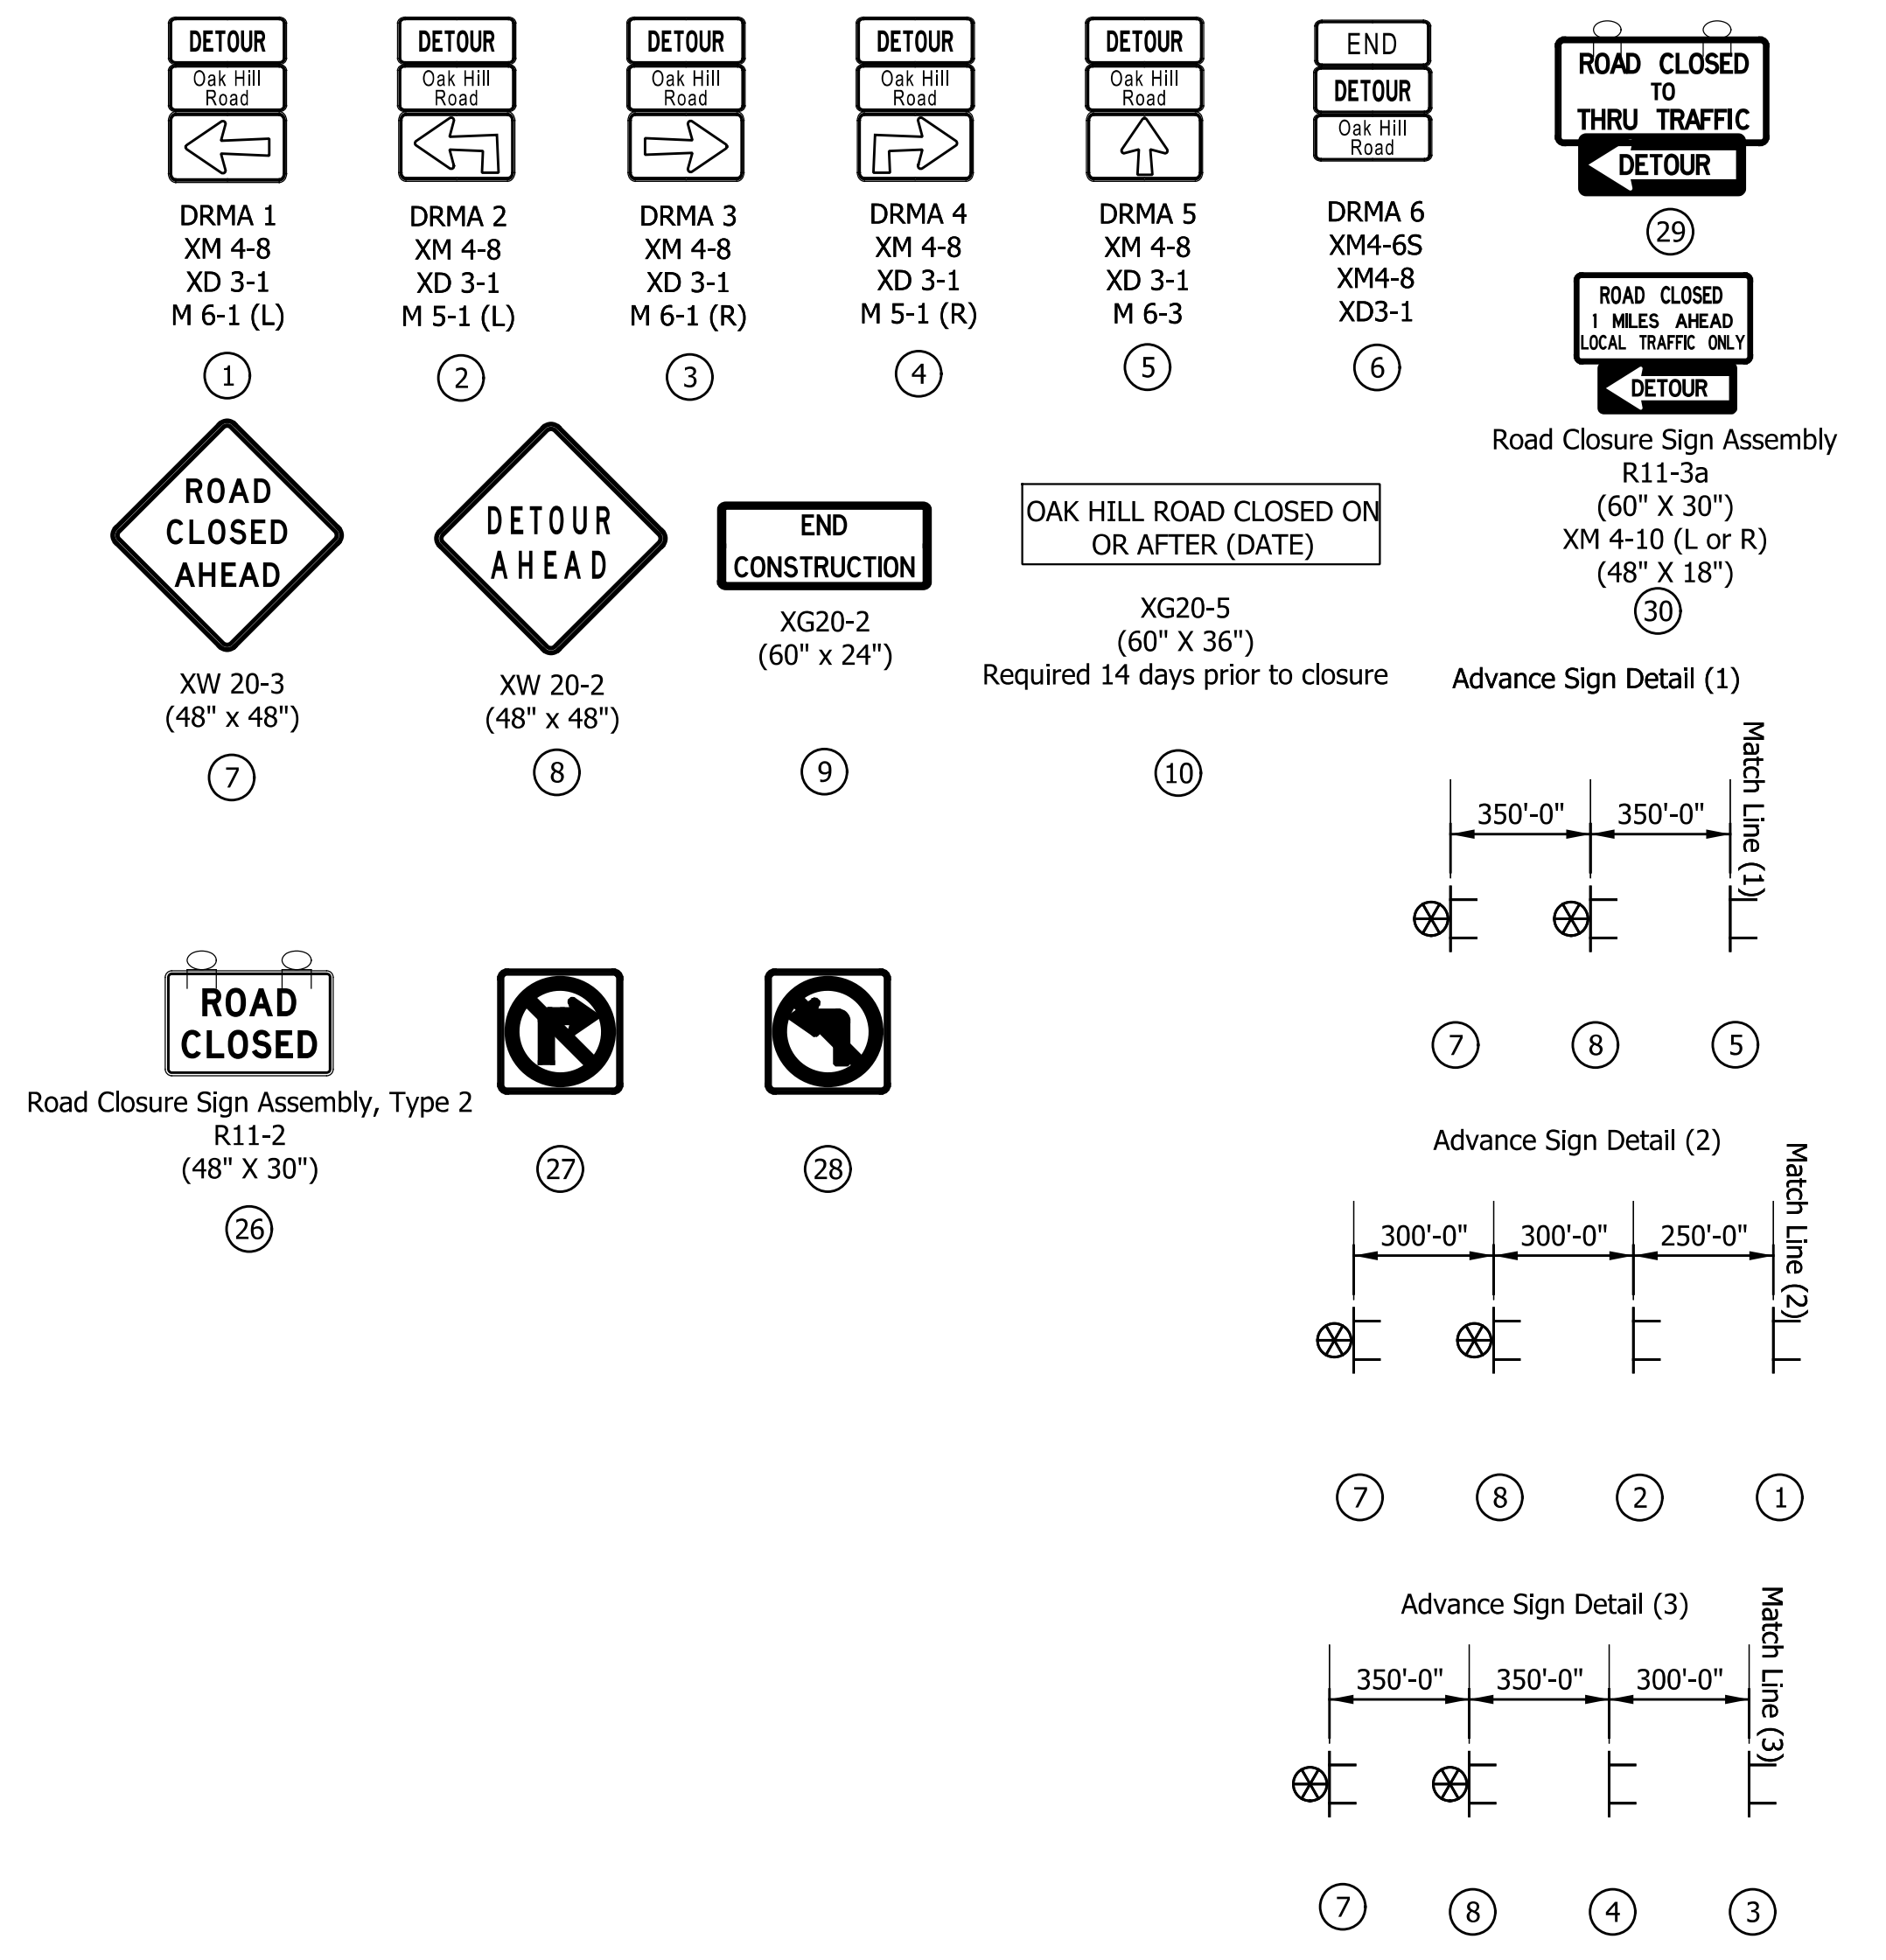
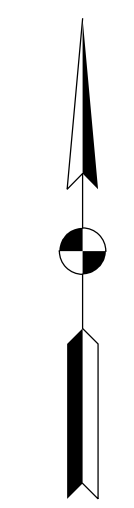
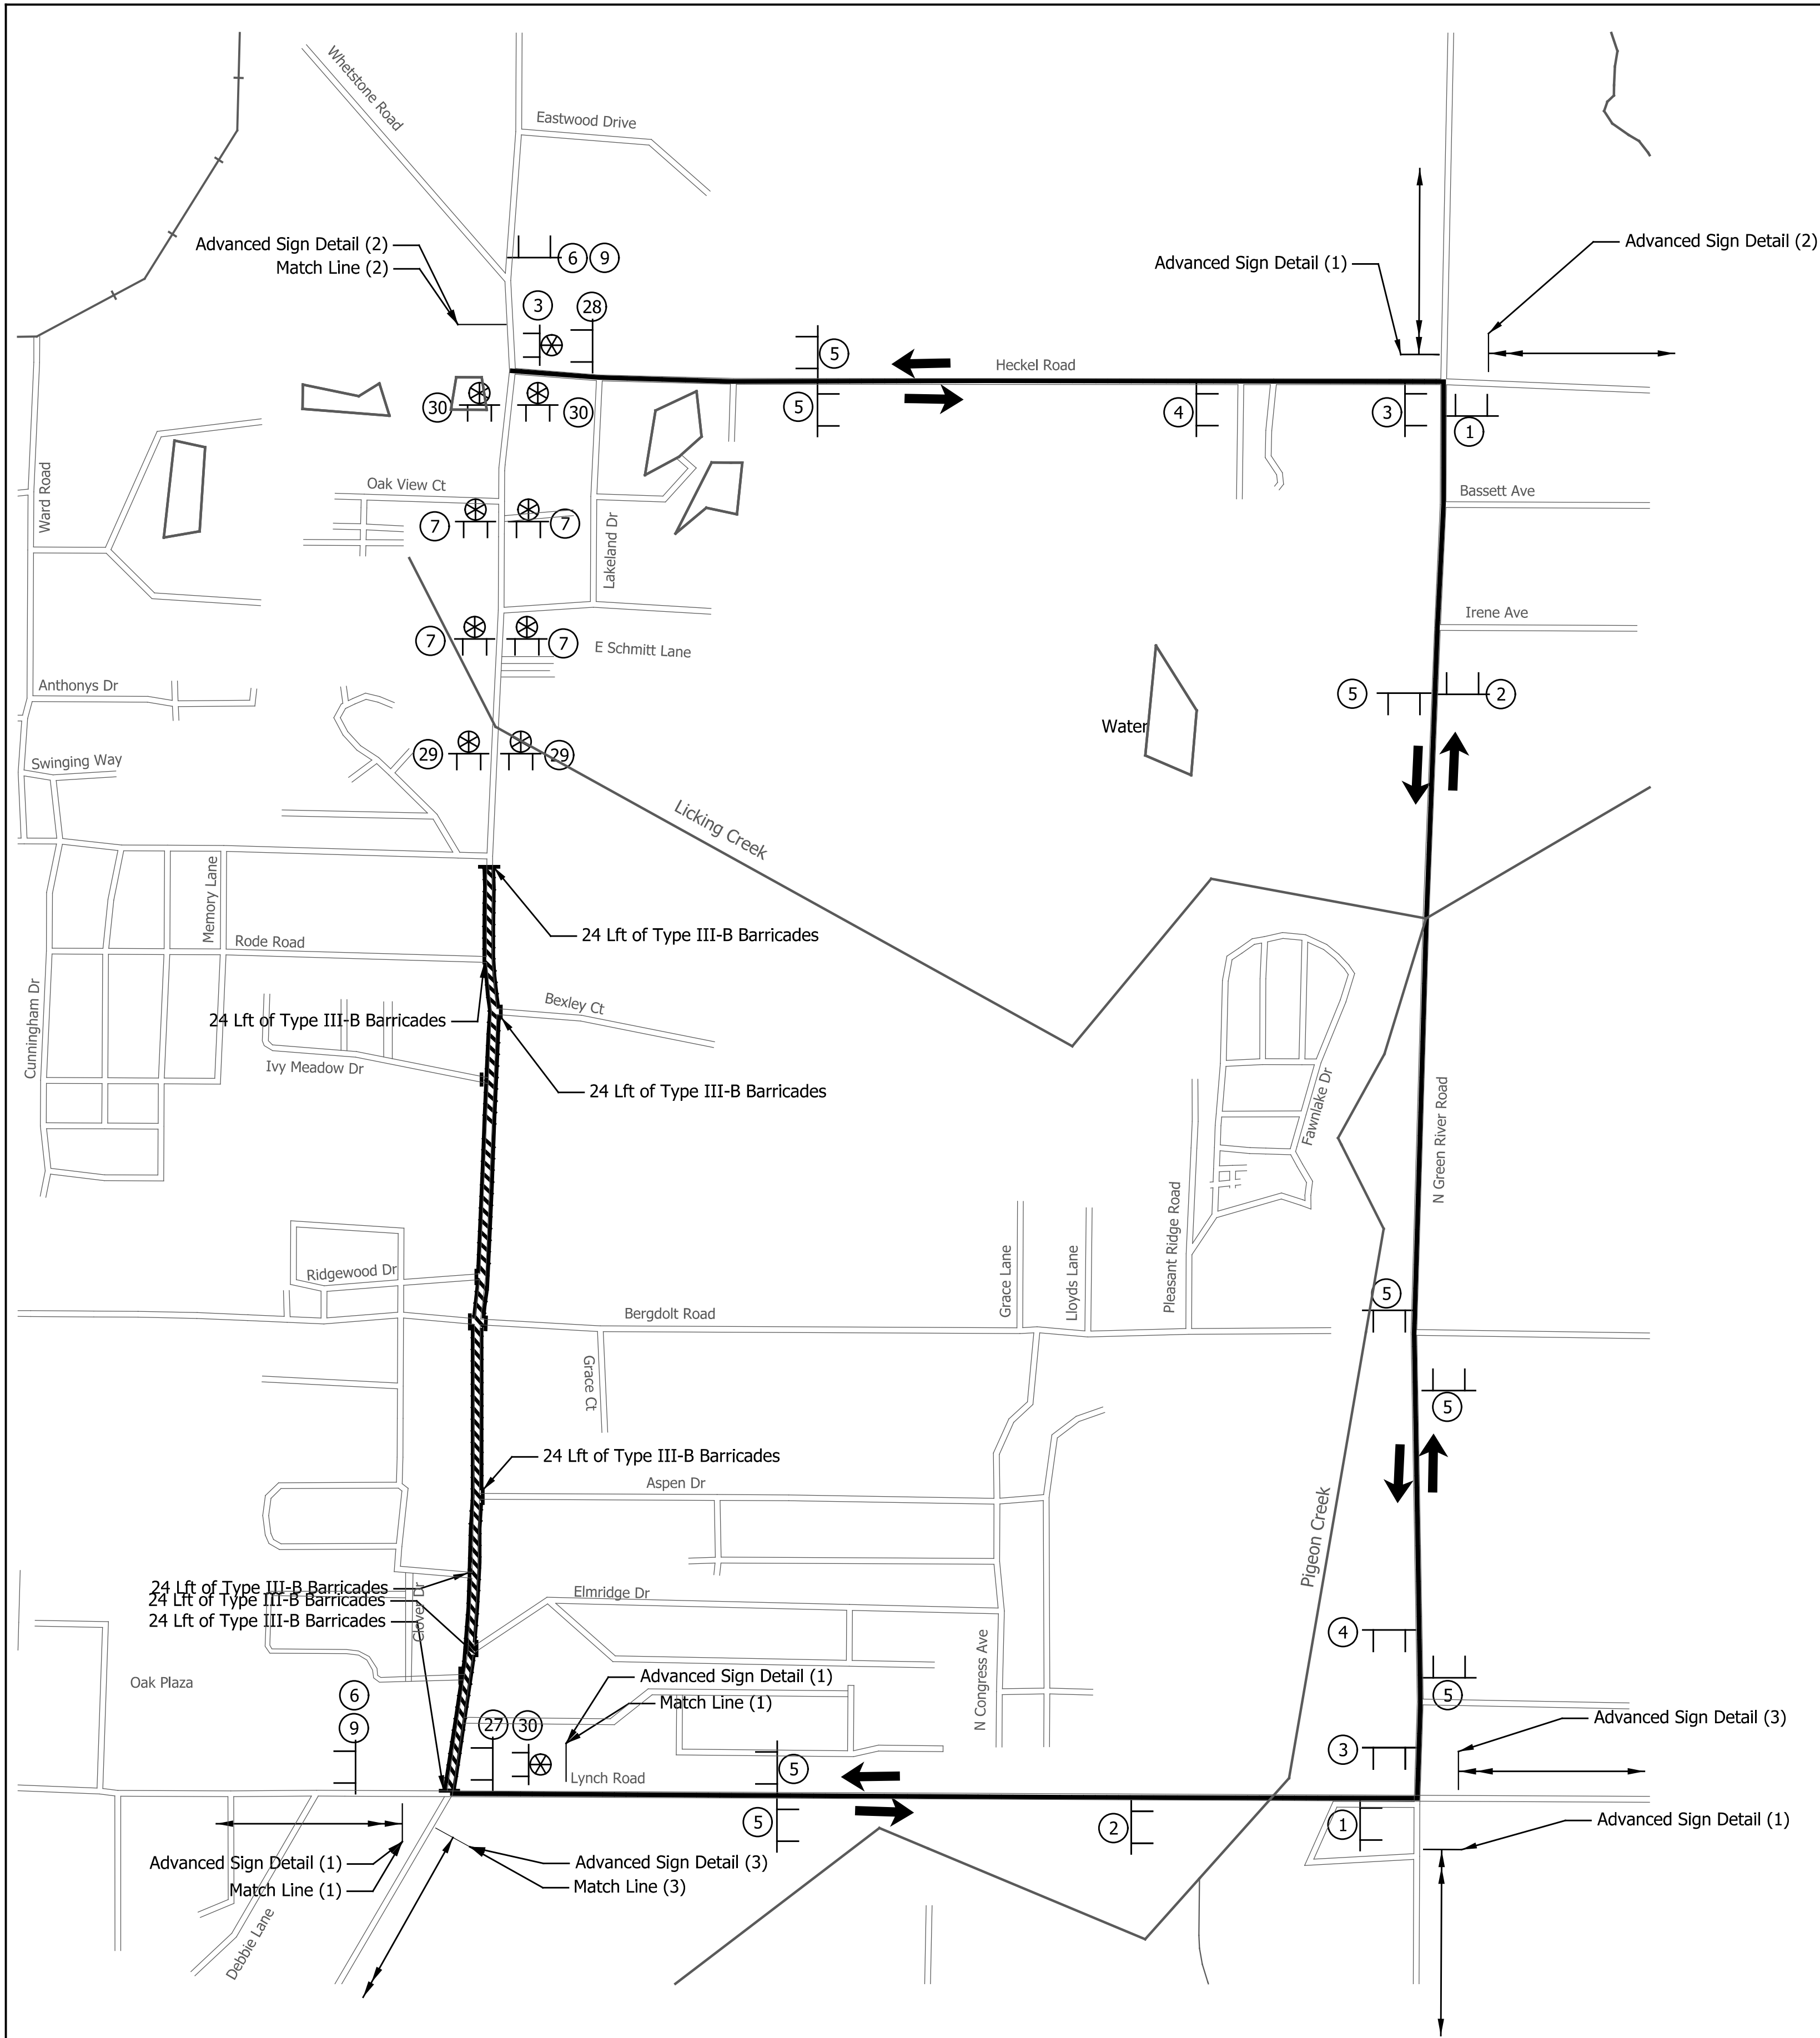


DATE	REVISION

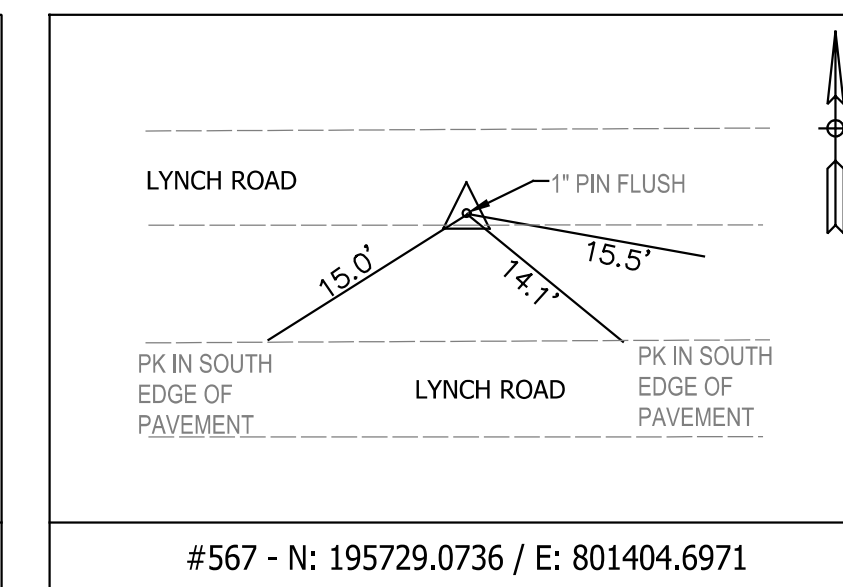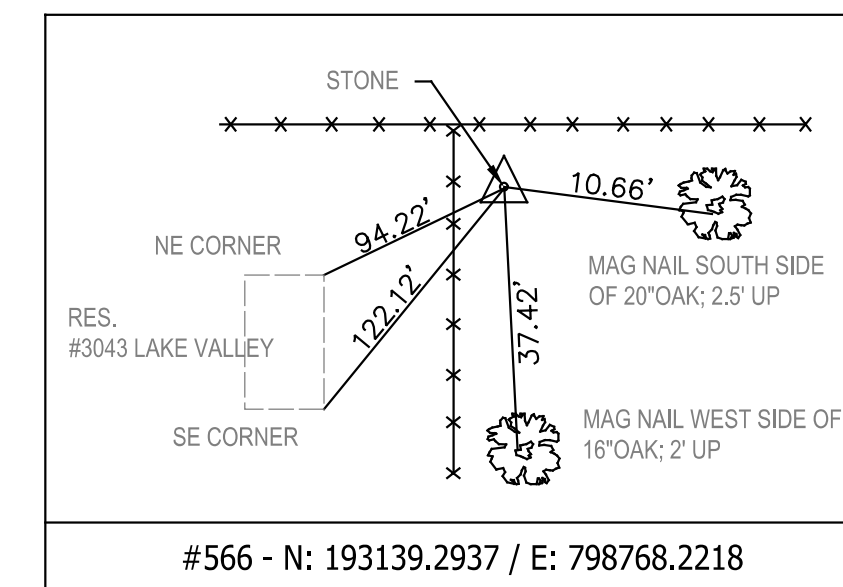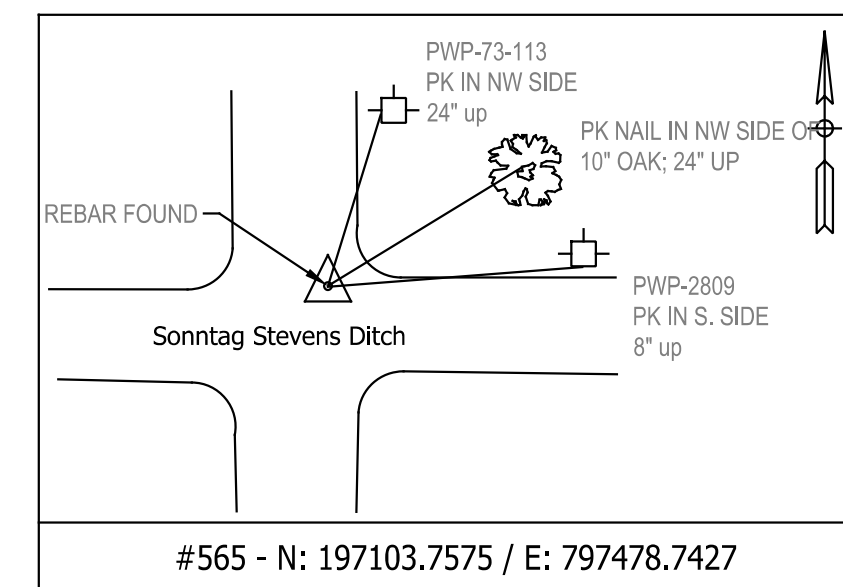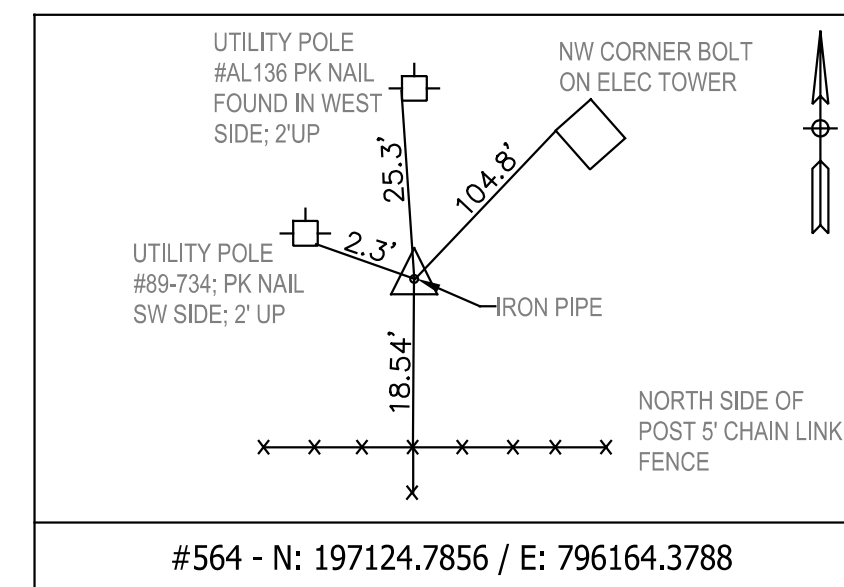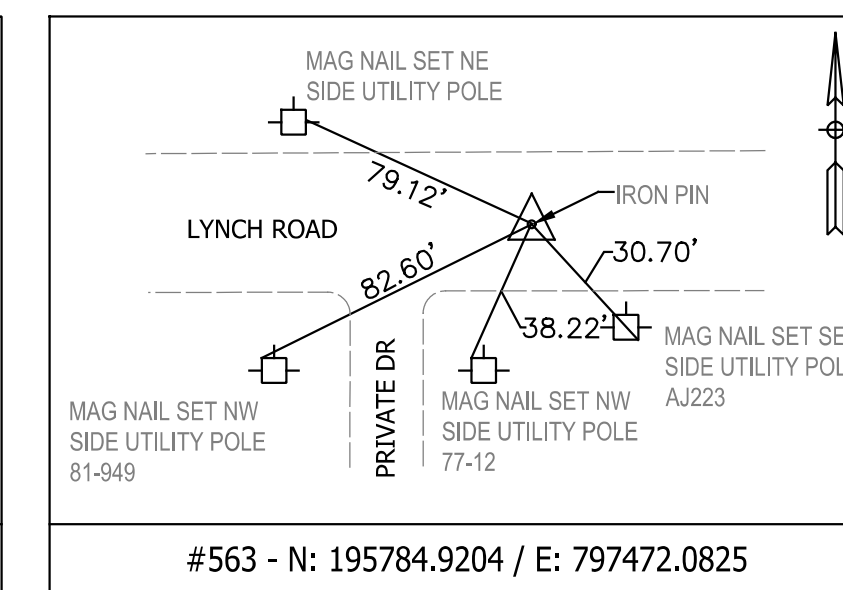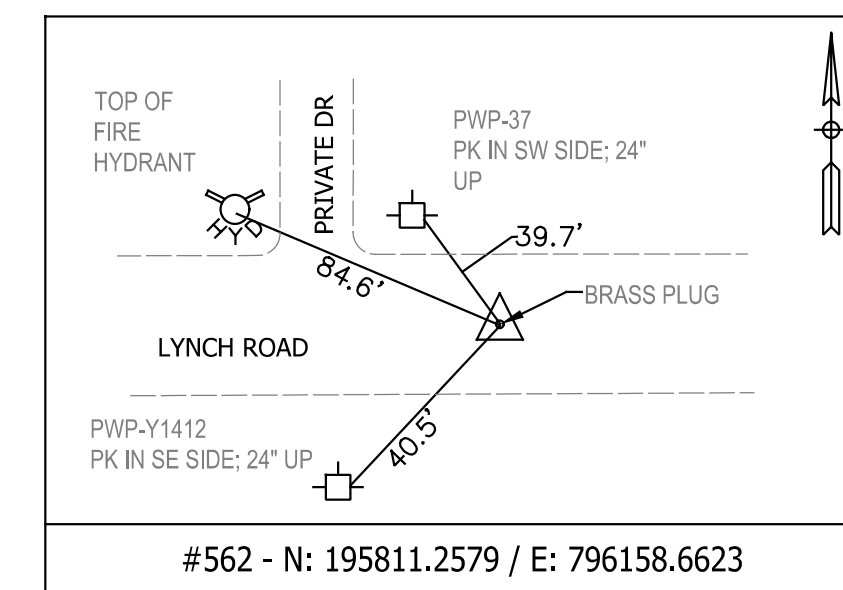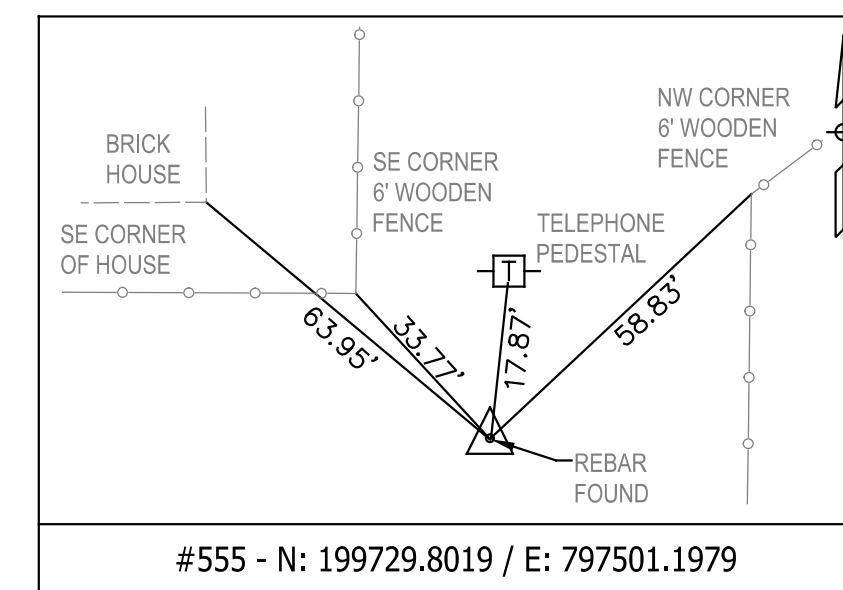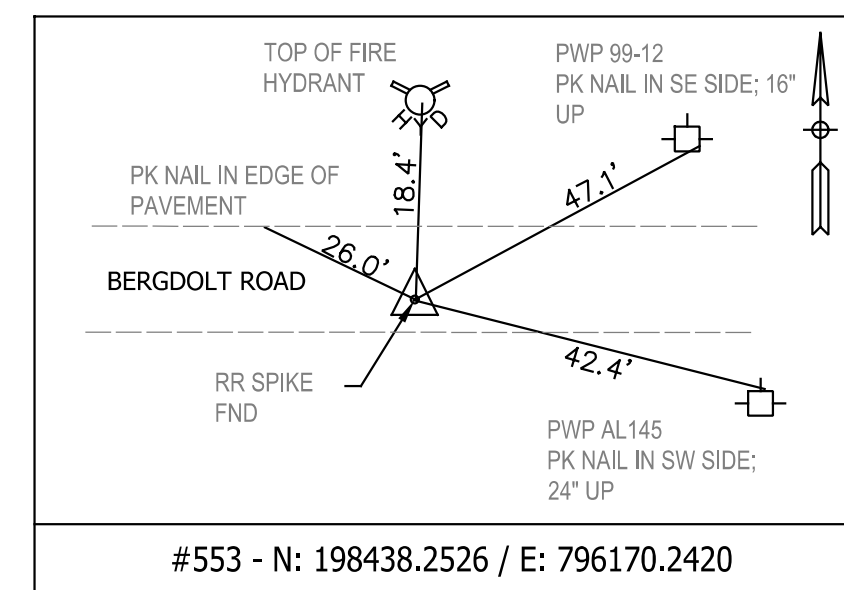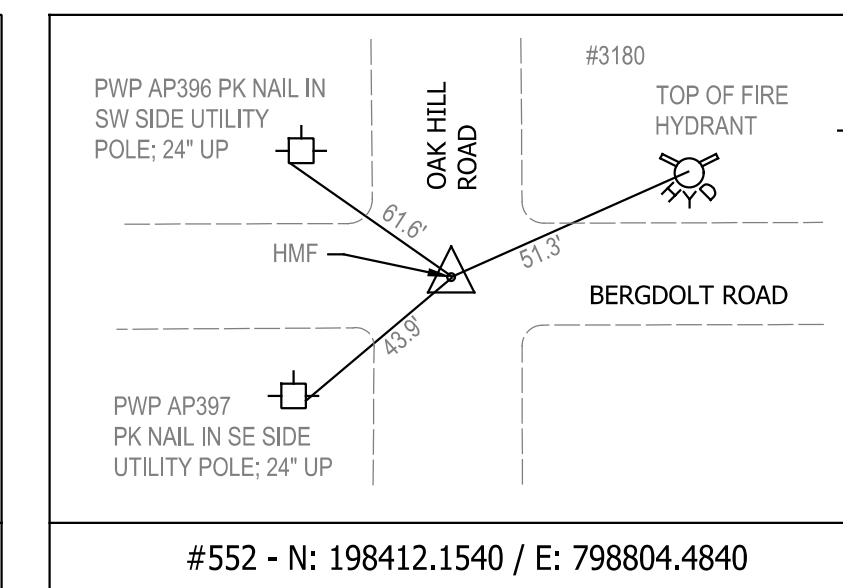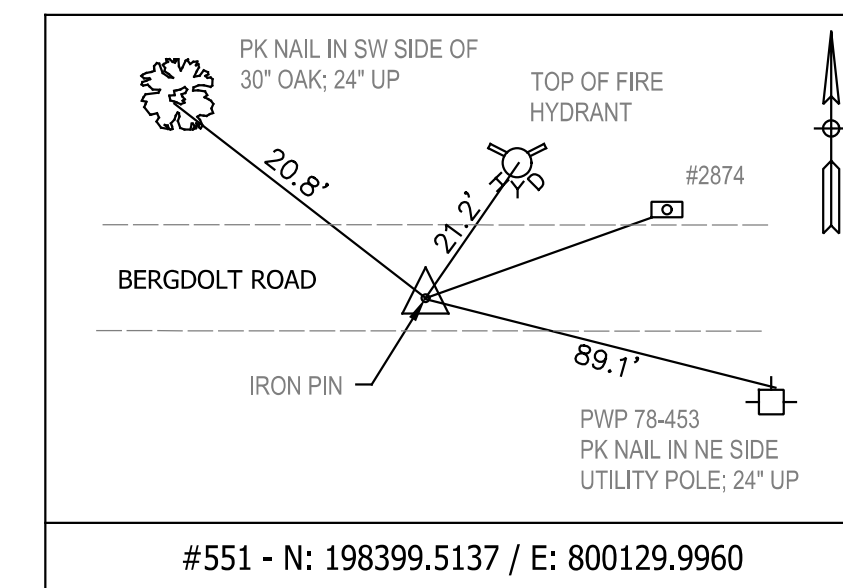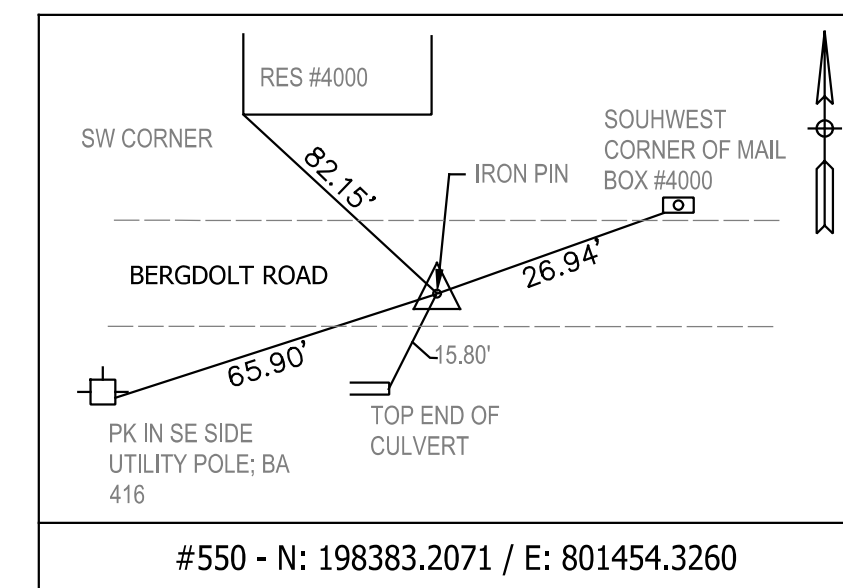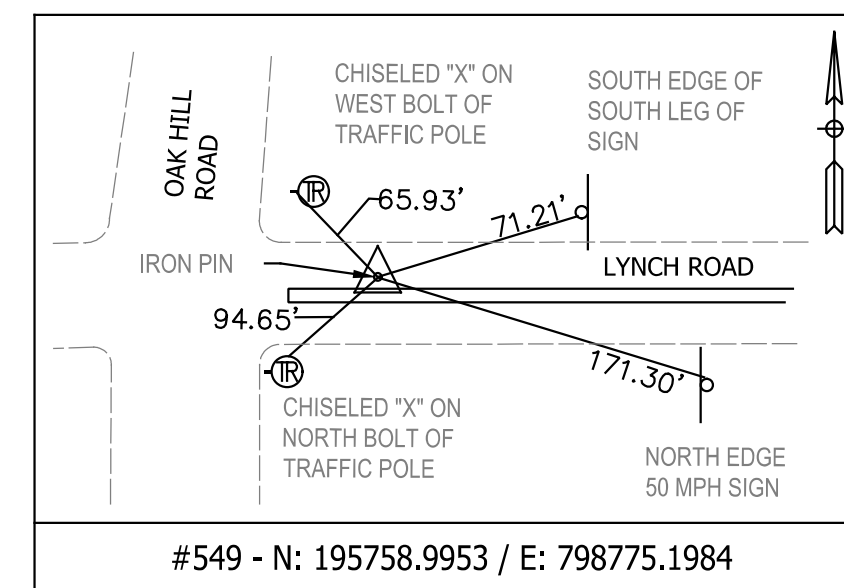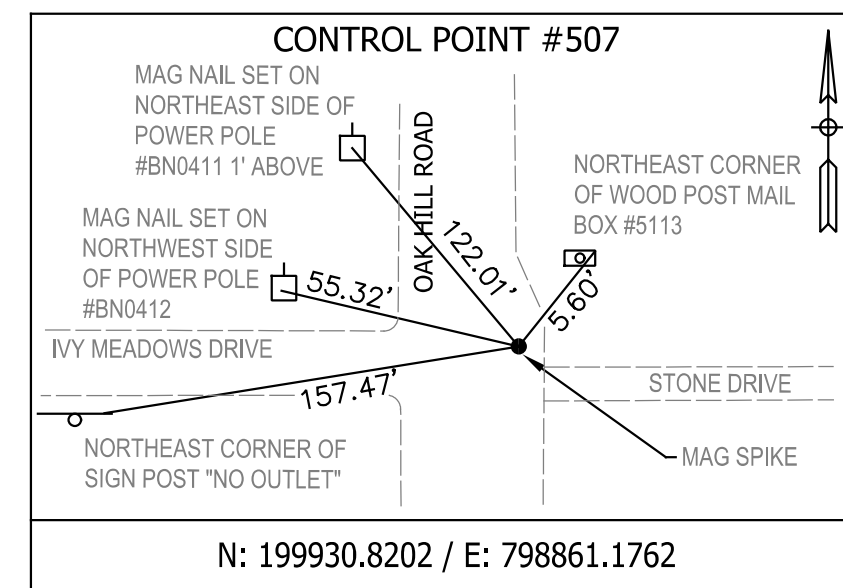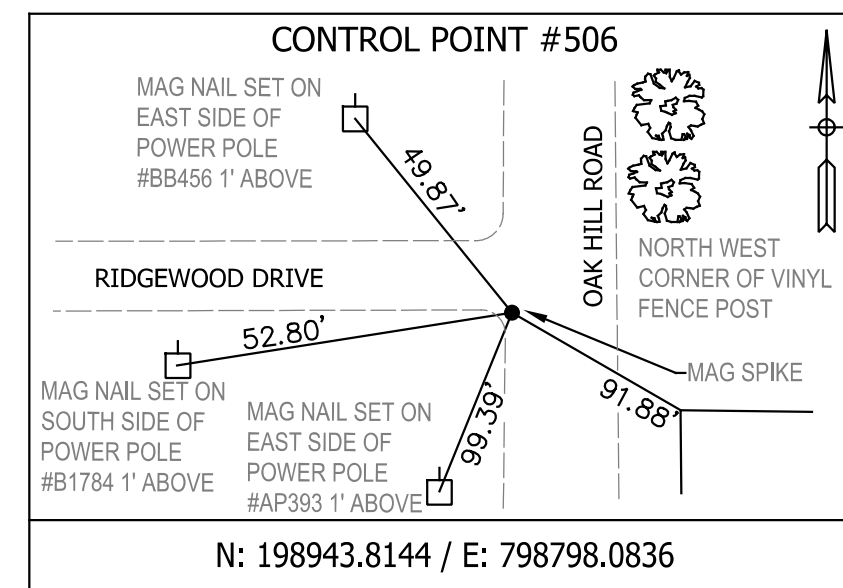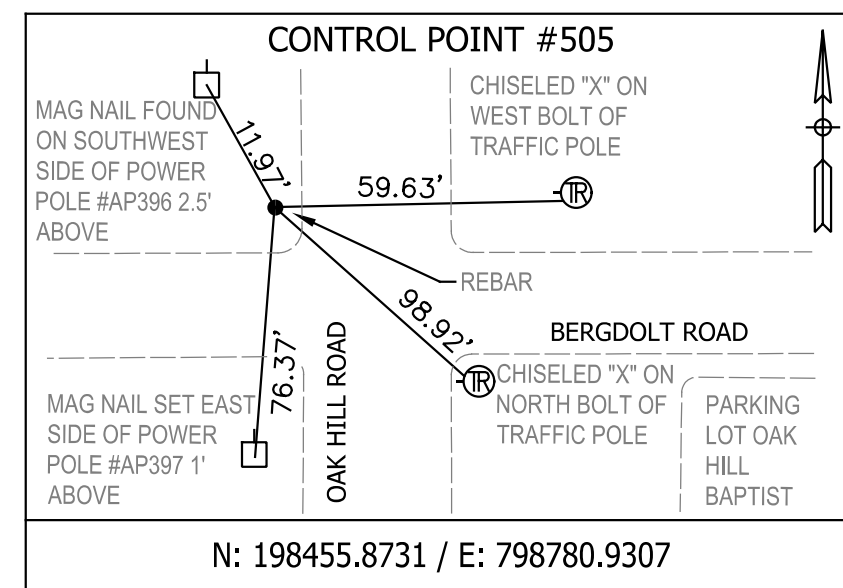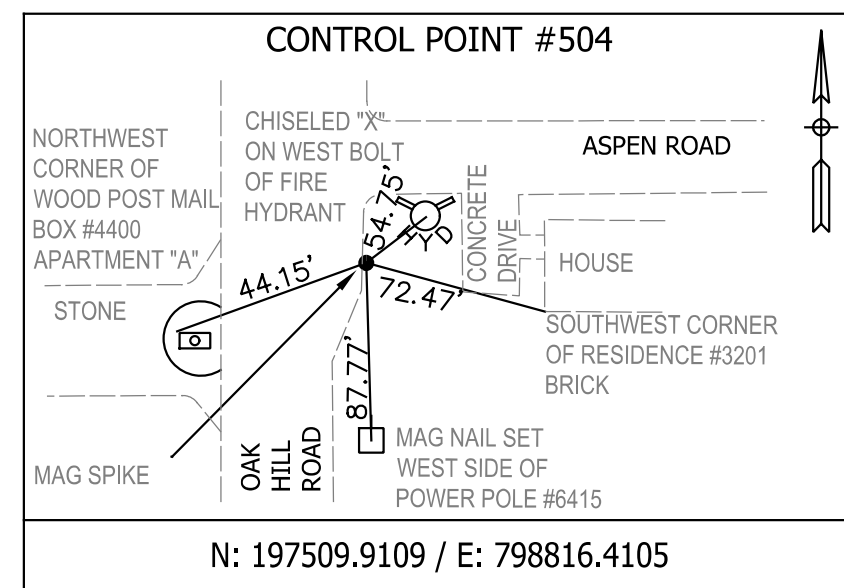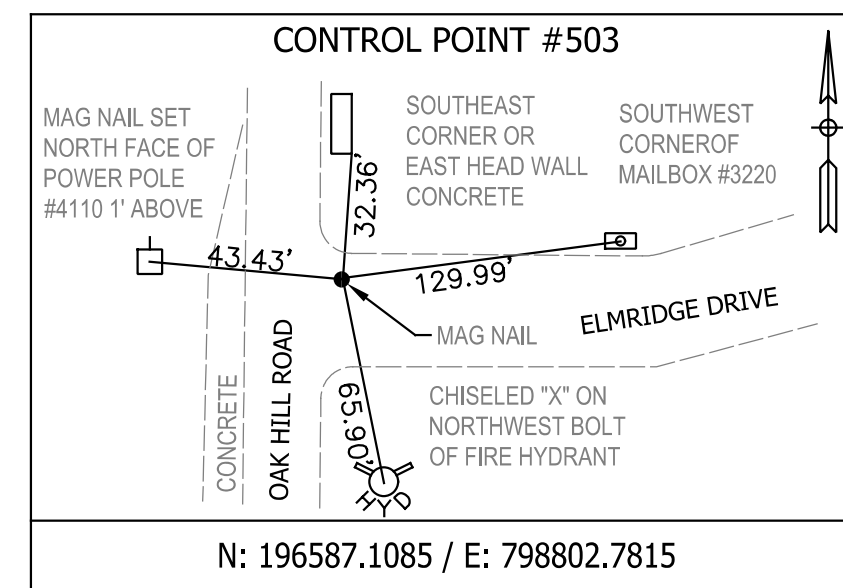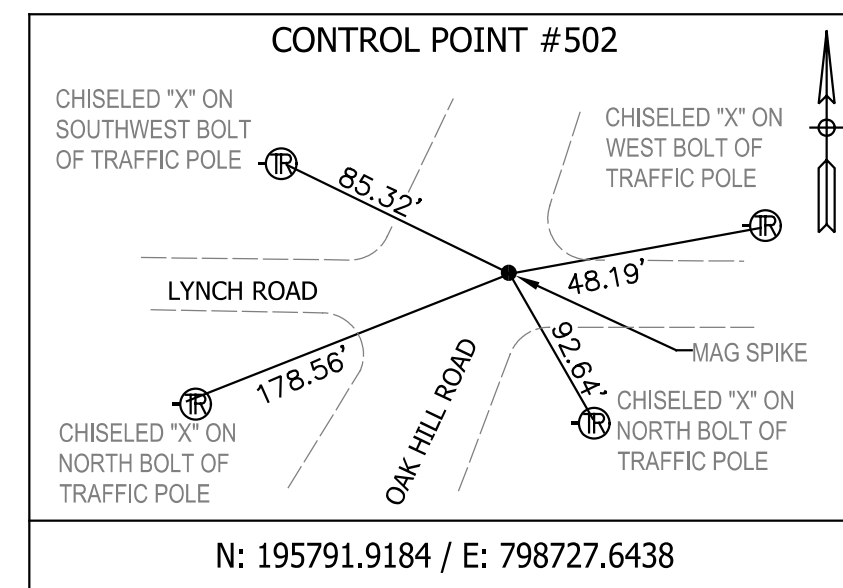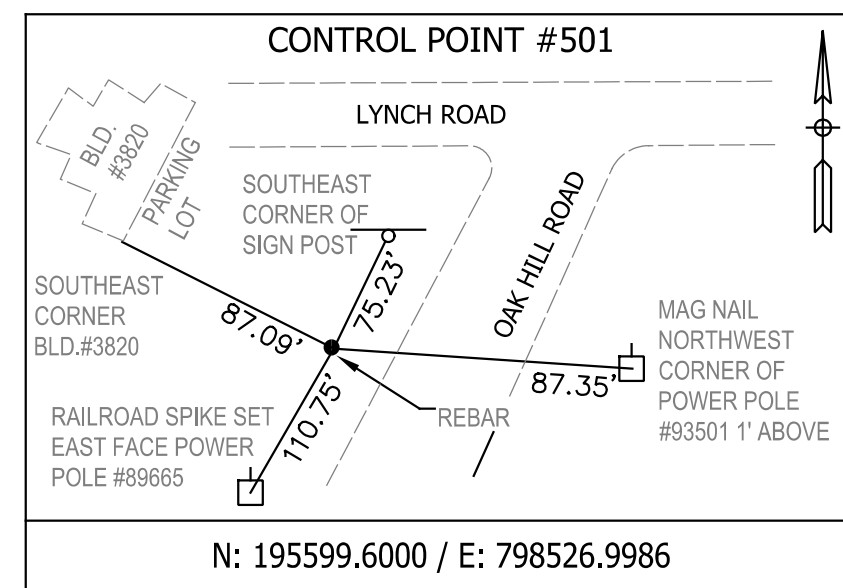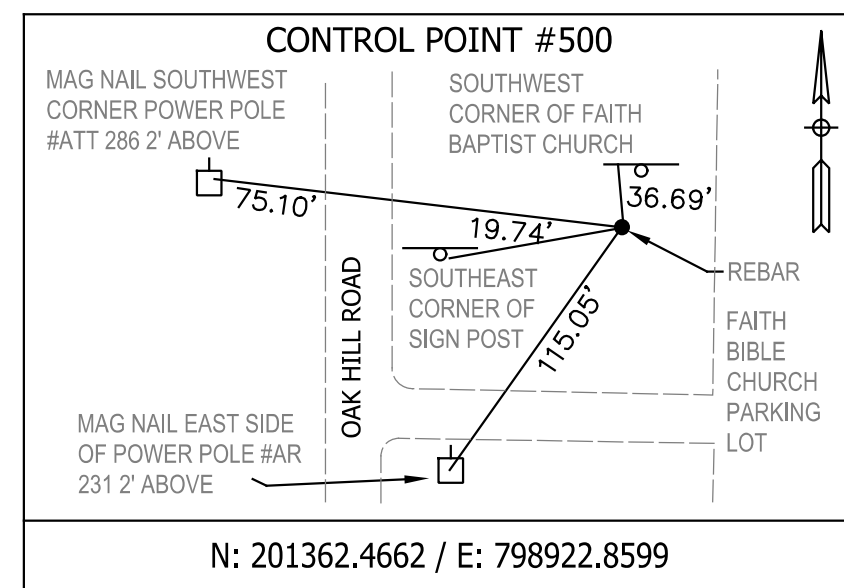RECOMMENDED FOR APPROVAL	DESIGN ENGINEER	DATE
DESIGNED: JKH	DRAWN: BLP	
CHECKED: DSS	CHECKED: DSS	

INDIANA DEPARTMENT OF TRANSPORTATION	
GEOMETRIC TIE-UP DETAILS	

HORIZONTAL SCALE	BRIDGE FILE
N/A	N/A
VERTICAL SCALE	DESIGNATION
N/A	2002538
SURVEY BOOK	SHEETS
N/A	9 of 117
CONTRACT	PROJECT
R-43470	2002538



QUANTITY SUMMARY - DETOUR		
Detour Route Marker Assembly	28	Each
Construction Sign, Type A	35	Each
Construction Sign, Type C	10	Each
Type III-A Barricade	0	Lft.
Type III-B Barricade	288	Lft.
Road Closure Sign Assembly	12	Each

NOTE: Contractor to maintain access to drives at all times.

DATE	REVISION



RECOMMENDED FOR APPROVAL _____	DESIGN ENGINEER _____	DATE _____
DESIGNED: _____ JKH _____	DRAWN: _____ BLP _____	
CHECKED: _____ DSS _____	CHECKED: _____ DSS _____	

INDIANA DEPARTMENT OF TRANSPORTATION

DETOUR PLAN
OAK HILL ROAD

HORIZONTAL SCALE	BRIDGE FILE
1" = 60'	N/A
VERTICAL SCALE	DESIGNATION
N/A	2002538
SURVEY BOOK	SHEETS
N/A	10 of 117
CONTRACT	PROJECT
R-43470	2002538

Inch:ft:mi:sec
Indiana:Shade.tbl

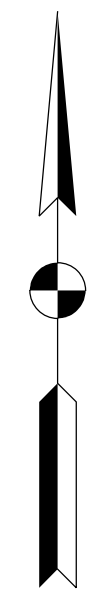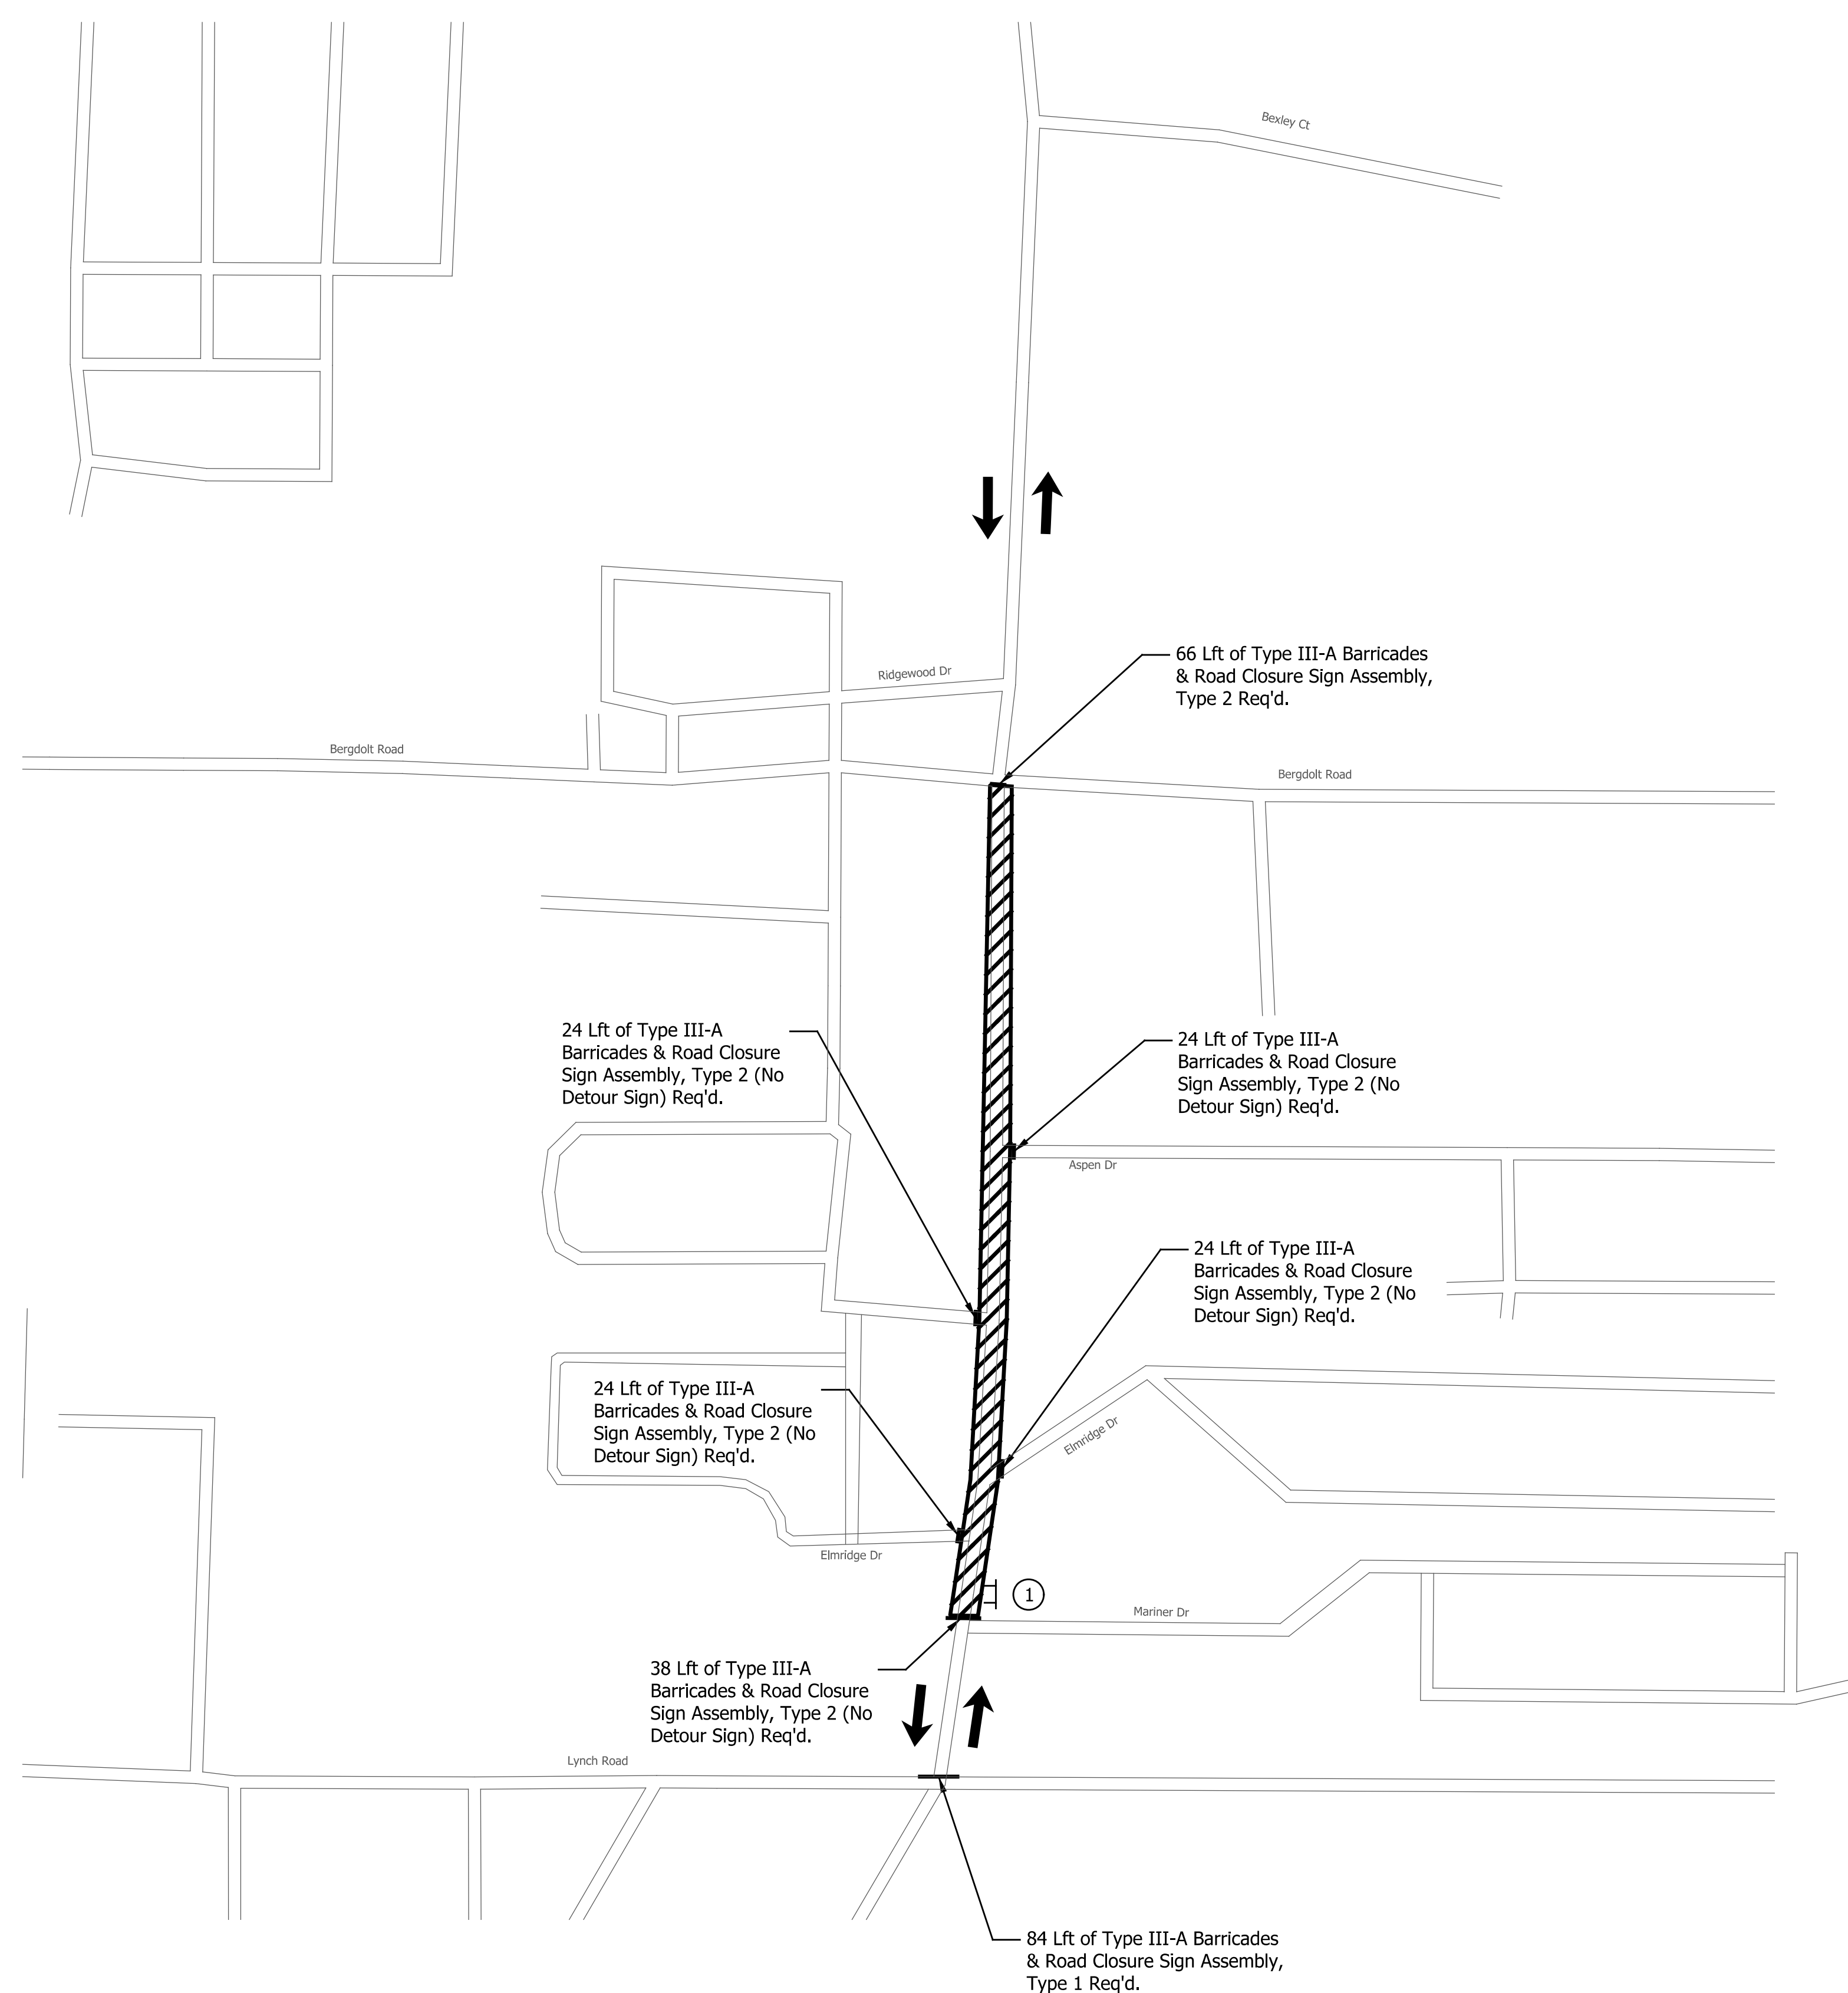

Road Closure Sign Assembly, Type 1
R11-4
(60" X 30")
②



Road Closure Sign Assembly, Type 2
R11-2
(48" X 30")
XM 4-10 (L or R)
(48" X 18")
③



DRMA 1
XM 4-8
XD 3-1
M 6-1 (L)
①



DRMA 3
XM 4-8
XD 3-1
M 6-1 (R)
③

LEGEND

- Construction Sign, Type A
- Type "A" Construction Warning Light
- Type "B" Construction Warning Light

- Detour Route
- Barricade
- Direction of Traffic Flow
- Construction Area

DATE	REVISION



RECOMMENDED FOR APPROVAL _____	DESIGN ENGINEER _____	DATE _____
DESIGNED: _____ JKH _____	DRAWN: _____ BLP _____	
CHECKED: _____ DSS _____	CHECKED: _____ DSS _____	

INDIANA DEPARTMENT
OF TRANSPORTATION

LOCAL ROADS DETOUR PLAN
SECTION 2

HORIZONTAL SCALE 1" = 300'	BRIDGE FILE N/A
VERTICAL SCALE N/A	DESIGNATION 2002538
SURVEY BOOK N/A	SHEETS 12 of 117
CONTRACT R-43470	PROJECT 2002538

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Road Closure Sign Assembly, Type 1
R11-4
(60" X 30")
②

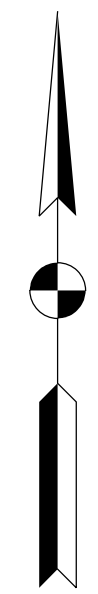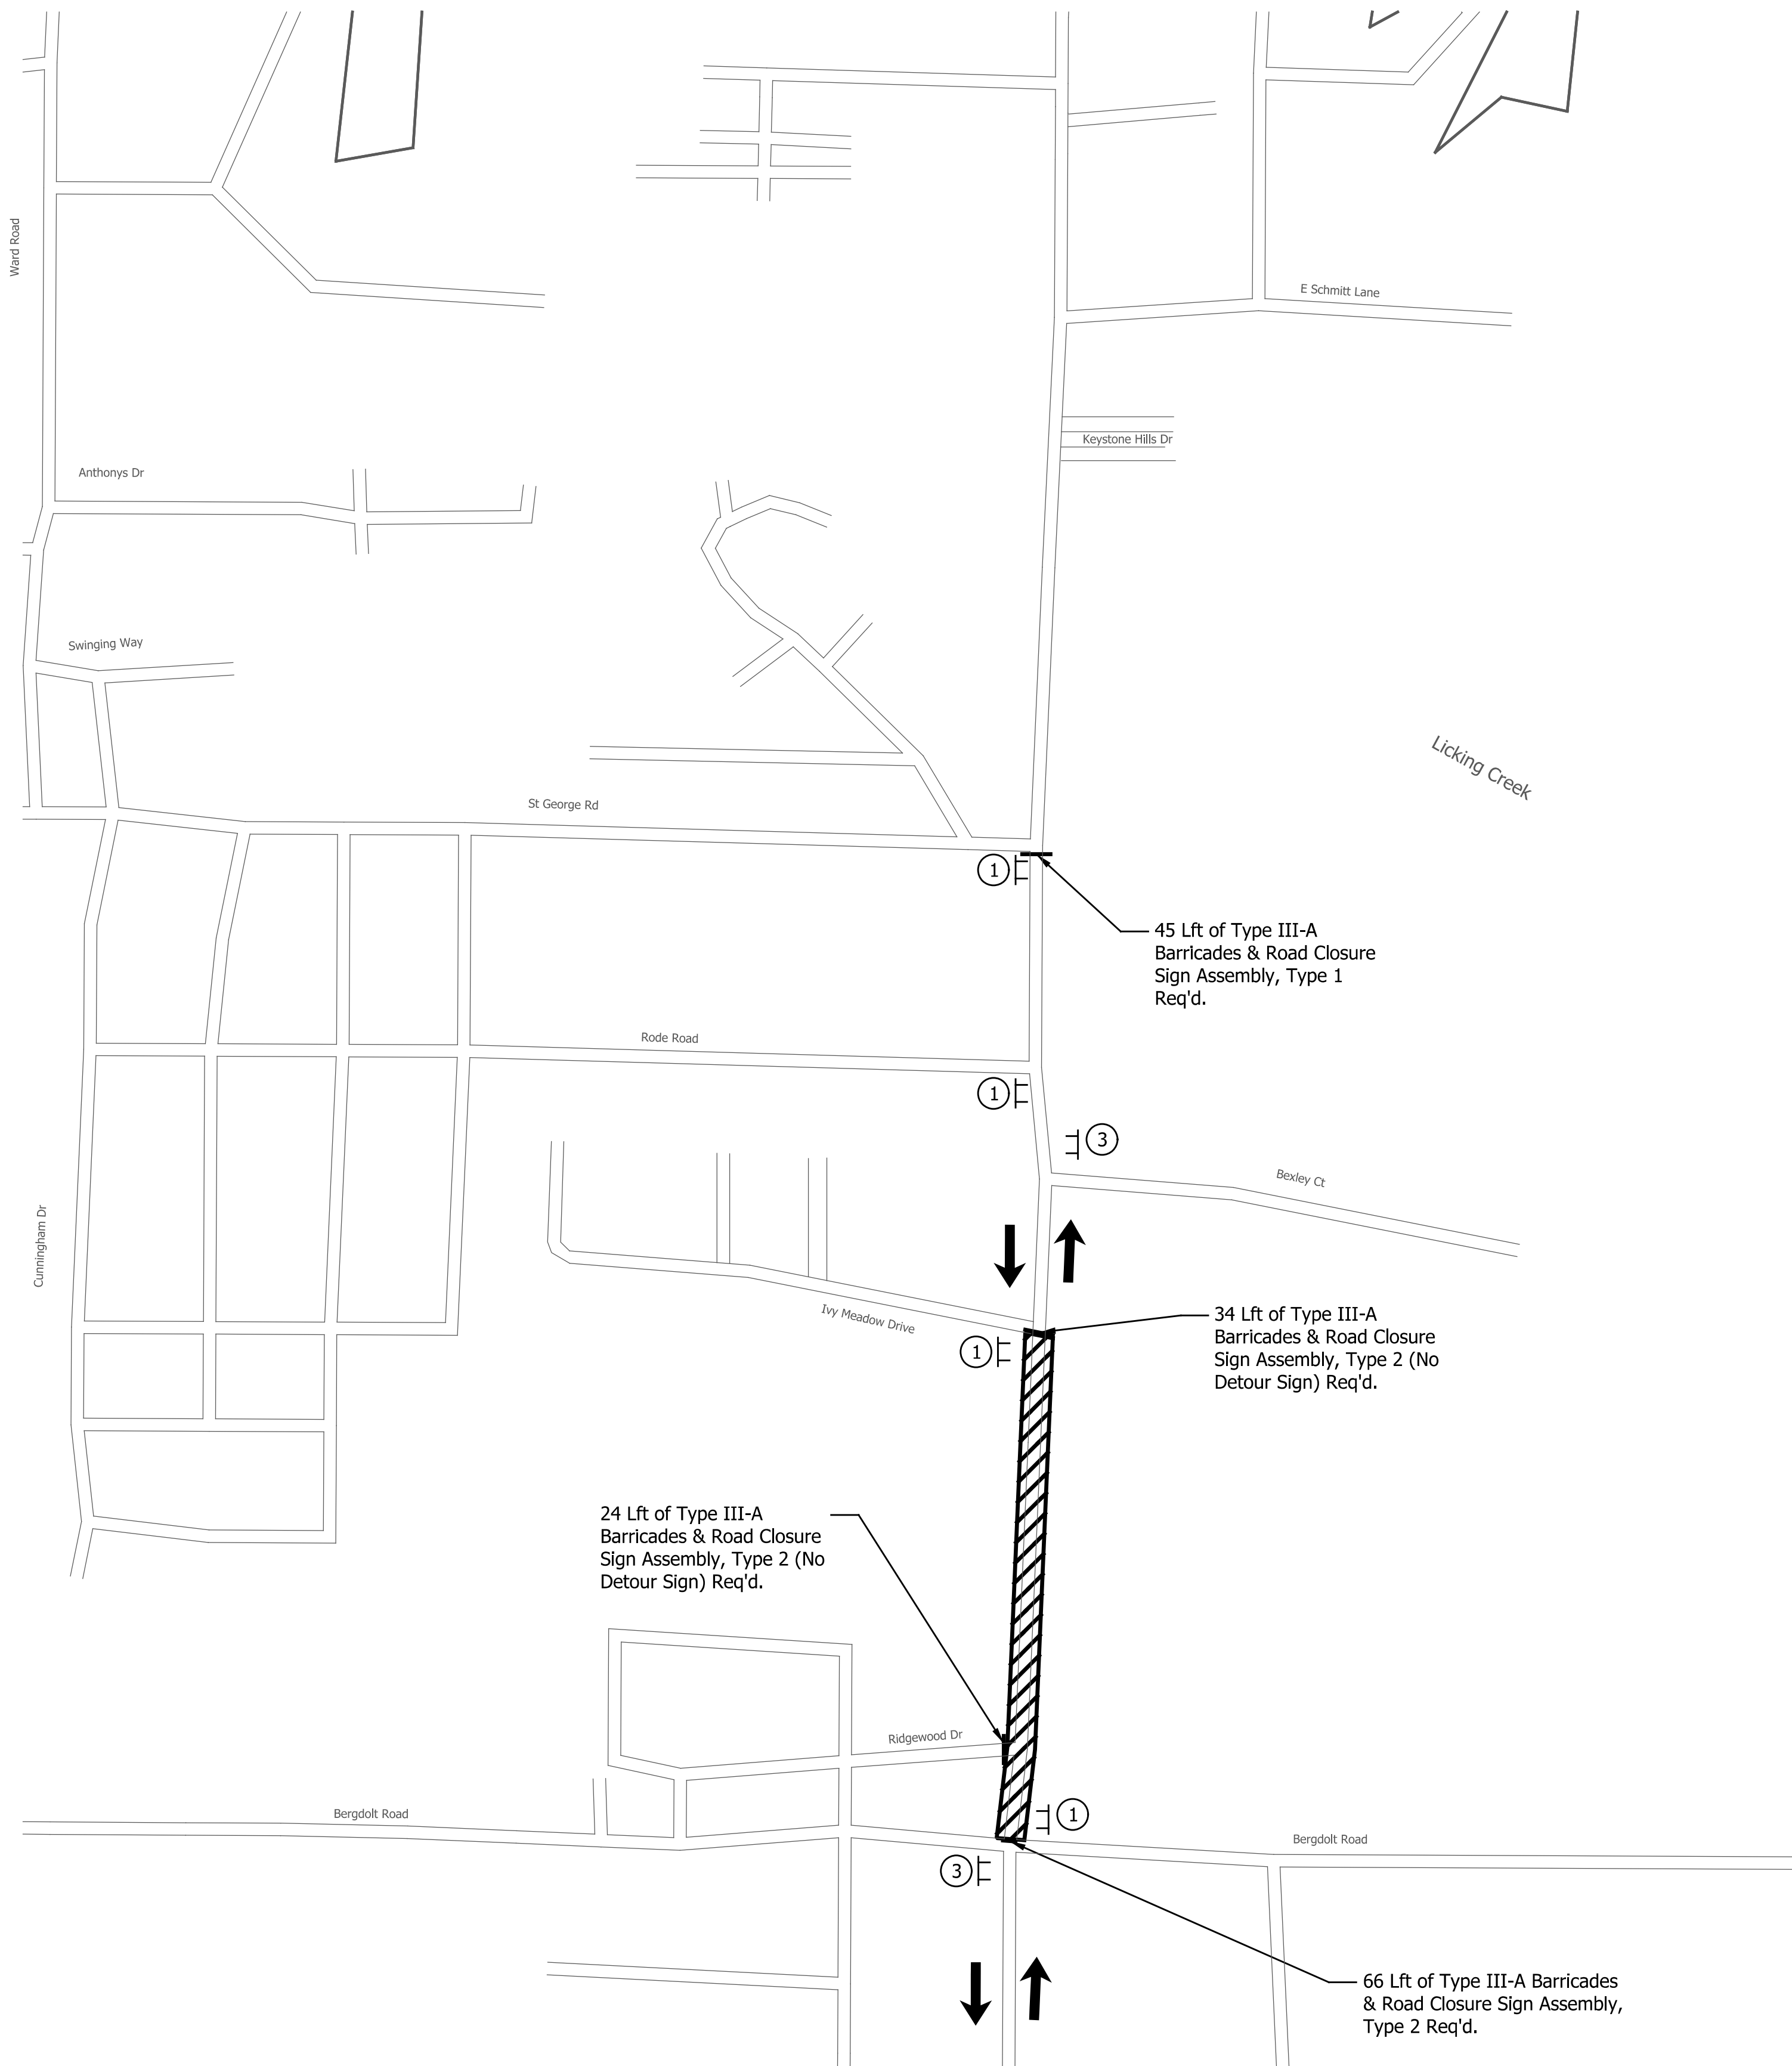

Road Closure Sign Assembly, Type 2
R11-2
(48" X 30")
XM 4-10 (L or R)
(48" X 18")
③



DRMA 1
XM 4-8
XD 3-1
M 6-1 (L)
①



DRMA 3
XM 4-8
XD 3-1
M 6-1 (R)
③

LEGEND

- Construction Sign, Type A
- Type "A" Construction Warning Light
- Type "B" Construction Warning Light

- Detour Route
- Barricade
- Direction of Traffic Flow
- Construction Area

DATE	REVISION

RECOMMENDED FOR APPROVAL _____	DESIGN ENGINEER _____	DATE _____
DESIGNED: _____ JKH _____	DRAWN: _____ BLP _____	
CHECKED: _____ DSS _____	CHECKED: _____ DSS _____	



INDIANA DEPARTMENT OF TRANSPORTATION

LOCAL ROADS DETOUR PLAN

SECTION 3

HORIZONTAL SCALE 1" = 300'	BRIDGE FILE N/A
VERTICAL SCALE N/A	DESIGNATION 2002538
SURVEY BOOK N/A	SHEETS 13 of 117
CONTRACT R-43470	PROJECT 2002538

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Road Closure Sign Assembly, Type 1
R11-4
(60" X 30")
②

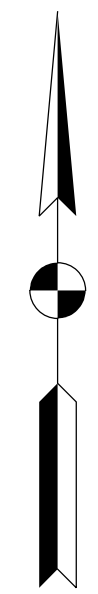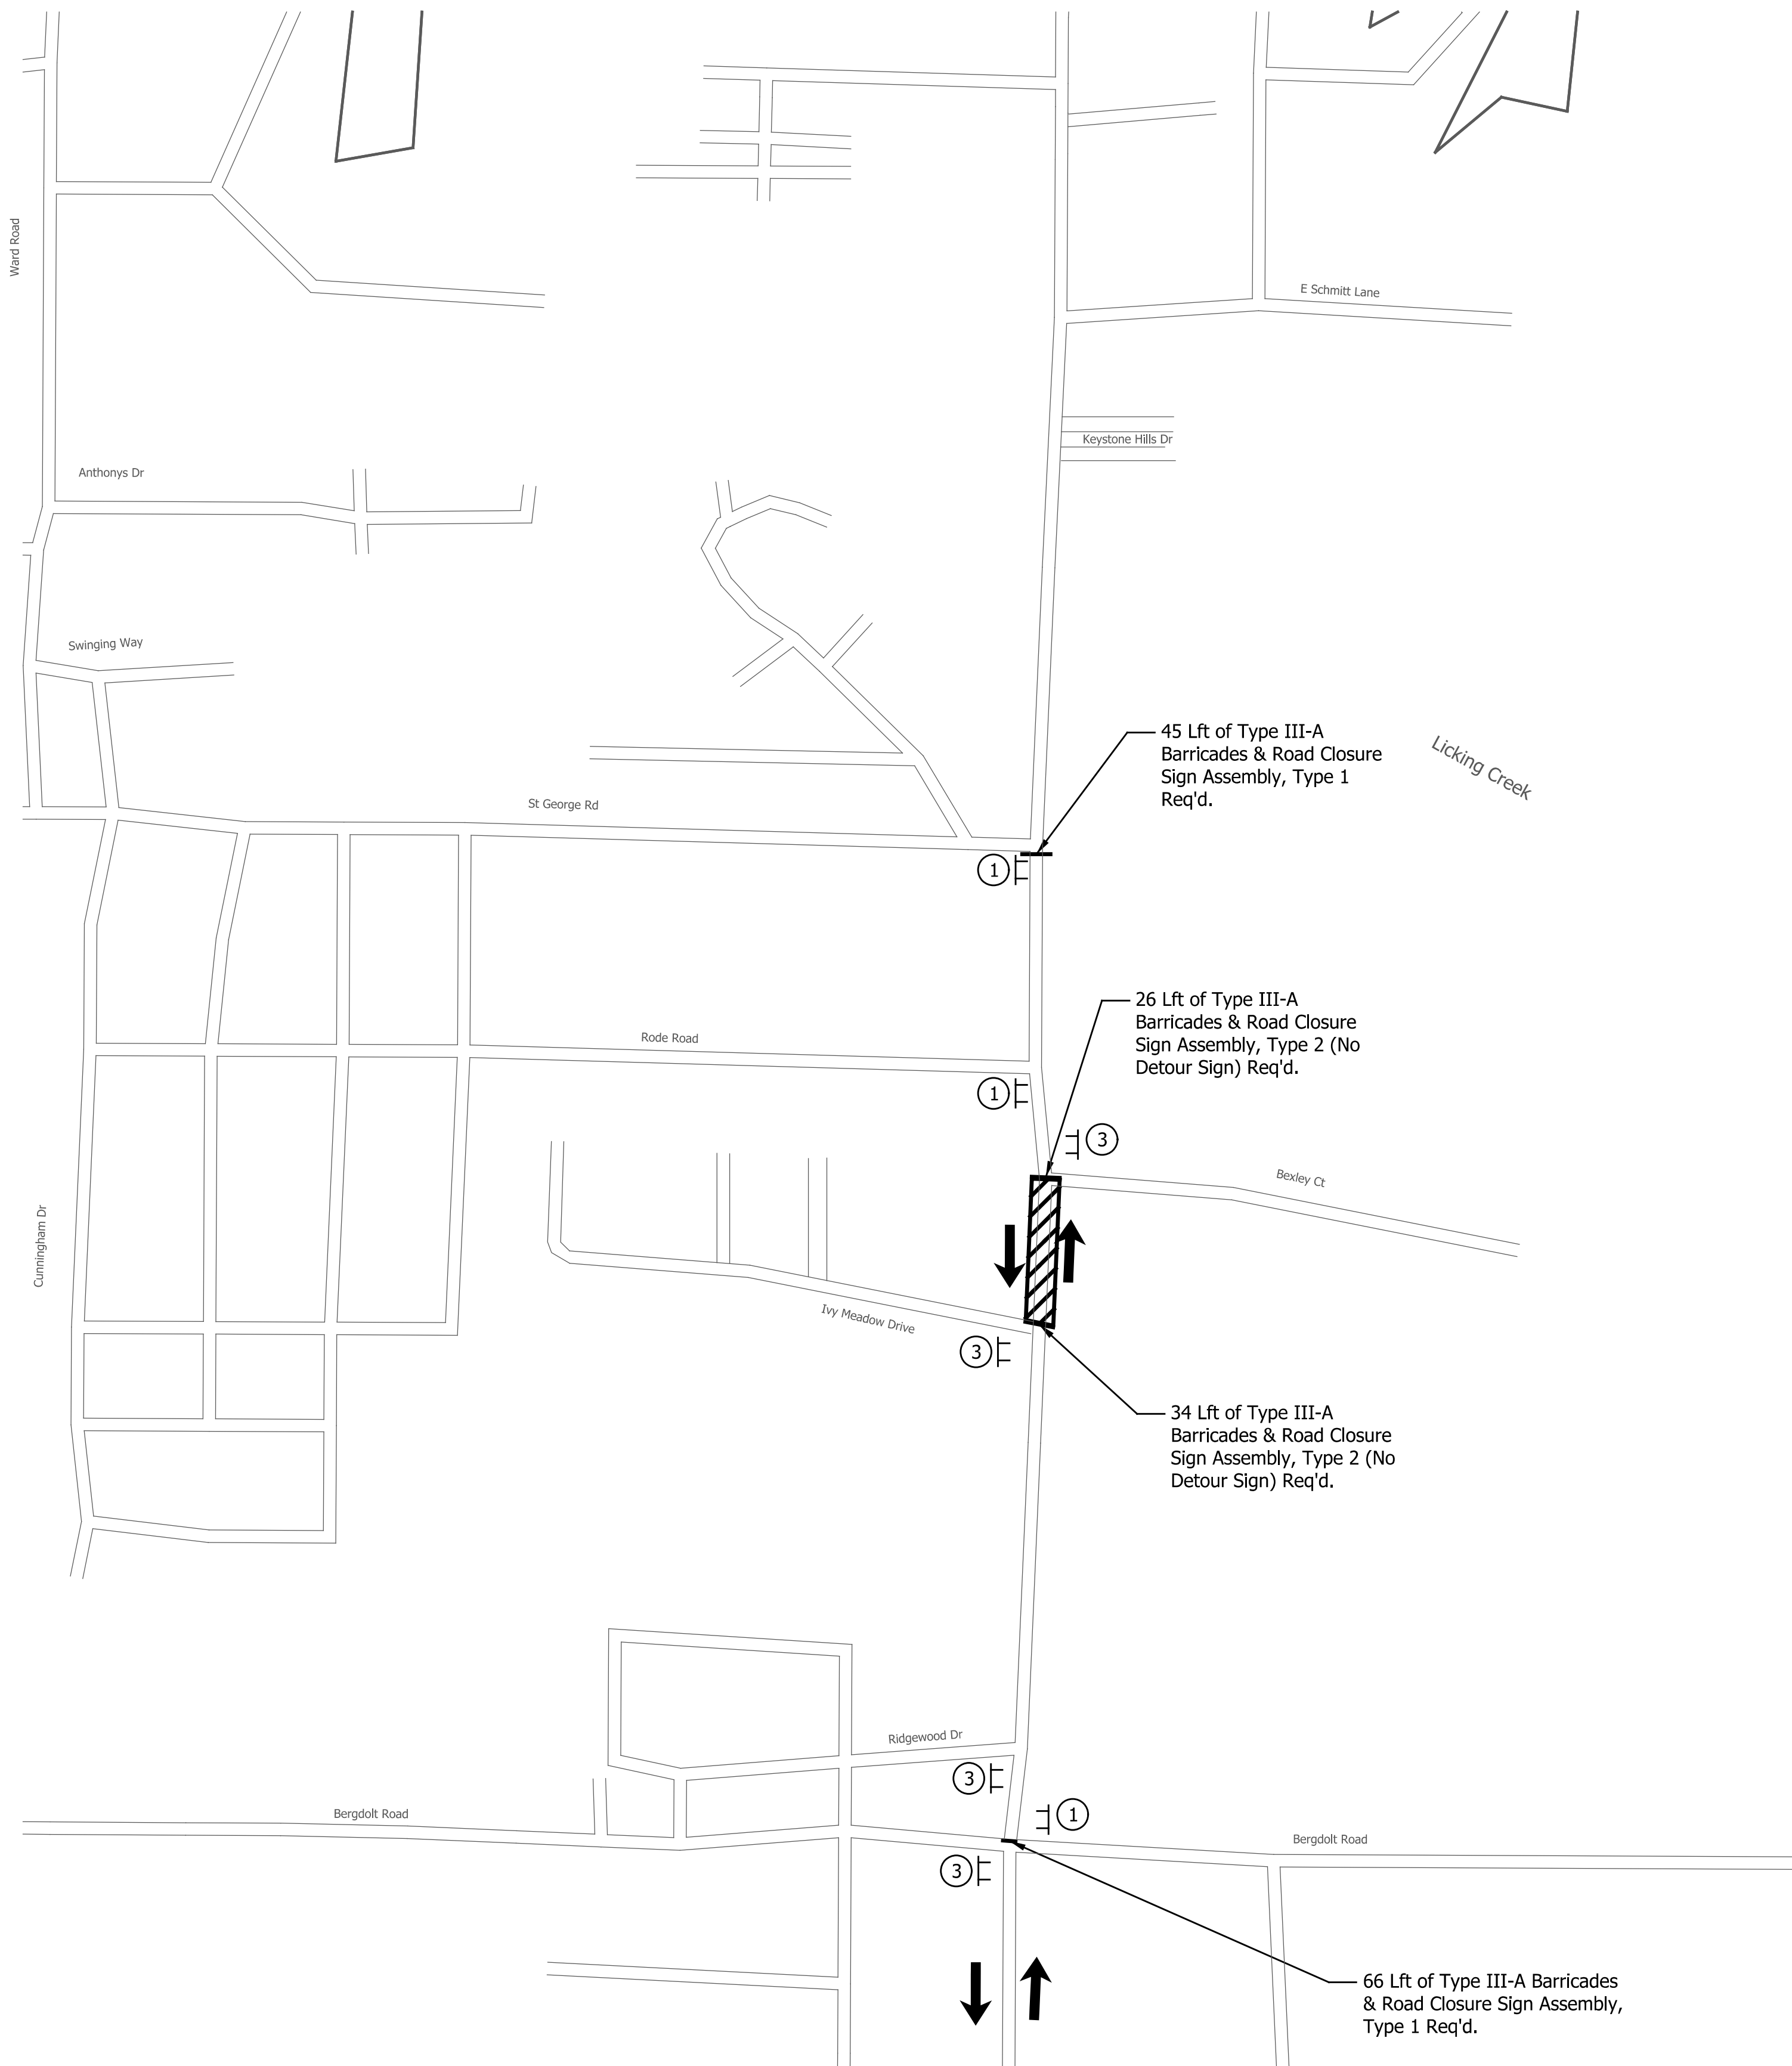

Road Closure Sign Assembly, Type 2
R11-2
(48" X 30")
XM 4-10 (L or R)
(48" X 18")
③



DRMA 1
XM 4-8
XD 3-1
M 6-1 (L)
①



DRMA 3
XM 4-8
XD 3-1
M 6-1 (R)
③

LEGEND

- Construction Sign, Type A
- Type "A" Construction Warning Light
- Type "B" Construction Warning Light
- Detour Route
- Barricade
- Direction of Traffic Flow
- Construction Area

DATE	REVISION

RECOMMENDED FOR APPROVAL _____	DESIGN ENGINEER _____	DATE _____
DESIGNED: _____ JKH _____	DRAWN: _____ BLP _____	
CHECKED: _____ DSS _____	CHECKED: _____ DSS _____	



INDIANA DEPARTMENT OF TRANSPORTATION

LOCAL ROADS DETOUR PLAN

SECTION 4

HORIZONTAL SCALE 1" = 300'	BRIDGE FILE N/A
VERTICAL SCALE N/A	DESIGNATION 2002538
SURVEY BOOK N/A	SHEETS 14 of 117
CONTRACT R-43470	PROJECT 2002538

I:\a\c\p\h\j\indiana_shade.tbl

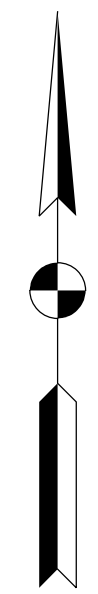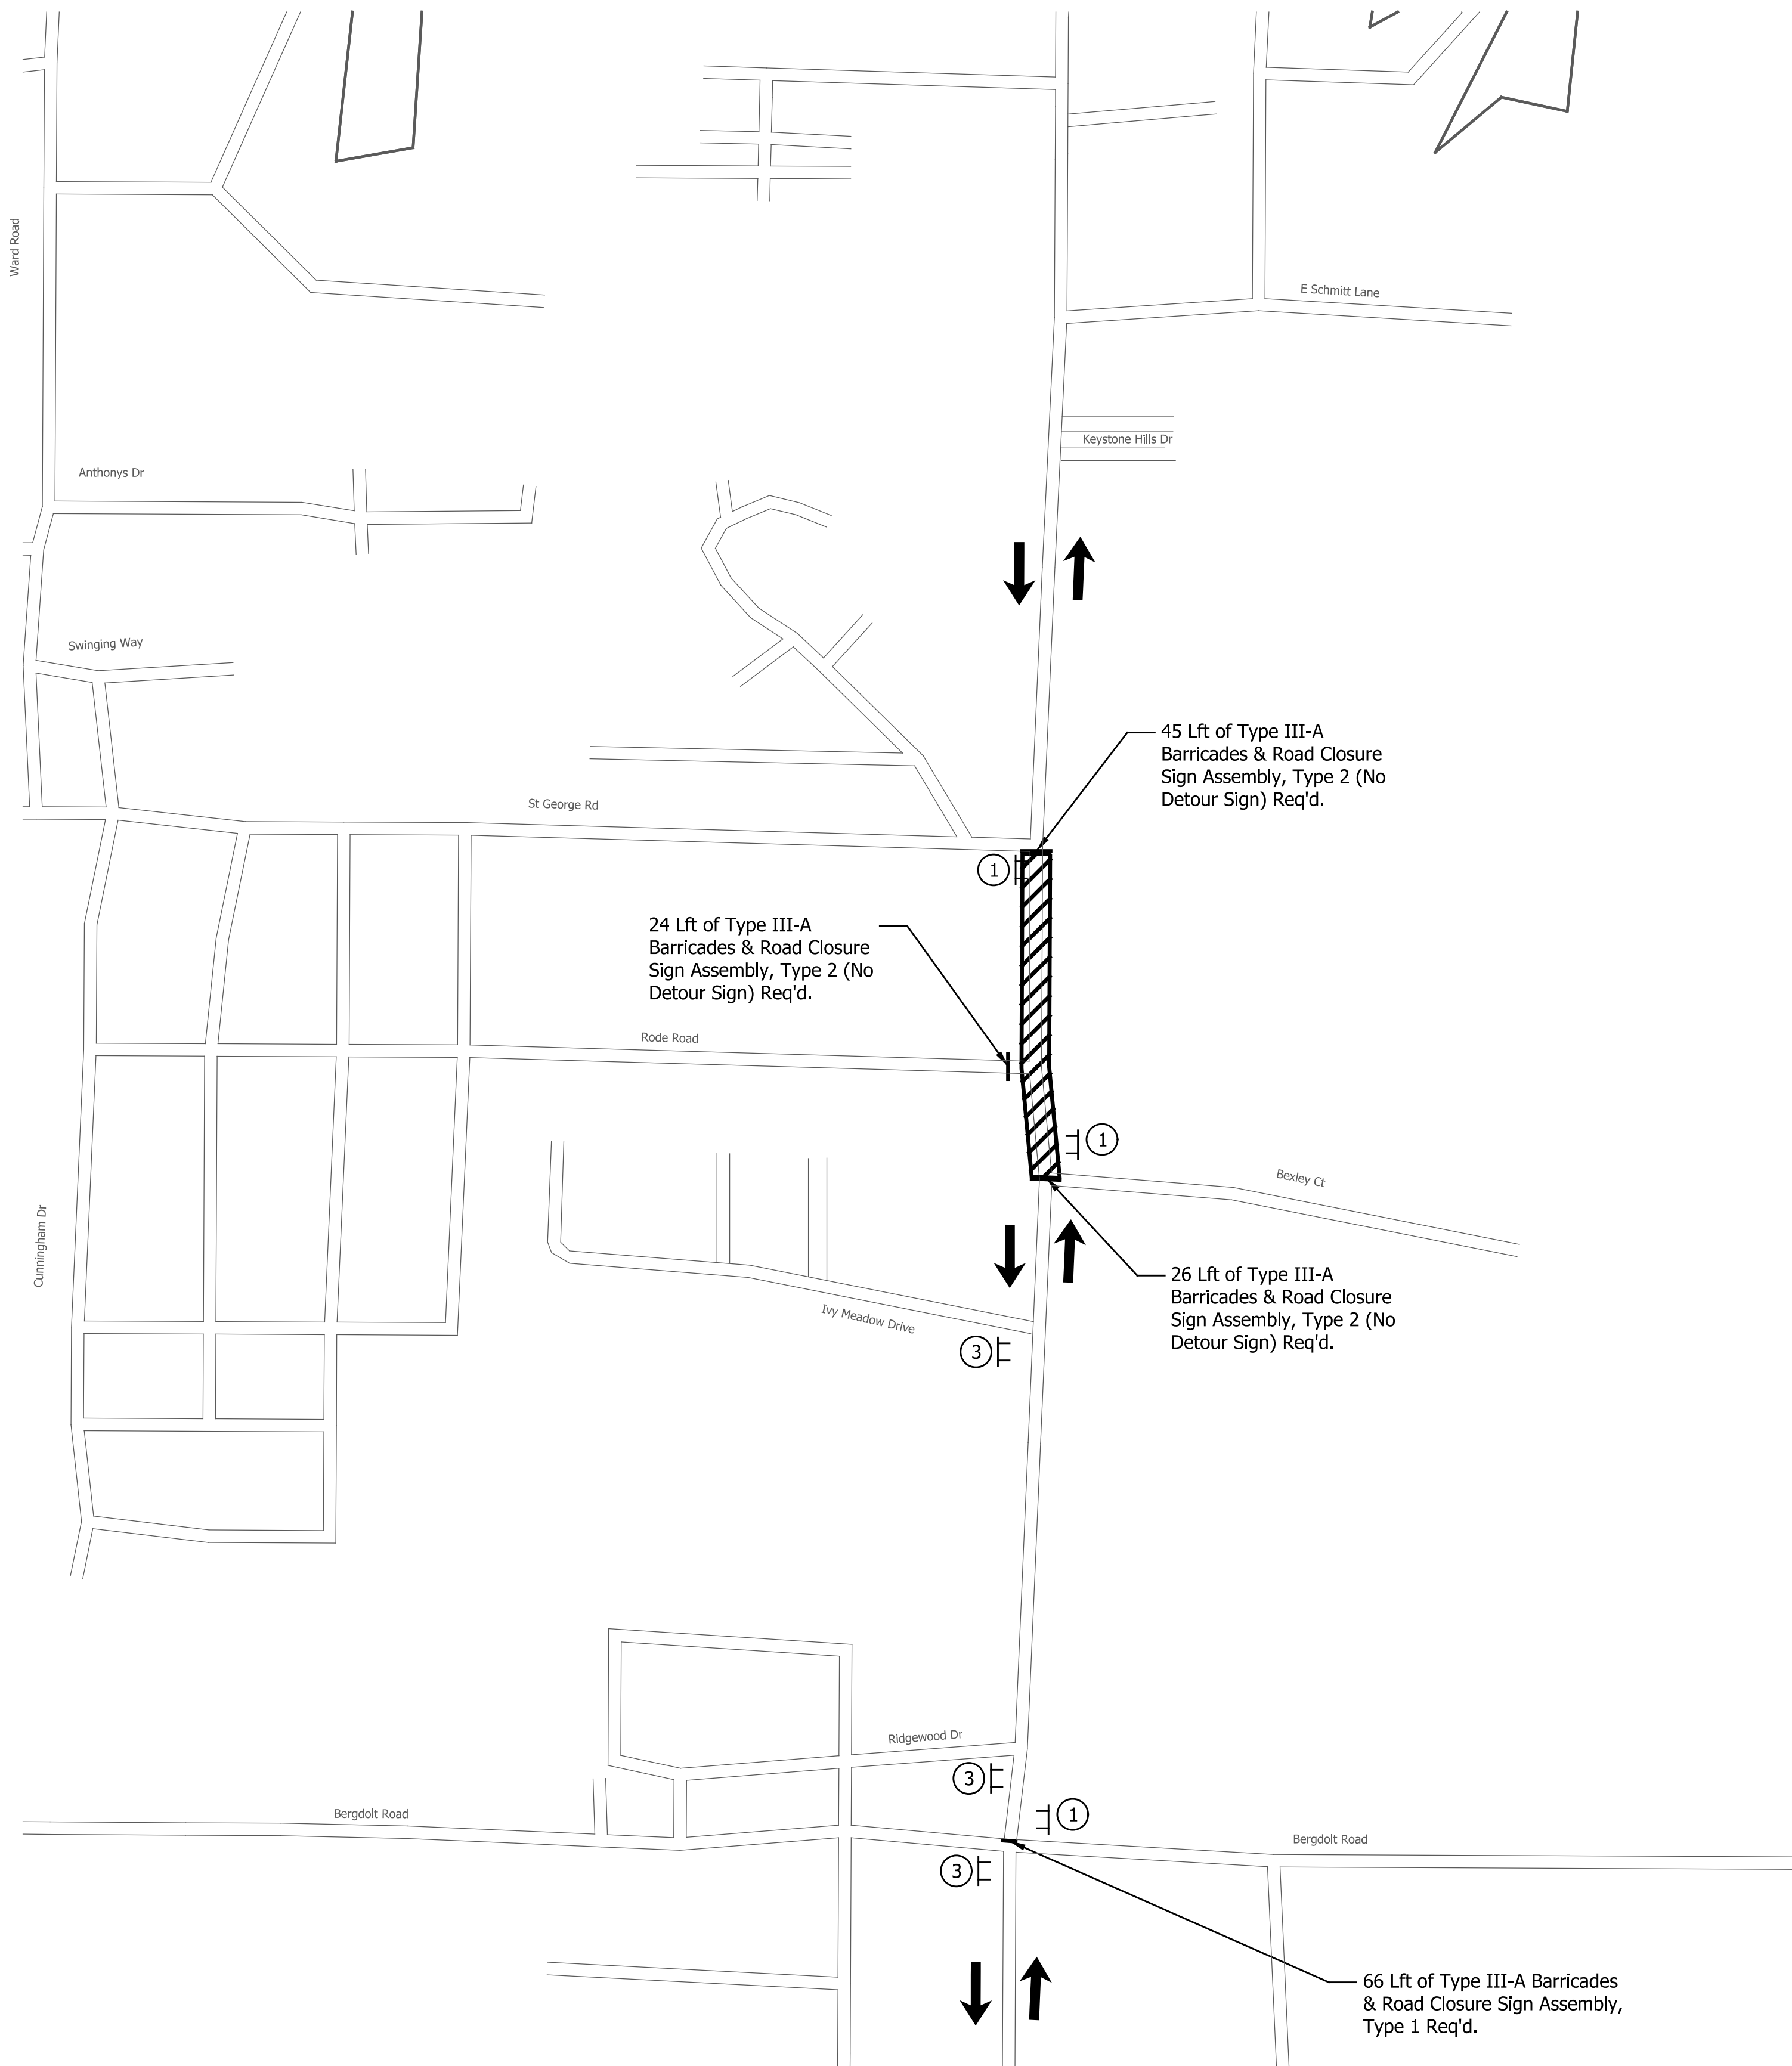

Road Closure Sign Assembly, Type 1
R11-4
(60" X 30")
②



Road Closure Sign Assembly, Type 2
R11-2
(48" X 30")
XM 4-10 (L or R)
(48" X 18")
③



DRMA 1
XM 4-8
XD 3-1
M 6-1 (L)
①



DRMA 3
XM 4-8
XD 3-1
M 6-1 (R)
③

LEGEND

- Construction Sign, Type A
- Type "A" Construction Warning Light
- Type "B" Construction Warning Light
- Detour Route
- Barricade
- Direction of Traffic Flow
- Construction Area

DATE	REVISION

RECOMMENDED FOR APPROVAL	DESIGN ENGINEER	DATE
DESIGNED: JKH	DRAWN: BLP	
CHECKED: DSS	CHECKED: DSS	


INDIANA DEPARTMENT OF TRANSPORTATION

LOCAL ROADS DETOUR PLAN

SECTION 5

HORIZONTAL SCALE	BRIDGE FILE
1" = 300'	N/A
VERTICAL SCALE	DESIGNATION
N/A	2002538
SURVEY BOOK	SHEETS
N/A	15 of 117
CONTRACT	PROJECT
R-43470	2002538

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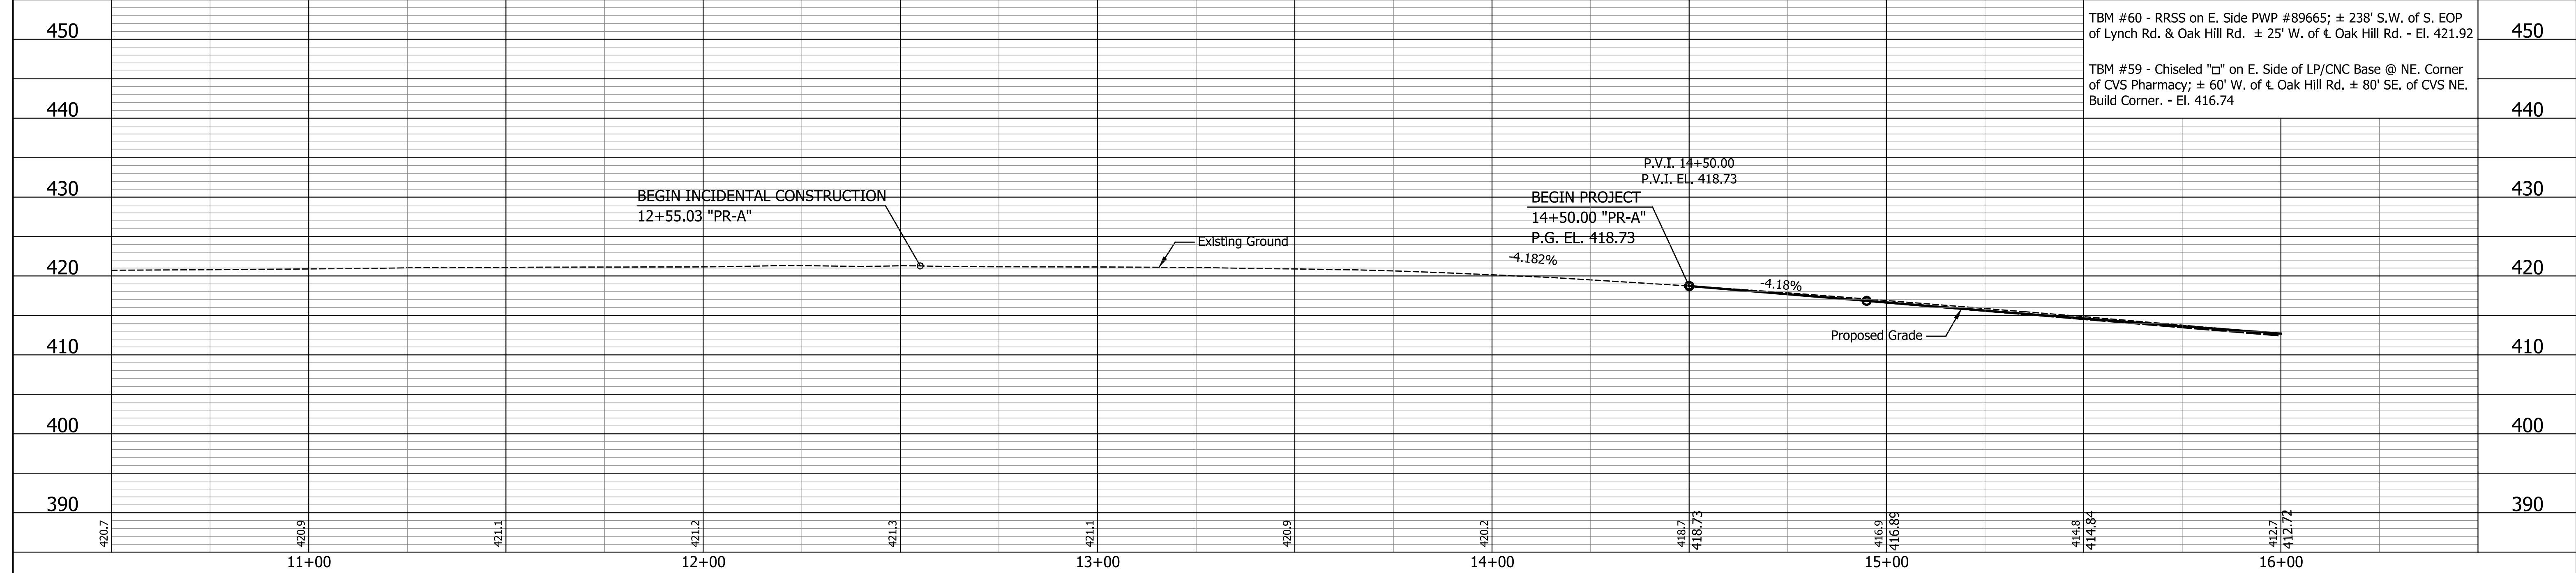


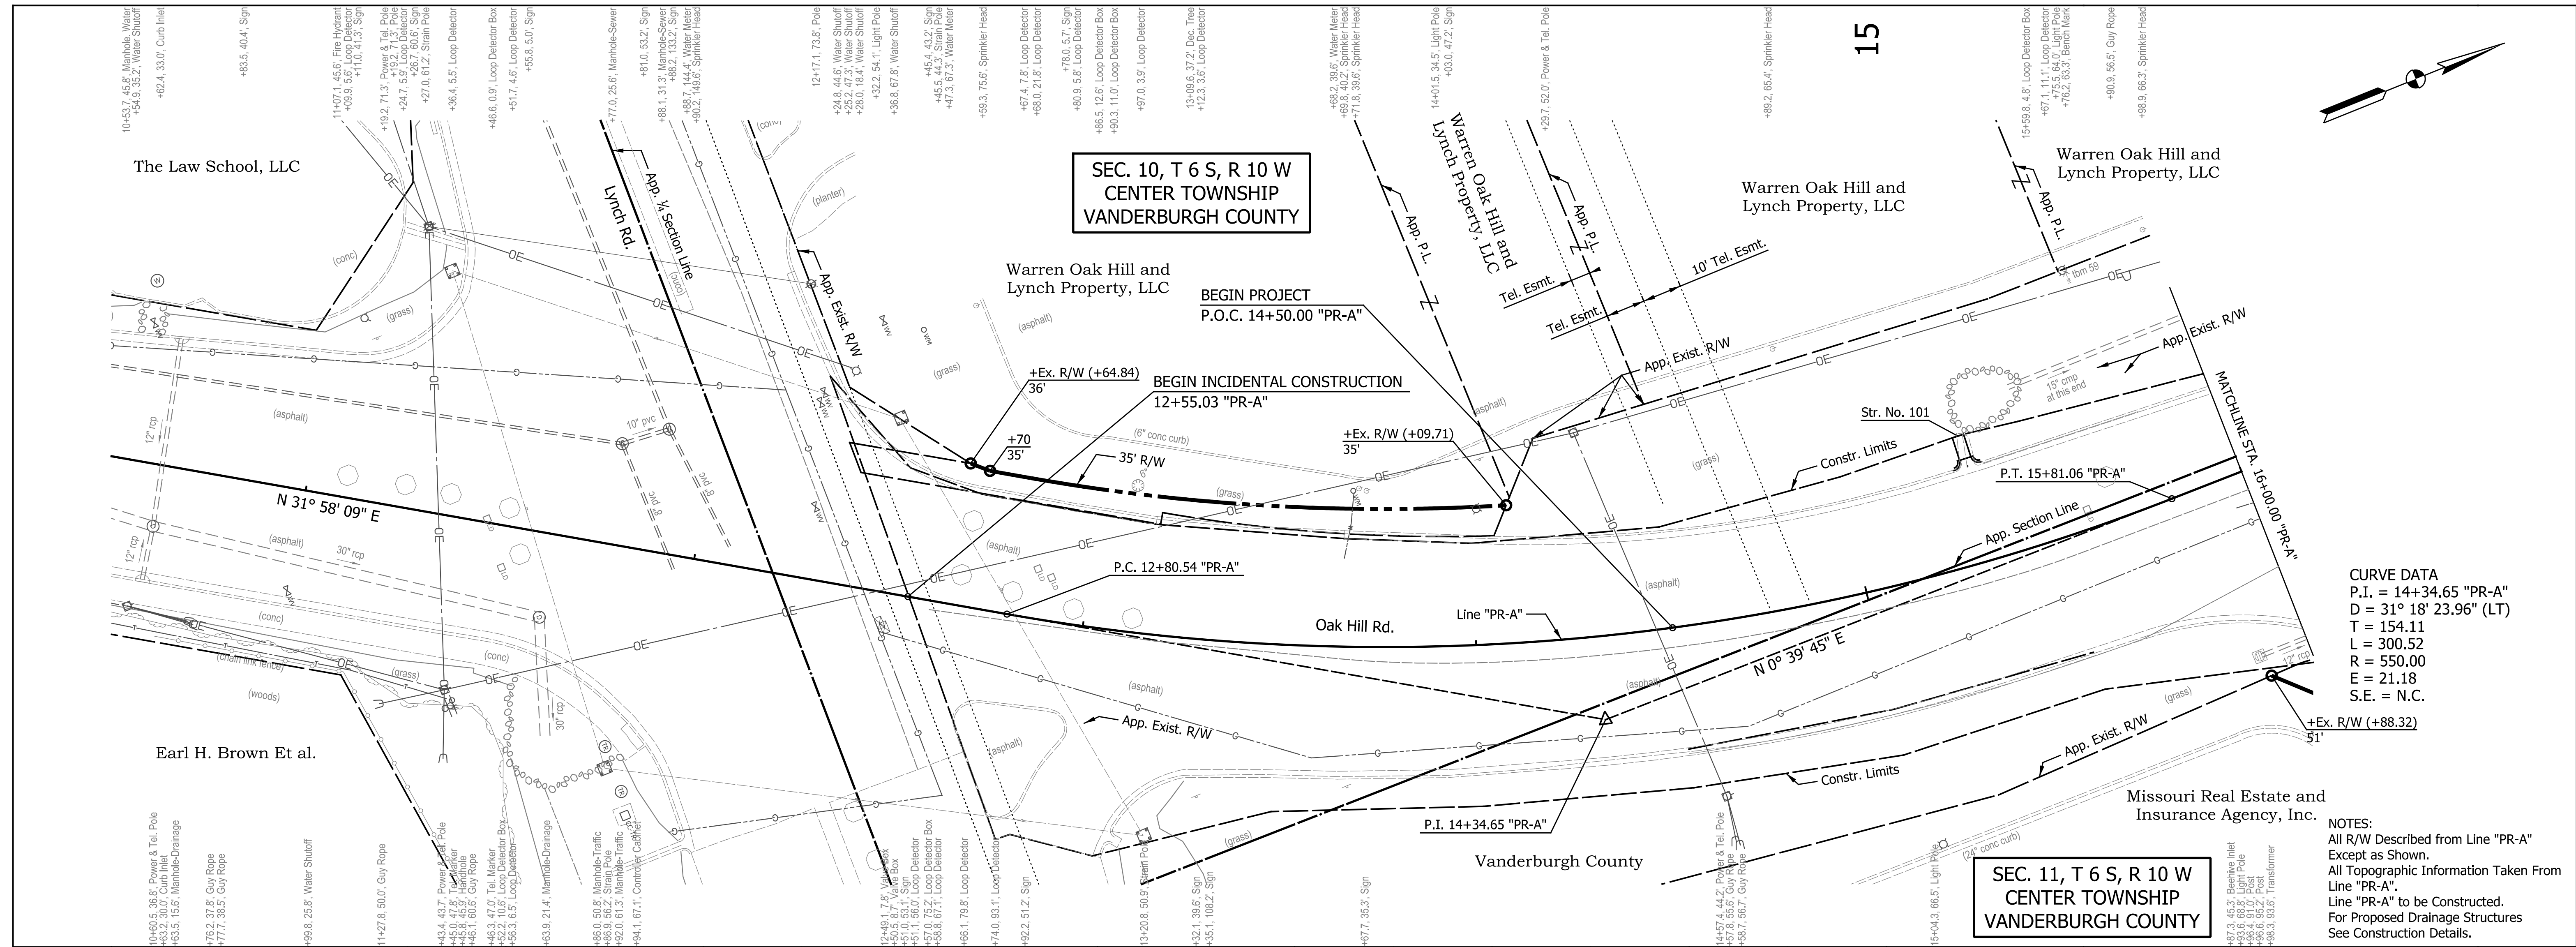**SEC. 10, T 6 S, R 10 W
CENTER TOWNSHIP
VANDERBURGH COUNTY**

**SEC. 11, T 6 S, R 10 W
CENTER TOWNSHIP
VANDERBURGH COUNTY**

CURVE DATA
 P.I. = 14+34.65 "PR-A"
 D = 31° 18' 23.96" (LT)
 T = 154.11
 L = 300.52
 R = 550.00
 E = 21.18
 S.E. = N.C.

NOTES:
 All R/W Described from Line "PR-A"
 Except as Shown.
 All Topographic Information Taken From
 Line "PR-A".
 Line "PR-A" to be Constructed.
 For Proposed Drainage Structures
 See Construction Details.



DATE	REVISION

RECOMMENDED FOR APPROVAL	DESIGN ENGINEER	DATE
DESIGNED: JKH	DRAWN: BLP	
CHECKED: DSS	CHECKED: DSS	


**INDIANA DEPARTMENT
OF TRANSPORTATION**

**PLAN AND PROFILE
OAK HILL ROAD**


HORIZONTAL SCALE 1" = 20'	BRIDGE FILE N/A
VERTICAL SCALE 1" = 10'	DESIGNATION 2002538
SURVEY BOOK N/A	SHEETS 16 of 117
CONTRACT R-43470	PROJECT 2002538

SEC. 10, T 6 S, R 10 W
CENTER TOWNSHIP
VANDERBURGH COUNTY

SEC. 11, T 6 S, R 10 W
CENTER TOWNSHIP
VANDERBURGH COUNTY

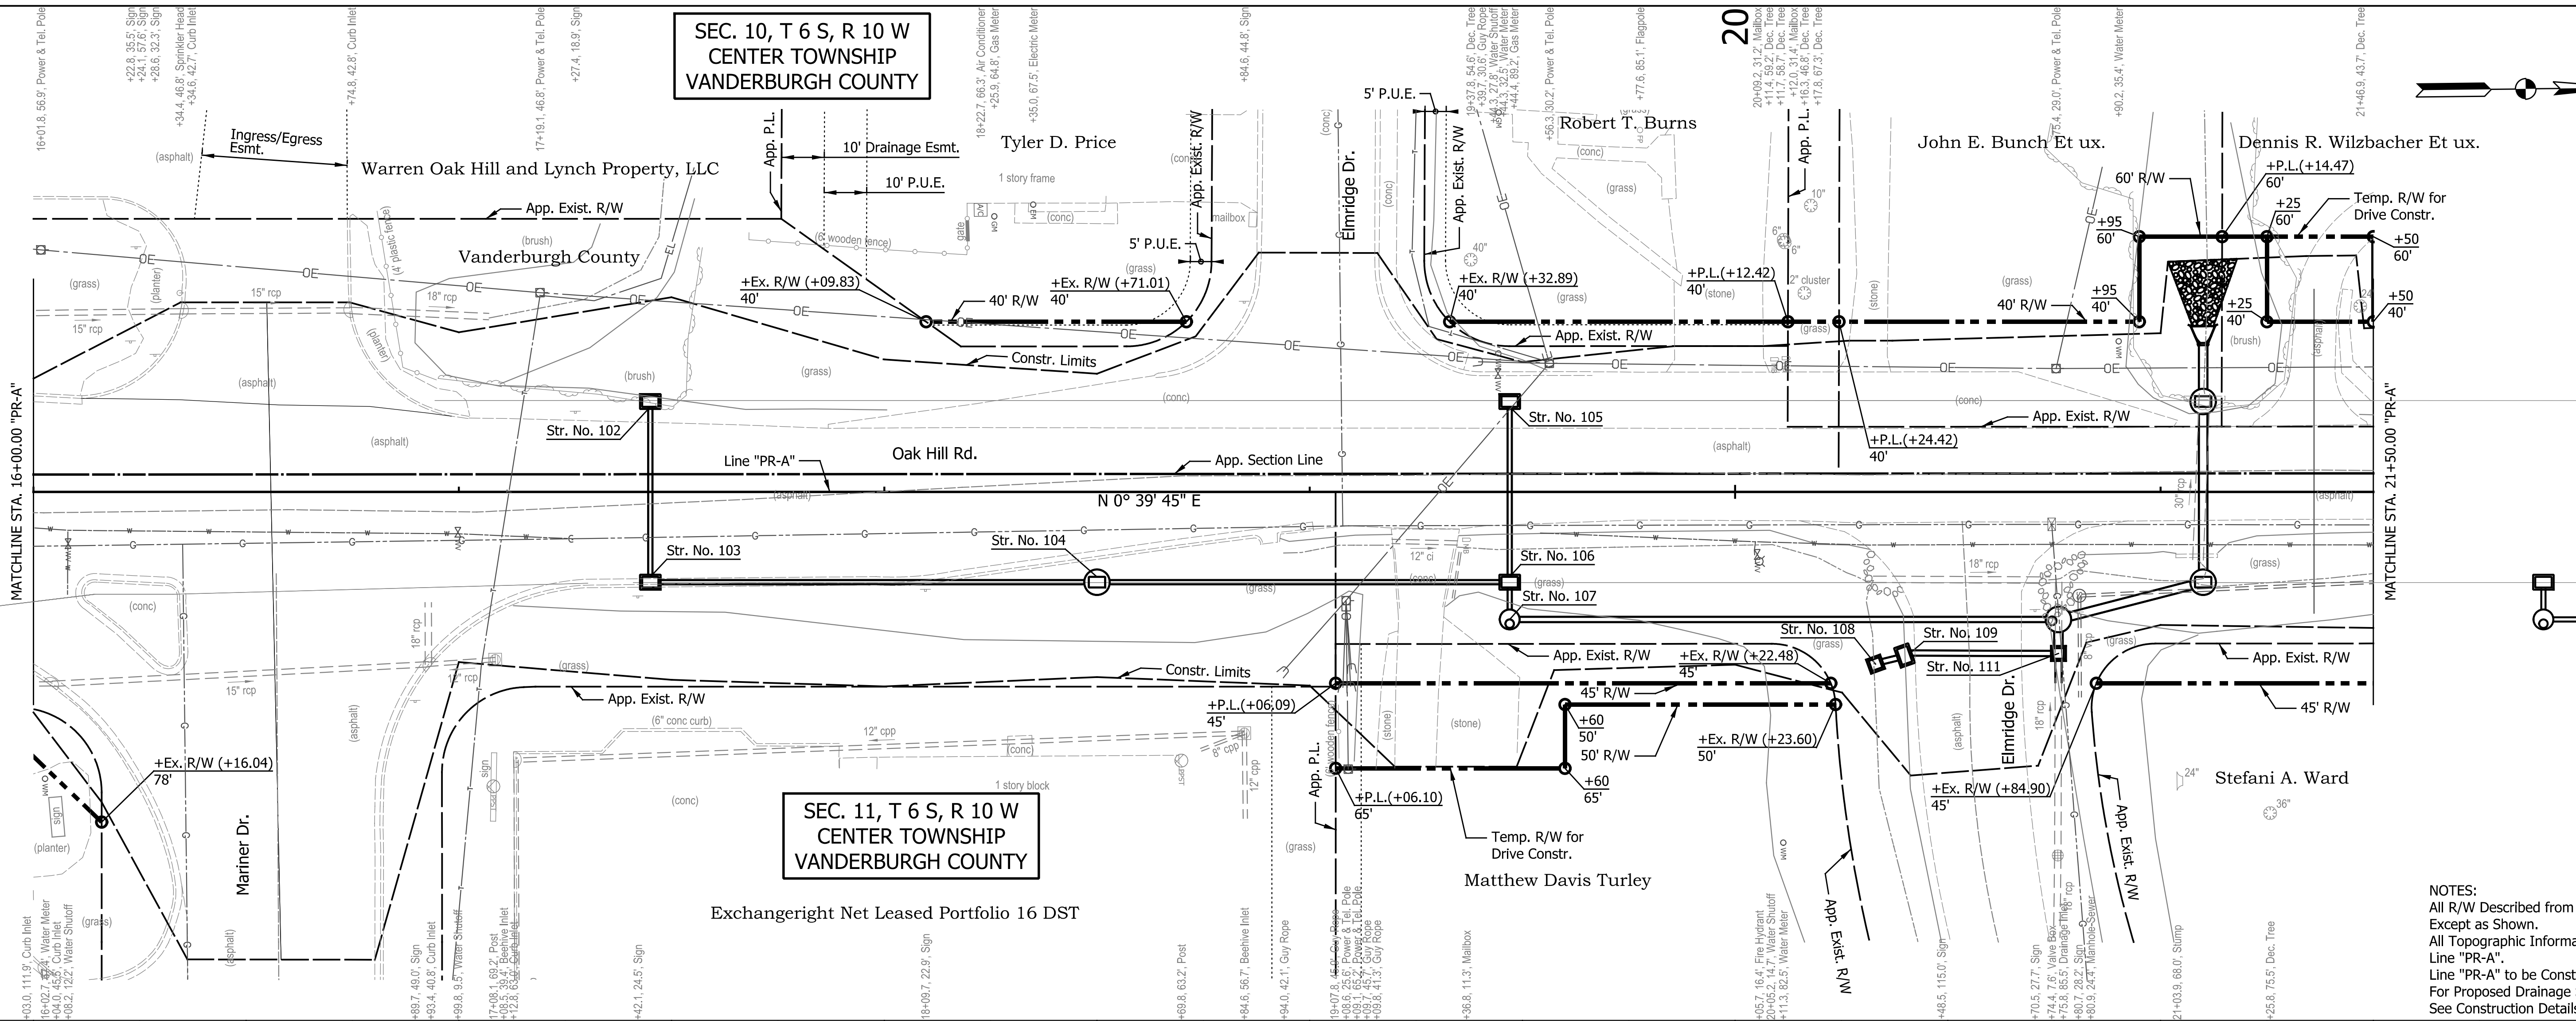

NOTES:
All R/W Described from Line "PR-A"
Except as Shown.
All Topographic Information Taken From
Line "PR-A".
Line "PR-A" to be Constructed.
For Proposed Drainage Structures
See Construction Details.

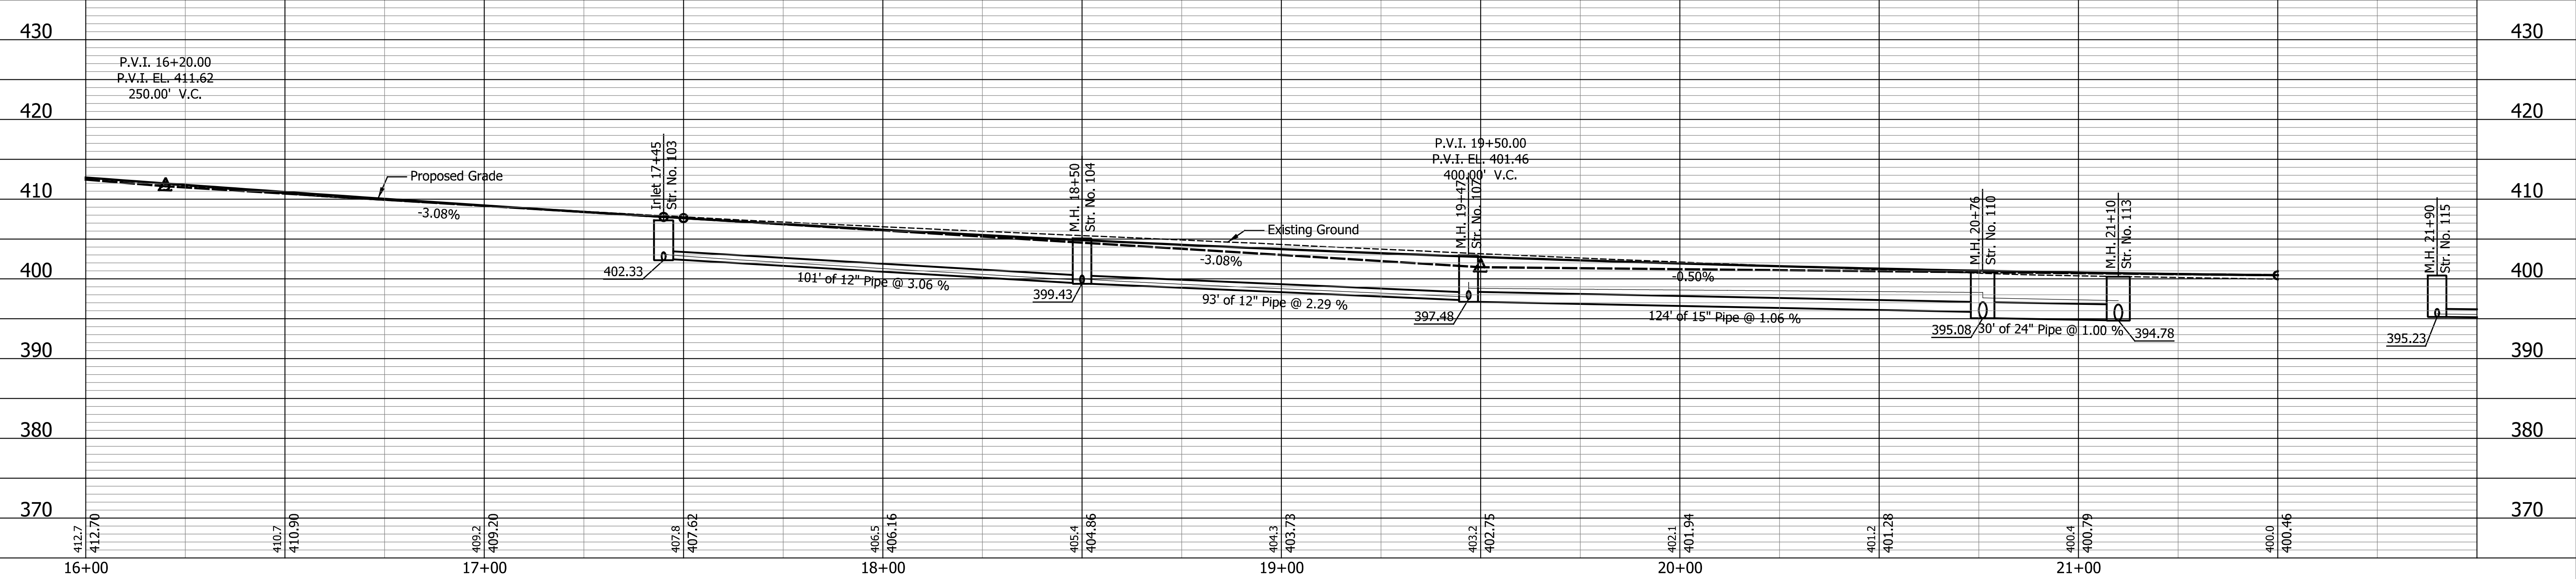

DATE	REVISION



RECOMMENDED FOR APPROVAL	DESIGN ENGINEER	DATE
DESIGNED: JKH	DRAWN: BLP	
CHECKED: DSS	CHECKED: DSS	

INDIANA DEPARTMENT
OF TRANSPORTATION

PLAN AND PROFILE
OAK HILL ROAD


HORIZONTAL SCALE	BRIDGE FILE
1" = 20'	N/A
VERTICAL SCALE	DESIGNATION
1" = 10'	2002538
SURVEY BOOK	SHEETS
N/A	17 of 117
CONTRACT	PROJECT
R-43470	2002538

SEC. 10, T 6 S, R 10 W
CENTER TOWNSHIP
VANDERBURGH COUNTY

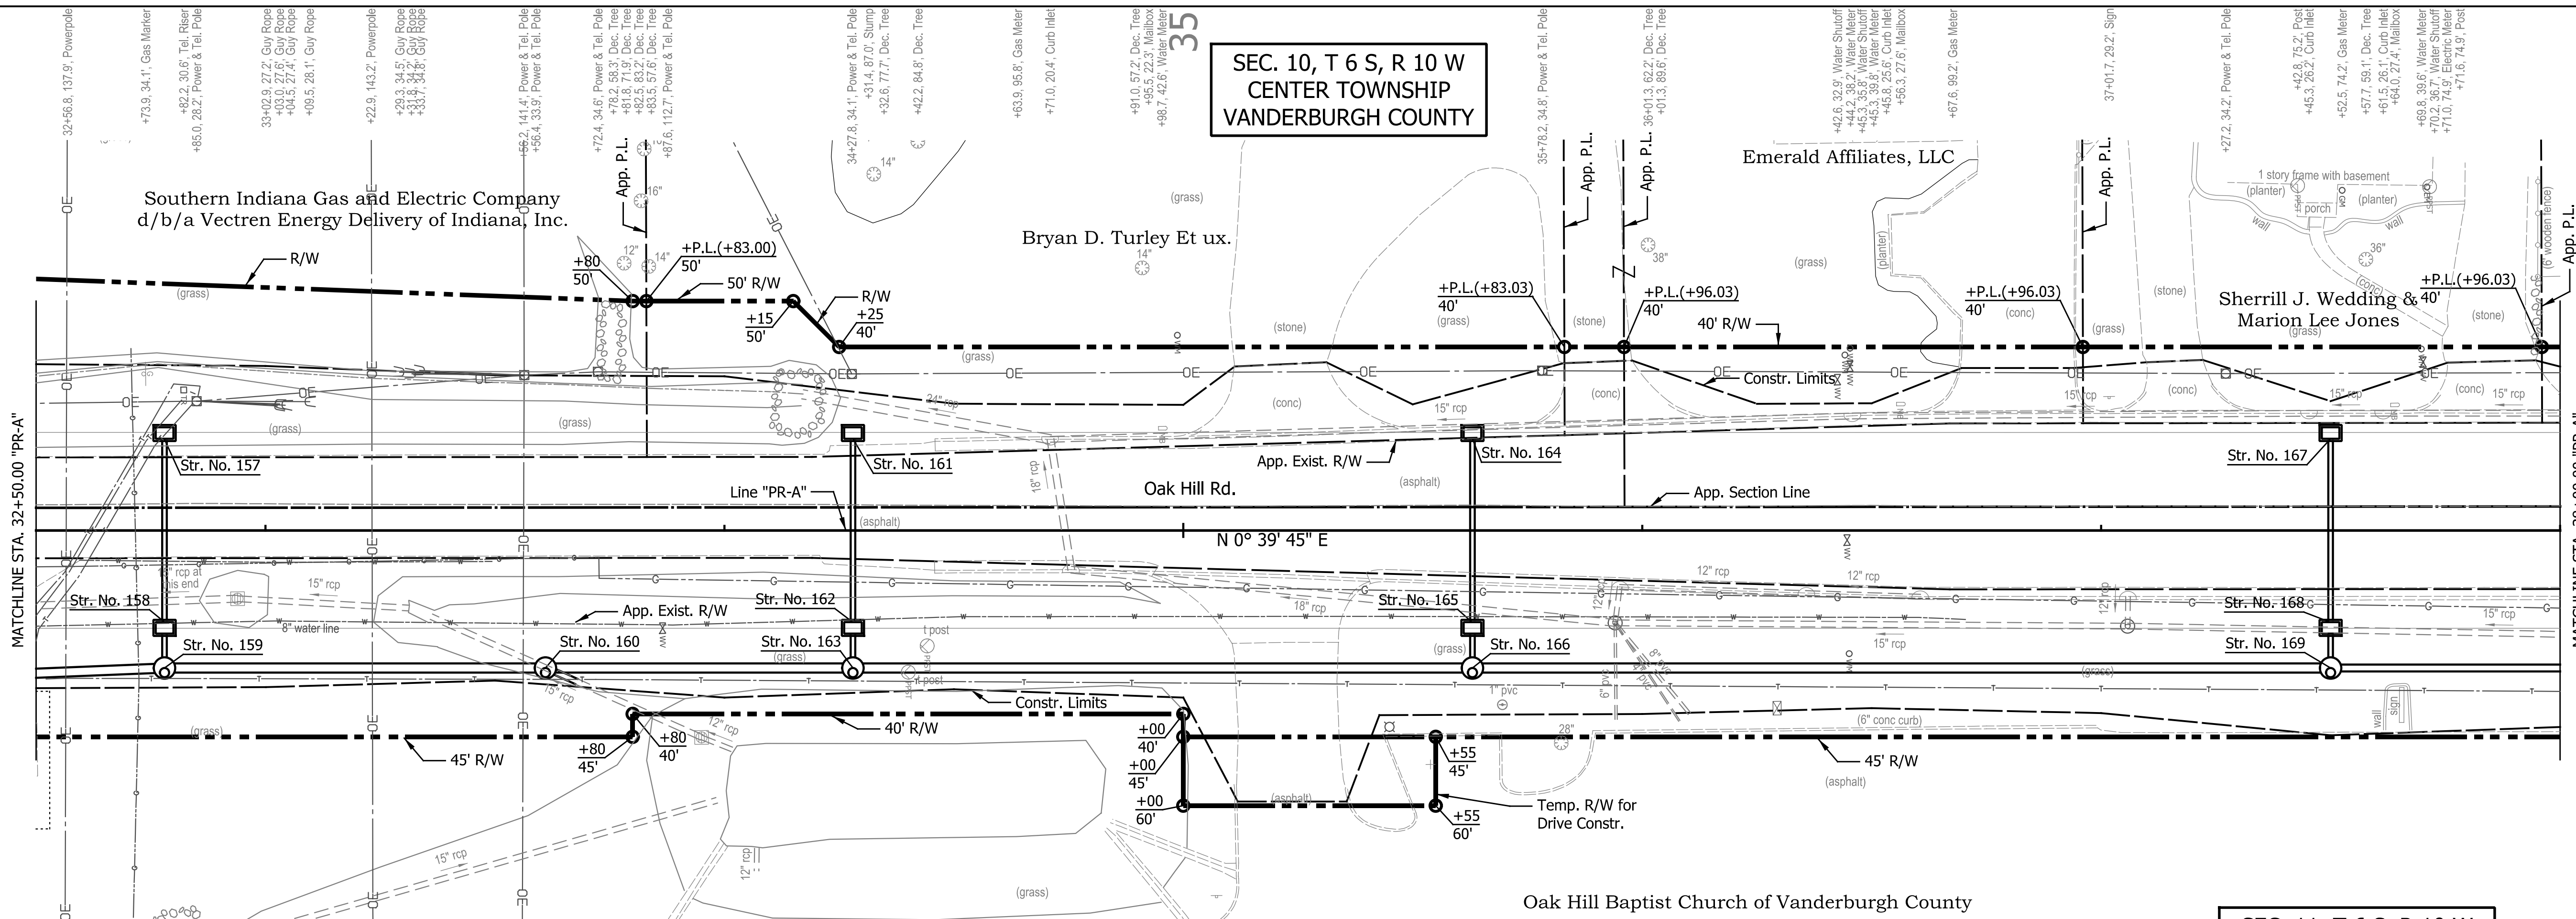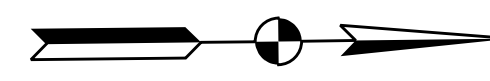

SEC. 11, T 6 S, R 10 W
CENTER TOWNSHIP
VANDERBURGH COUNTY

NOTES:
All R/W Described from Line "PR-A"
Except as Shown.
All Topographic Information Taken From
Line "PR-A".
Line "PR-A" to be Constructed.
For Proposed Drainage Structures
See Construction Details.

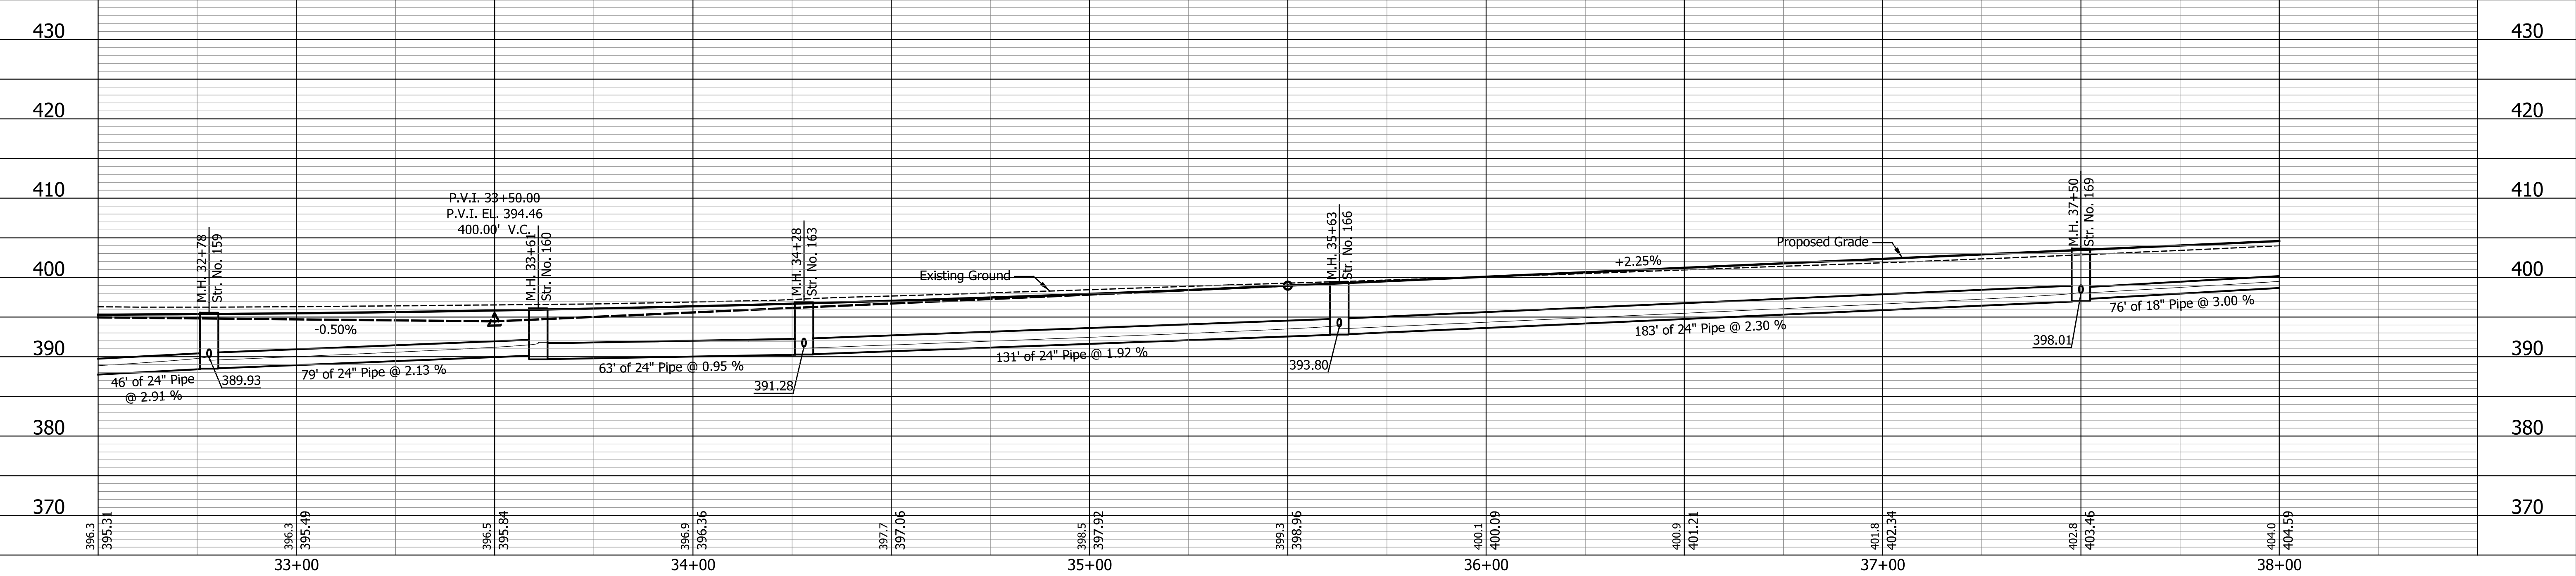



DATE	REVISION

RECOMMENDED FOR APPROVAL	DESIGN ENGINEER	DATE
DESIGNED: JKH	DRAWN: BLP	
CHECKED: DSS	CHECKED: DSS	

INDIANA DEPARTMENT
OF TRANSPORTATION


PLAN AND PROFILE
OAK HILL ROAD

HORIZONTAL SCALE	BRIDGE FILE
1" = 20'	N/A
VERTICAL SCALE	DESIGNATION
1" = 10'	2002538
SURVEY BOOK	SHEETS
N/A	20 of 117
CONTRACT	PROJECT
R-43470	2002538

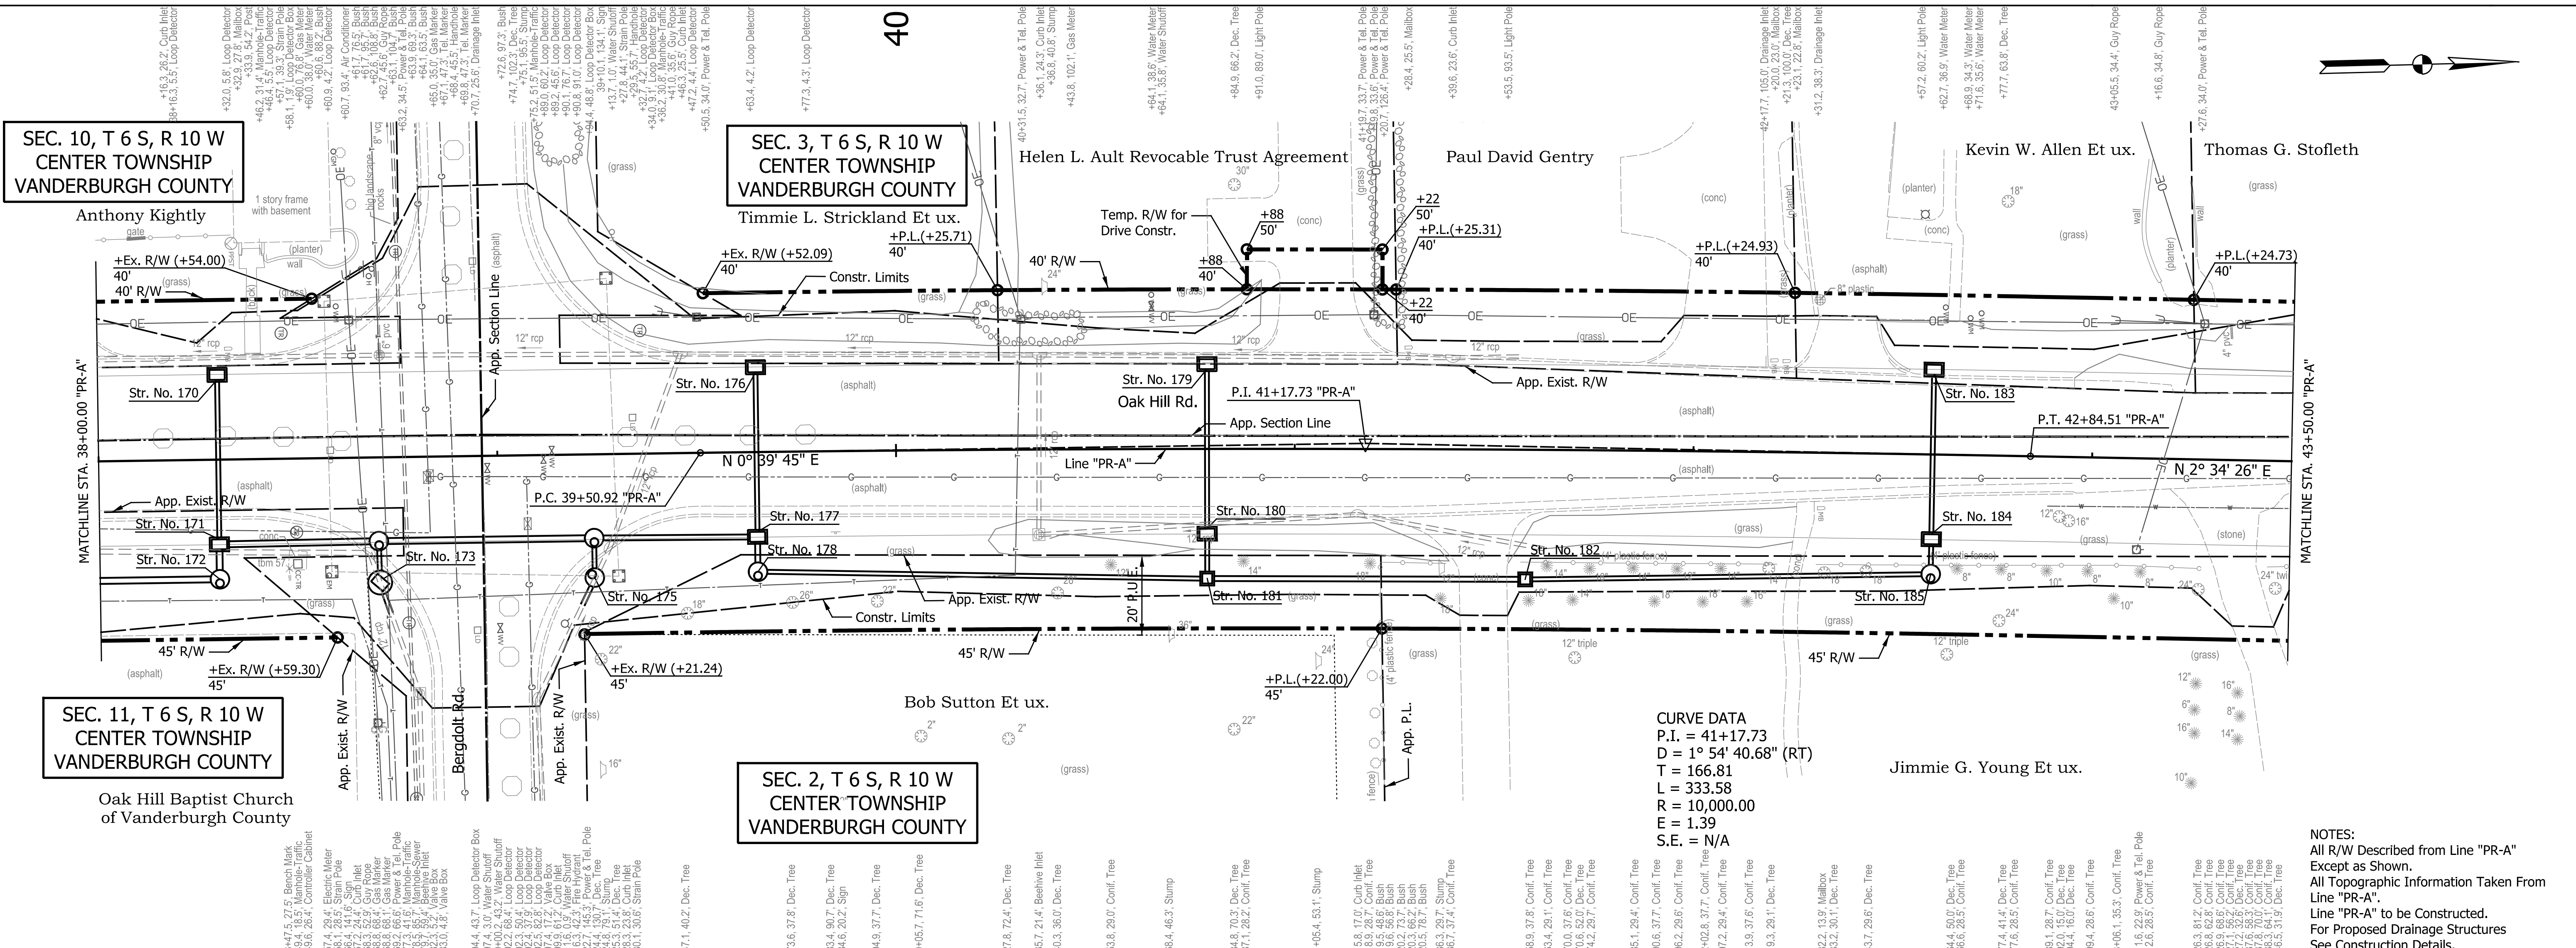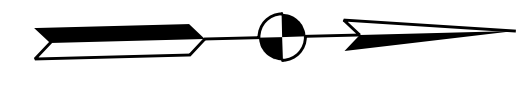

CURVE DATA
 P.I. = 41+17.73
 D = 1° 54' 40.68" (RT)
 T = 166.81
 L = 333.58
 R = 10,000.00
 E = 1.39
 S.E. = N/A

NOTES:
 All R/W Described from Line "PR-A"
 Except as Shown.
 All Topographic Information Taken From
 Line "PR-A".
 Line "PR-A" to be Constructed.
 For Proposed Drainage Structures
 See Construction Details.

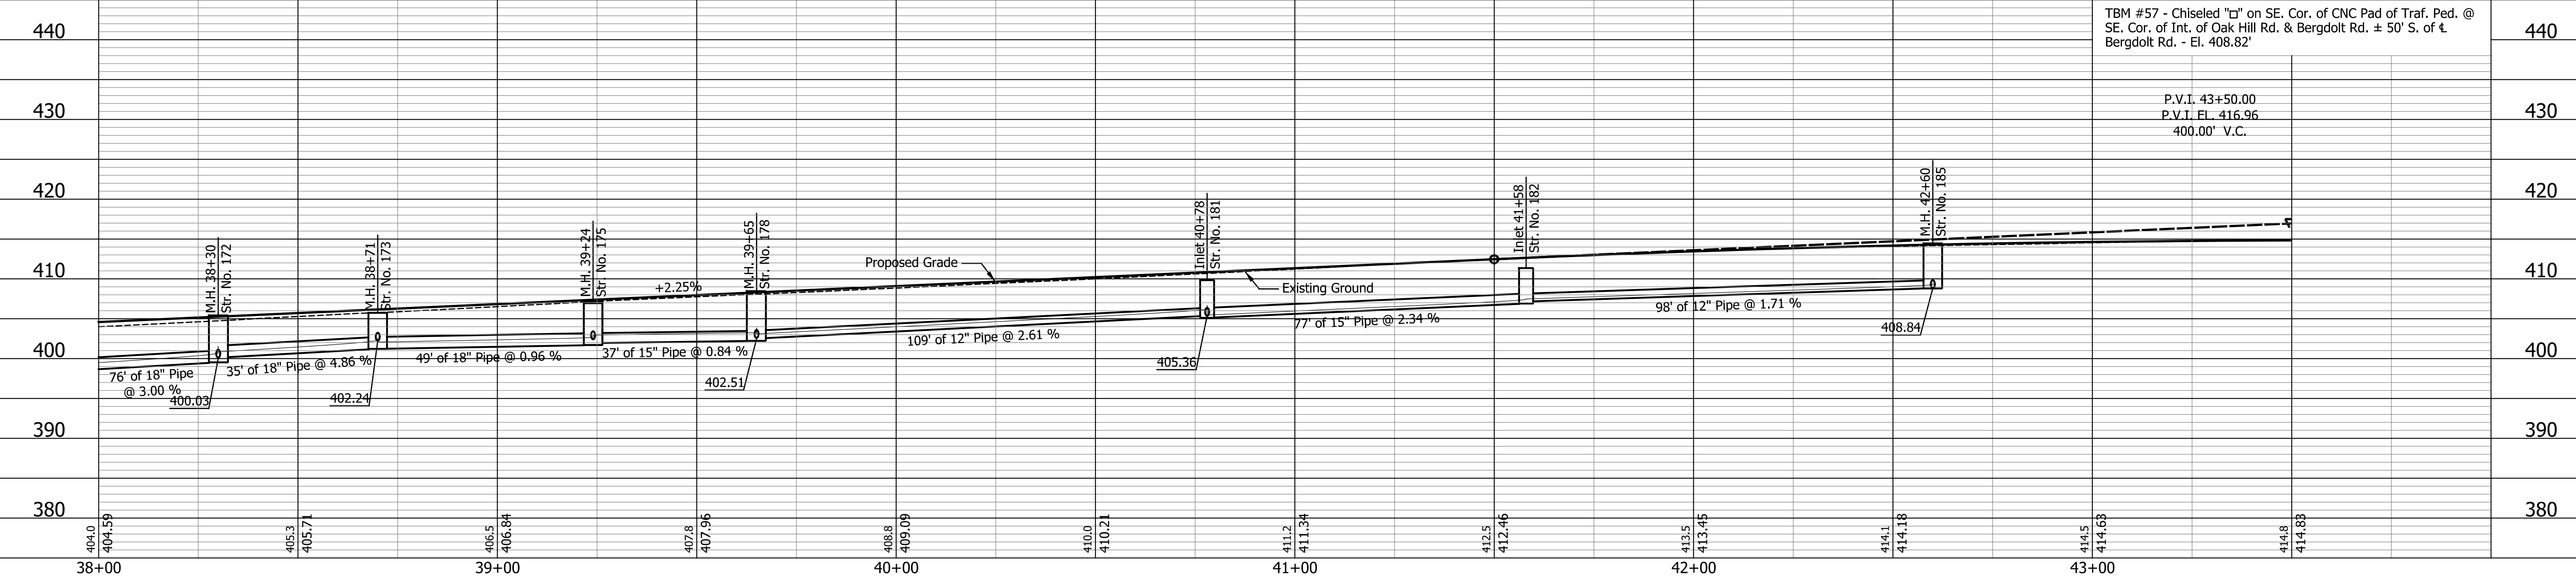

DATE	REVISION

RECOMMENDED FOR APPROVAL	DESIGN ENGINEER	DATE
DESIGNED: JKH	DRAWN: BLP	
CHECKED: DSS	CHECKED: DSS	

INDIANA DEPARTMENT OF TRANSPORTATION



PLAN AND PROFILE

OAK HILL ROAD

HORIZONTAL SCALE	BRIDGE FILE
1" = 20'	N/A
VERTICAL SCALE	DESIGNATION
1" = 10'	2002538
SURVEY BOOK	SHEETS
N/A	21 of 117
CONTRACT	PROJECT
R-43470	2002538


SEC. 3, T 6 S, R 10 W
CENTER TOWNSHIP
VANDERBURGH COUNTY

SEC. 2, T 6 S, R 10 W
CENTER TOWNSHIP
VANDERBURGH COUNTY

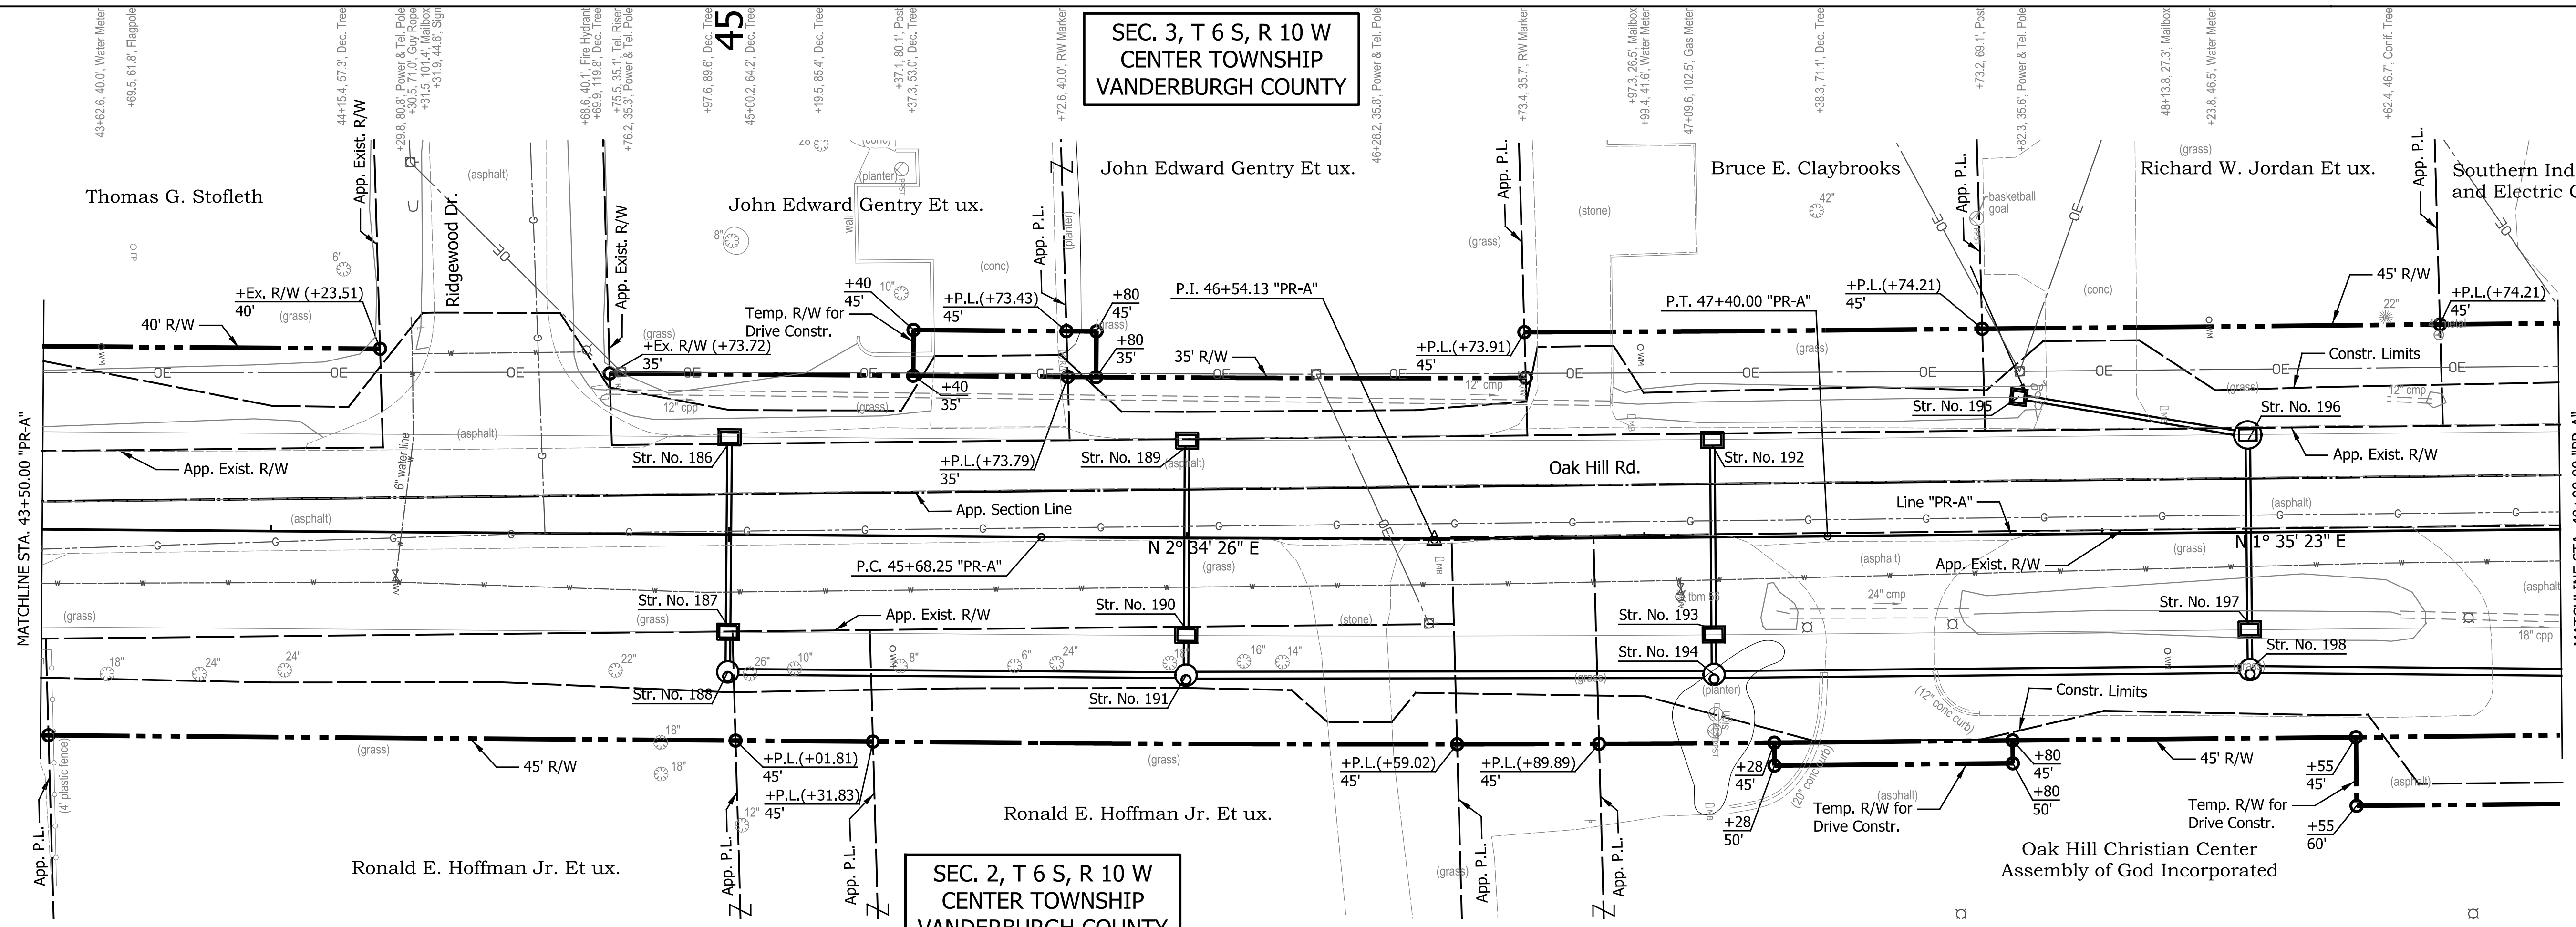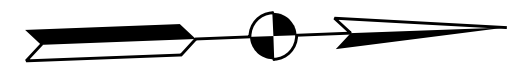

CURVE DATA
 P.I. = 46+54.13 "PR-A"
 D = 0° 59' 02.61" (LT)
 T = 85.88
 L = 171.75
 R = 10,000.00
 E = 0.37
 S.E. = N/A

NOTES:
 All R/W Described from Line "PR-A"
 Except as Shown.
 All Topographic Information Taken From
 Line "PR-A".
 Line "PR-A" to be Constructed.
 For Proposed Drainage Structures
 See Construction Details.

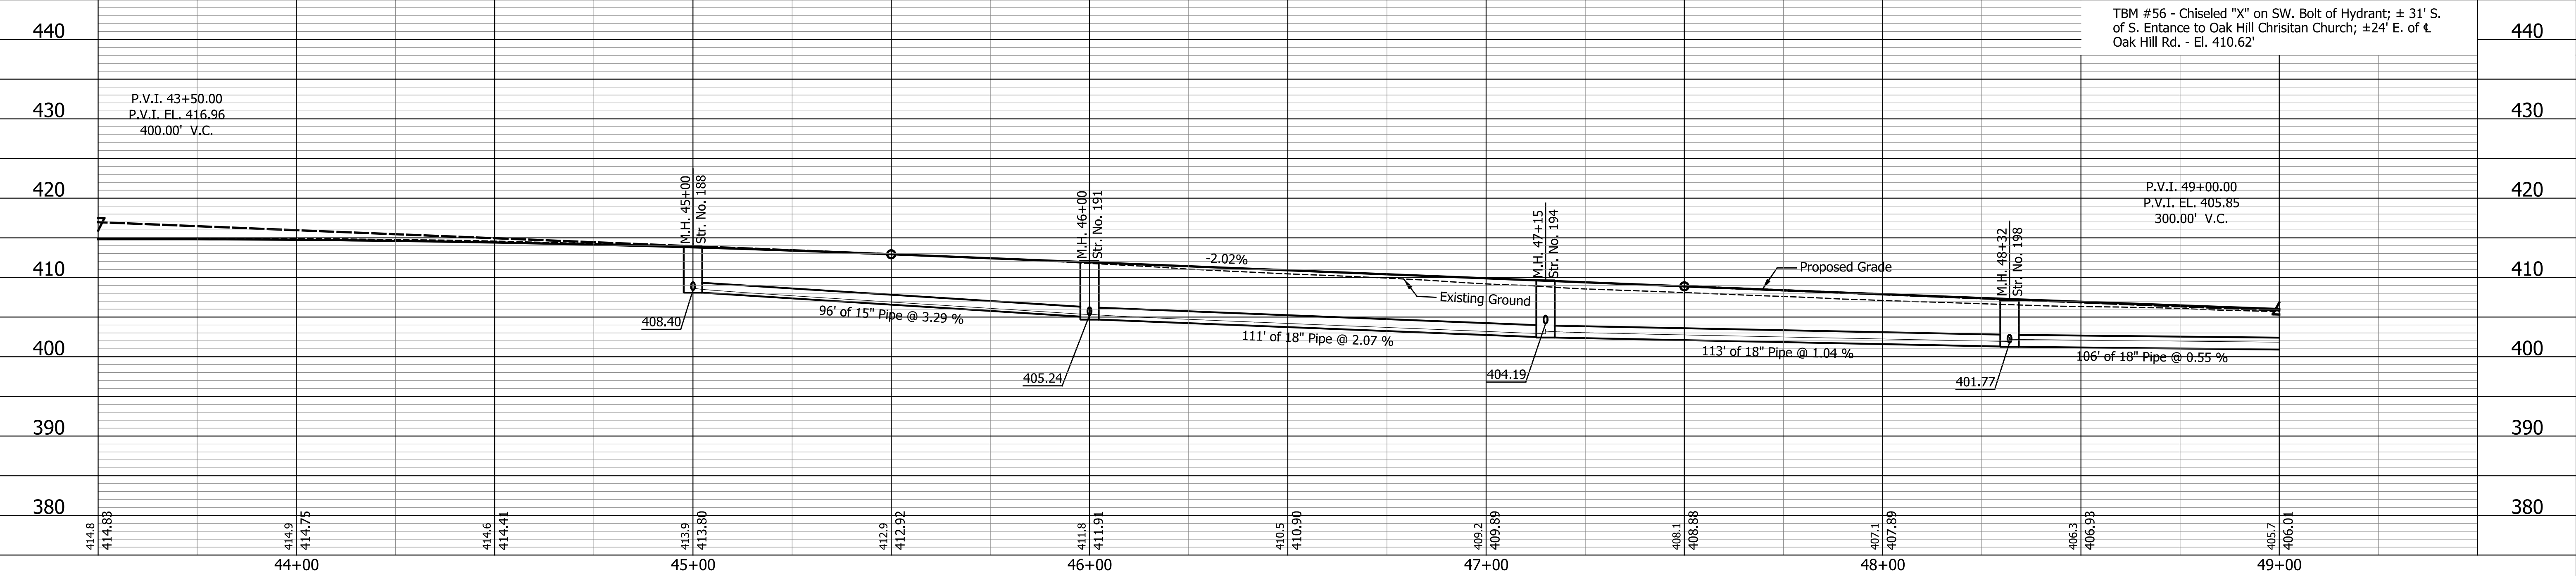

TBM #56 - Chiseled "X" on SW. Bolt of Hydrant; ± 31' S. of S. Entrance to Oak Hill Christian Church; ± 24' E. of Oak Hill Rd. - El. 410.62'

DATE	REVISION



RECOMMENDED FOR APPROVAL	DESIGN ENGINEER	DATE
DESIGNED: JKH	DRAWN: BLP	
CHECKED: DSS	CHECKED: DSS	

INDIANA DEPARTMENT OF TRANSPORTATION
PLAN AND PROFILE
OAK HILL ROAD

HORIZONTAL SCALE 1" = 20'	BRIDGE FILE N/A
VERTICAL SCALE 1" = 10'	DESIGNATION 2002538
SURVEY BOOK N/A	SHEETS 22 of 117
CONTRACT R-43470	PROJECT 2002538

SEC. 3, T 6 S, R 10 W
CENTER TOWNSHIP
VANDERBURGH COUNTY

SEC. 2, T 6 S, R 10 W
CENTER TOWNSHIP
VANDERBURGH COUNTY

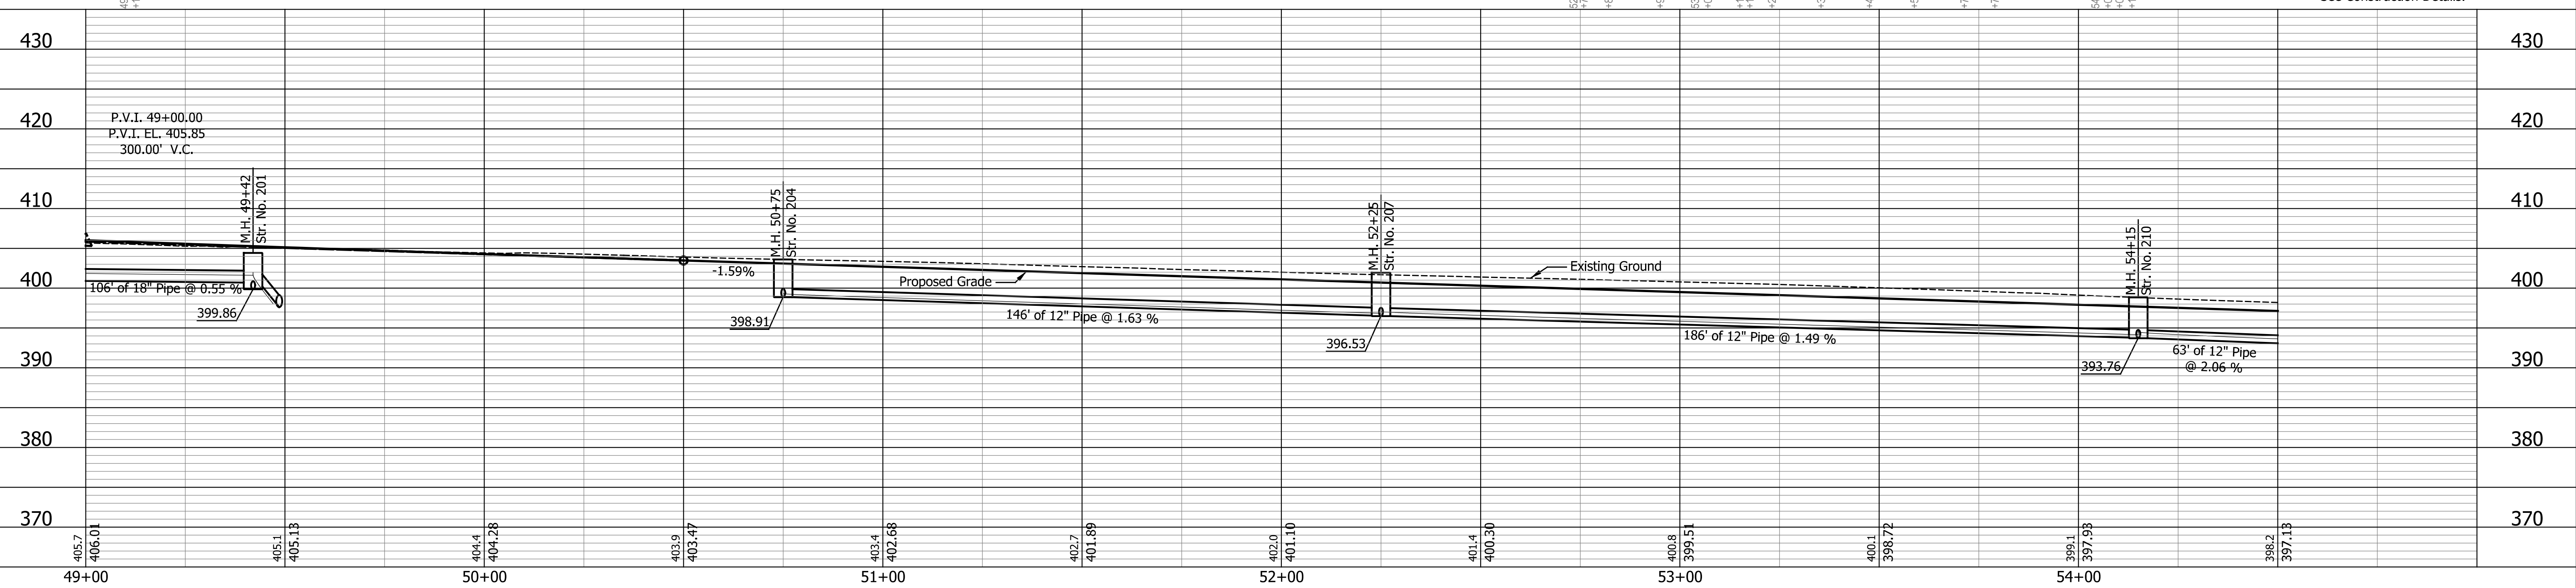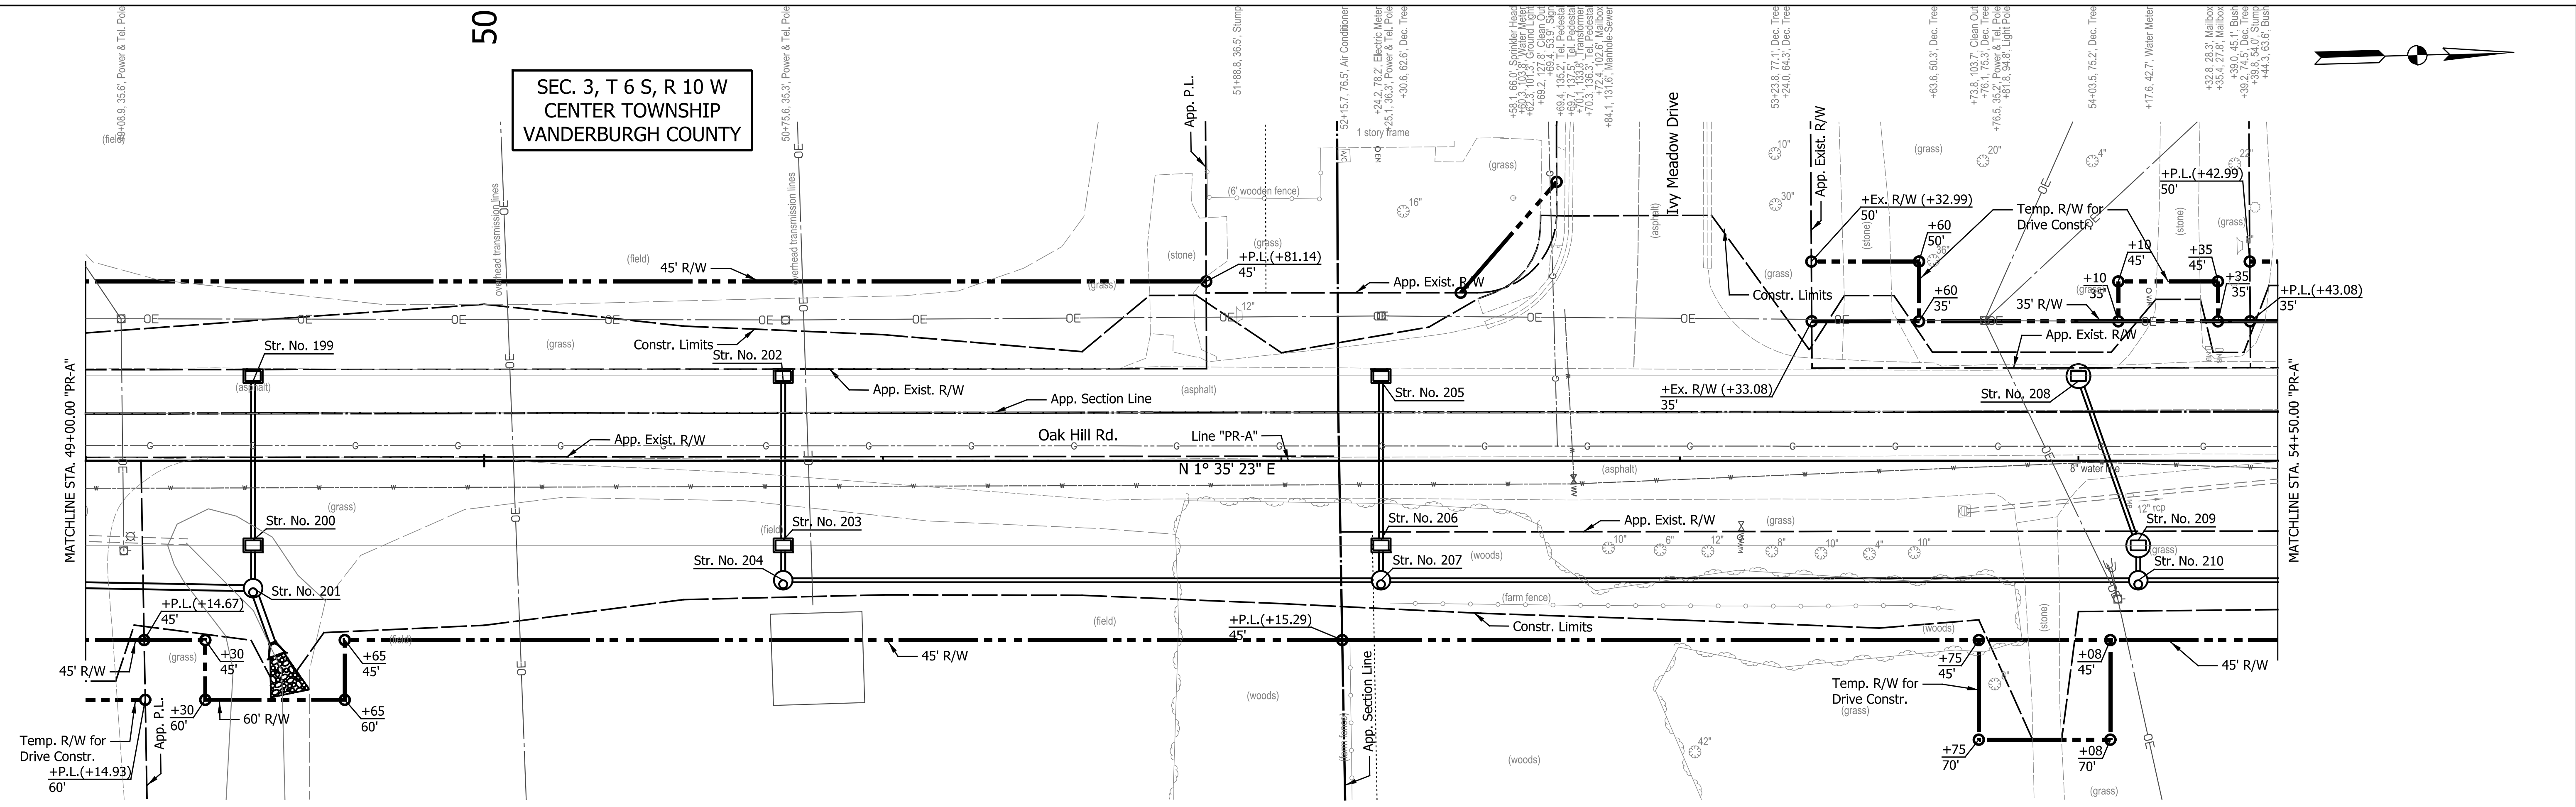

NOTES:
All R/W Described from Line "PR-A"
Except as Shown.
All Topographic Information Taken From
Line "PR-A".
Line "PR-A" to be Constructed.
For Proposed Drainage Structures
See Construction Details.



DATE	REVISION

RECOMMENDED FOR APPROVAL	DESIGN ENGINEER	DATE
DESIGNED: JKH	DRAWN: BLP	
CHECKED: DSS	CHECKED: DSS	

INDIANA DEPARTMENT
OF TRANSPORTATION

PLAN AND PROFILE
OAK HILL ROAD

HORIZONTAL SCALE	BRIDGE FILE
1" = 20'	N/A
VERTICAL SCALE	DESIGNATION
1" = 10'	2002538
SURVEY BOOK	SHEETS
N/A	23 of 117
CONTRACT	PROJECT
R-43470	2002538

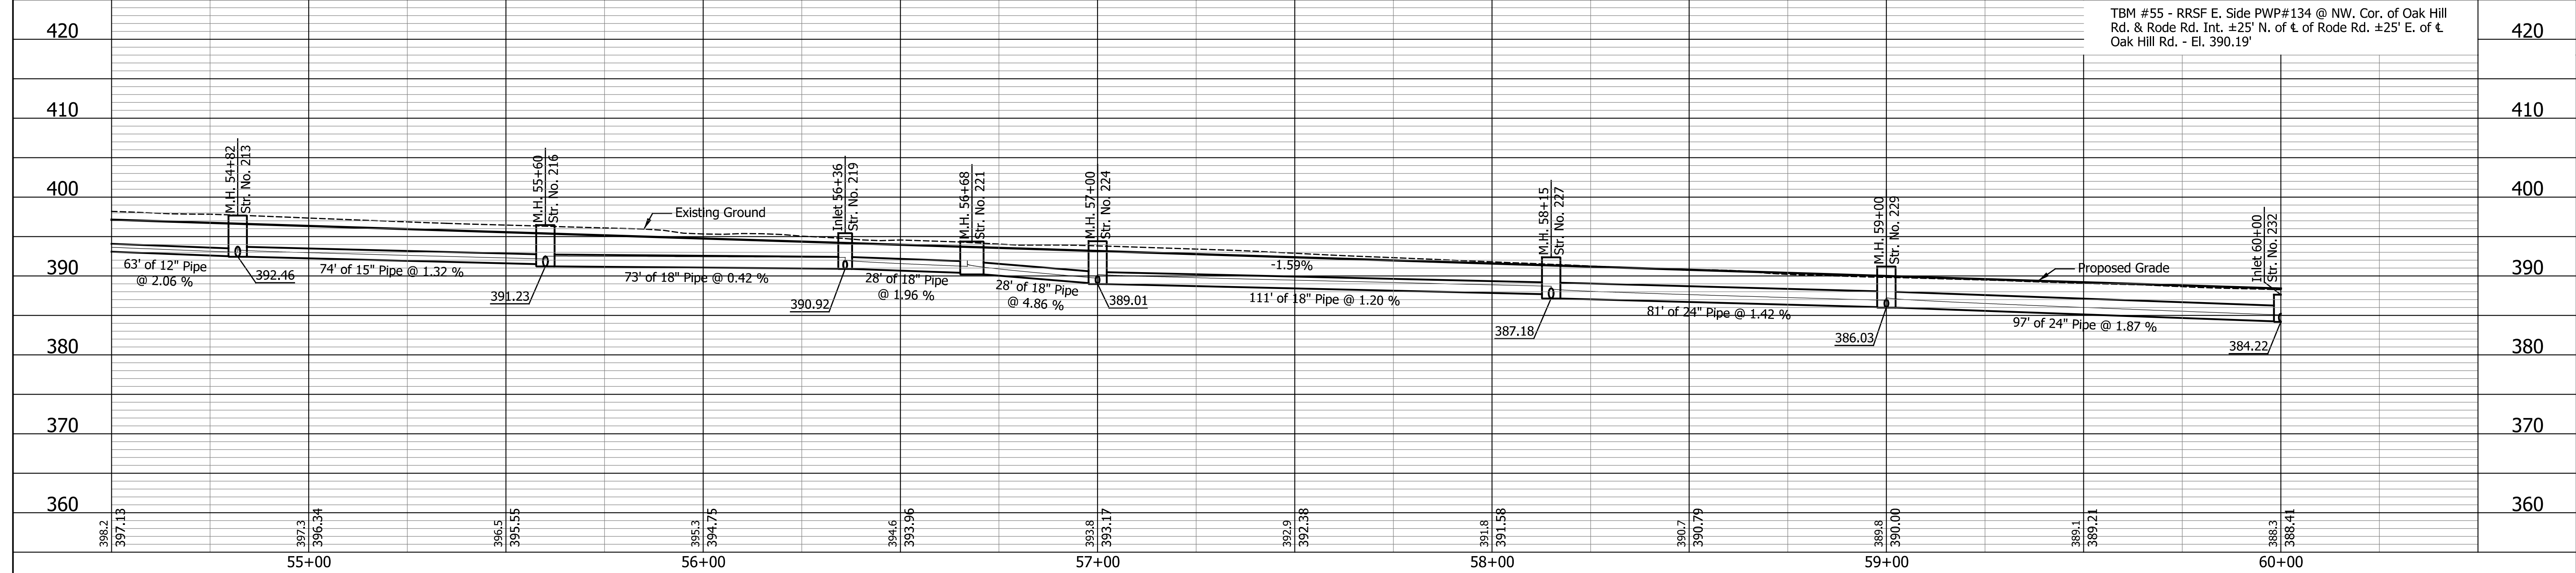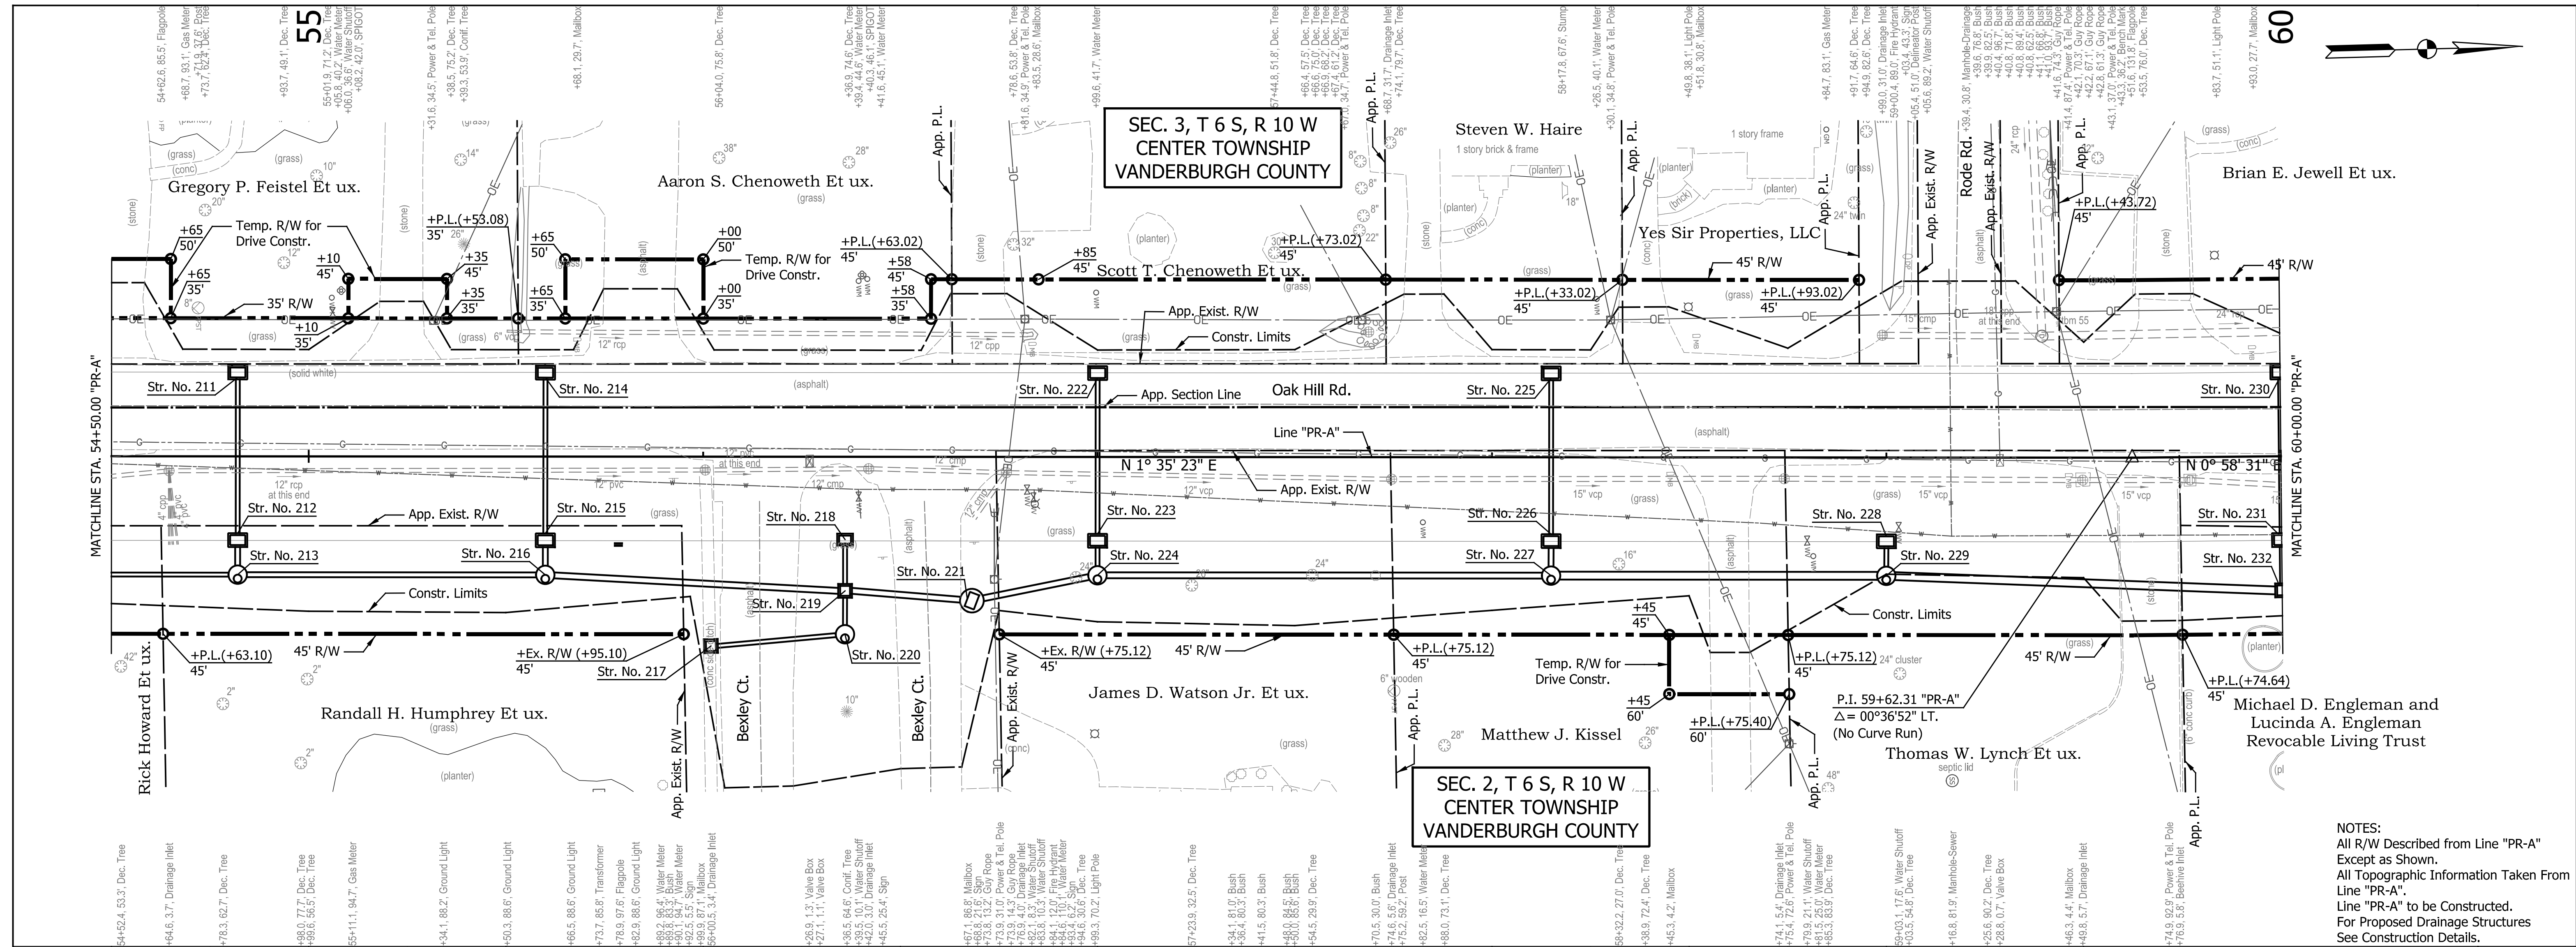

NOTES:
 All R/W Described from Line "PR-A"
 Except as Shown.
 All Topographic Information Taken From
 Line "PR-A".
 Line "PR-A" to be Constructed.
 For Proposed Drainage Structures
 See Construction Details.


TBM #55 - RRSF E. Side PWP#134 @ NW. Cor. of Oak Hill Rd. & Rode Rd. Int. ±25' N. of ̸ of Rode Rd. ±25' E. of ̸ of Oak Hill Rd. - El. 390.19'

DATE	REVISION

RECOMMENDED FOR APPROVAL	DESIGN ENGINEER	DATE
DESIGNED: JKH	DRAWN: BLP	
CHECKED: DSS	CHECKED: DSS	

INDIANA DEPARTMENT OF TRANSPORTATION
 PLAN AND PROFILE
 OAK HILL ROAD


HORIZONTAL SCALE	BRIDGE FILE
1" = 20'	N/A
VERTICAL SCALE	DESIGNATION
1" = 10'	2002538
SURVEY BOOK	SHEETS
N/A	24 of 117
CONTRACT	PROJECT
R-43470	2002538

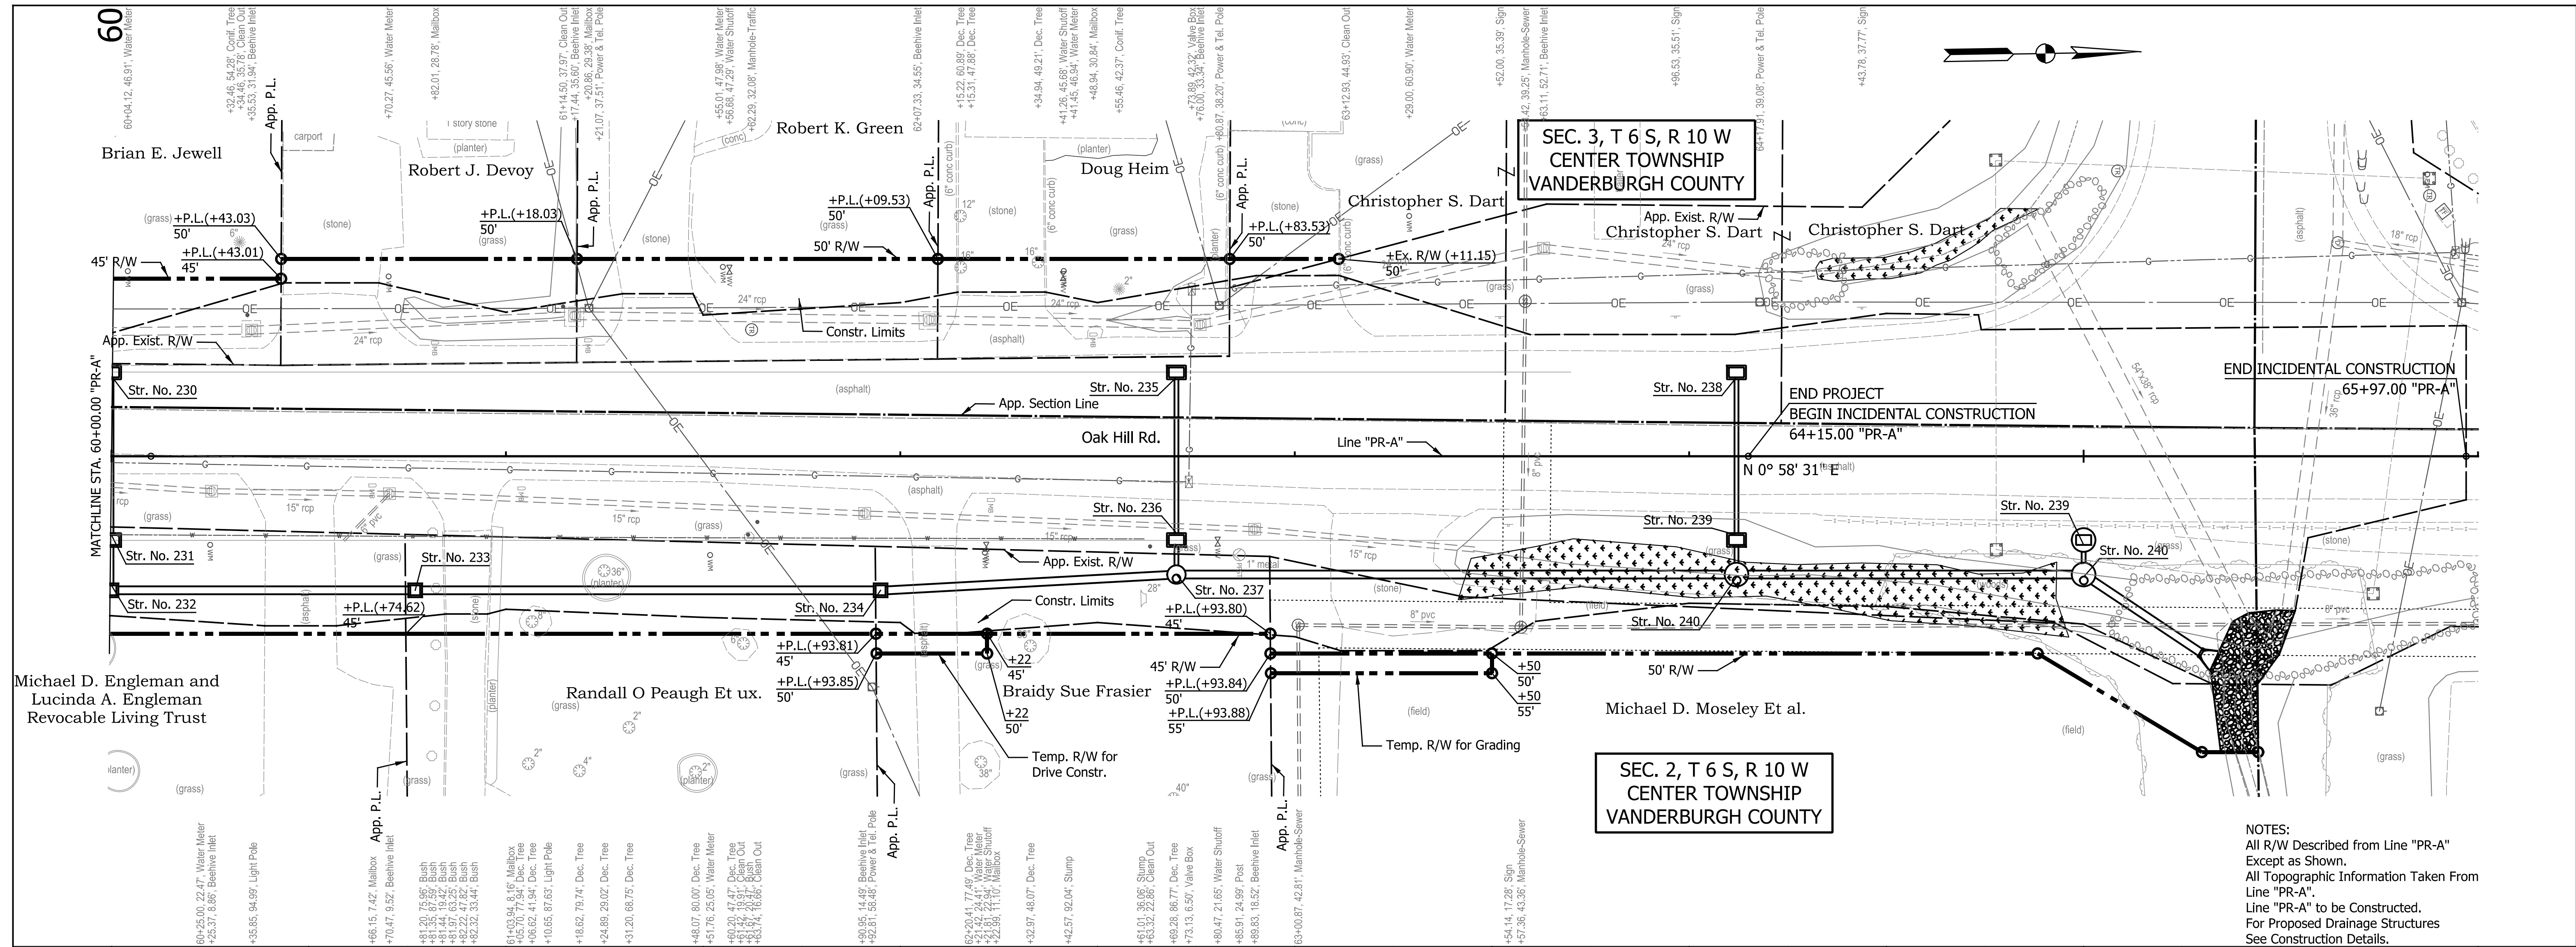

SEC. 3, T 6 S, R 10 W
CENTER TOWNSHIP
VANDERBURGH COUNTY

SEC. 2, T 6 S, R 10 W
CENTER TOWNSHIP
VANDERBURGH COUNTY

NOTES:
All R/W Described from Line "PR-A"
Except as Shown.
All Topographic Information Taken From
Line "PR-A".
Line "PR-A" to be Constructed.
For Proposed Drainage Structures
See Construction Details.

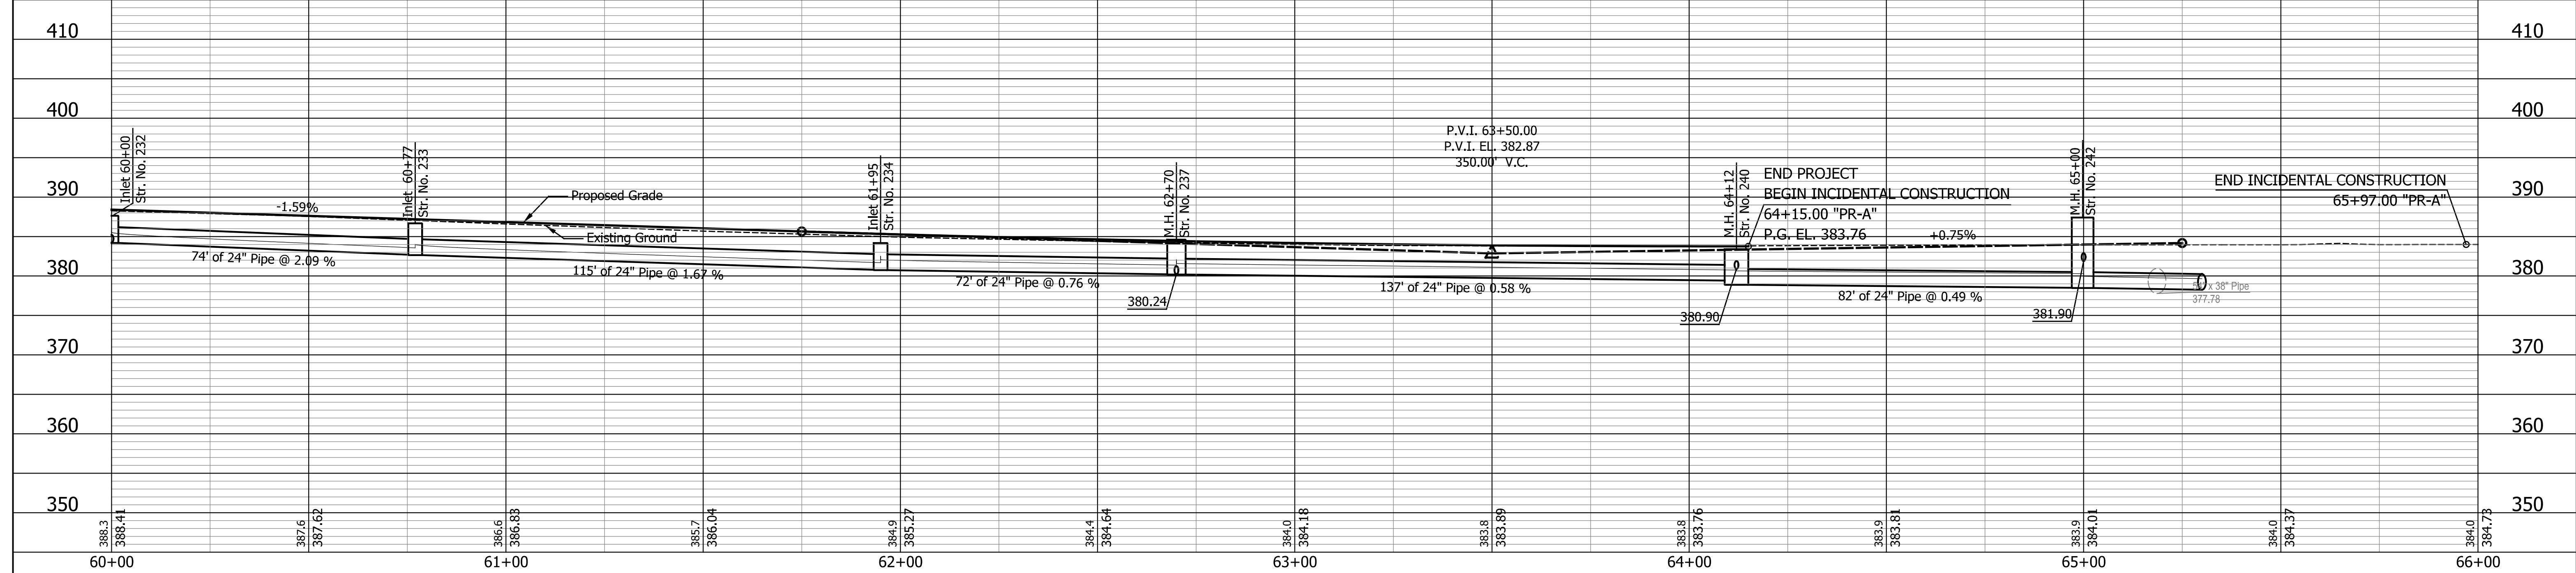

DATE	REVISION


RECOMMENDED FOR APPROVAL	DESIGN ENGINEER	DATE
DESIGNED: JKH	DRAWN: BLP	
CHECKED: DSS	CHECKED: DSS	

VANDERBURGH COUNTY
DEPARTMENT OF ENGINEERING

PLAN AND PROFILE
OAK HILL ROAD


HORIZONTAL SCALE	BRIDGE FILE
1" = 20'	N/A
VERTICAL SCALE	DESIGNATION
1" = 10'	2002538
SURVEY BOOK	SHEETS
N/A	25 of 117
CONTRACT	PROJECT
VCXX-XX-XX	N/A

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SEC. 10, T 6 S, R 10 W
CENTER TOWNSHIP
VANDERBURGH COUNTY

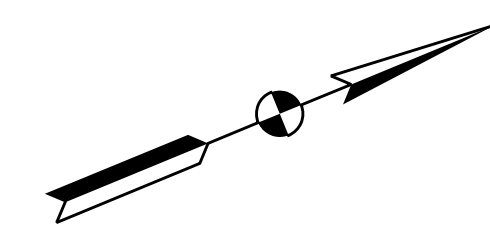SEC. 11, T 6 S, R 10 W
CENTER TOWNSHIP
VANDERBURGH COUNTY



CURVE DATA
P.I. = 14+34.65 "PR-A"
D = 31° 18' 23.96" (LT)
T = 154.11
L = 300.52
R = 550.00
E = 21.18
S.E. = N/A

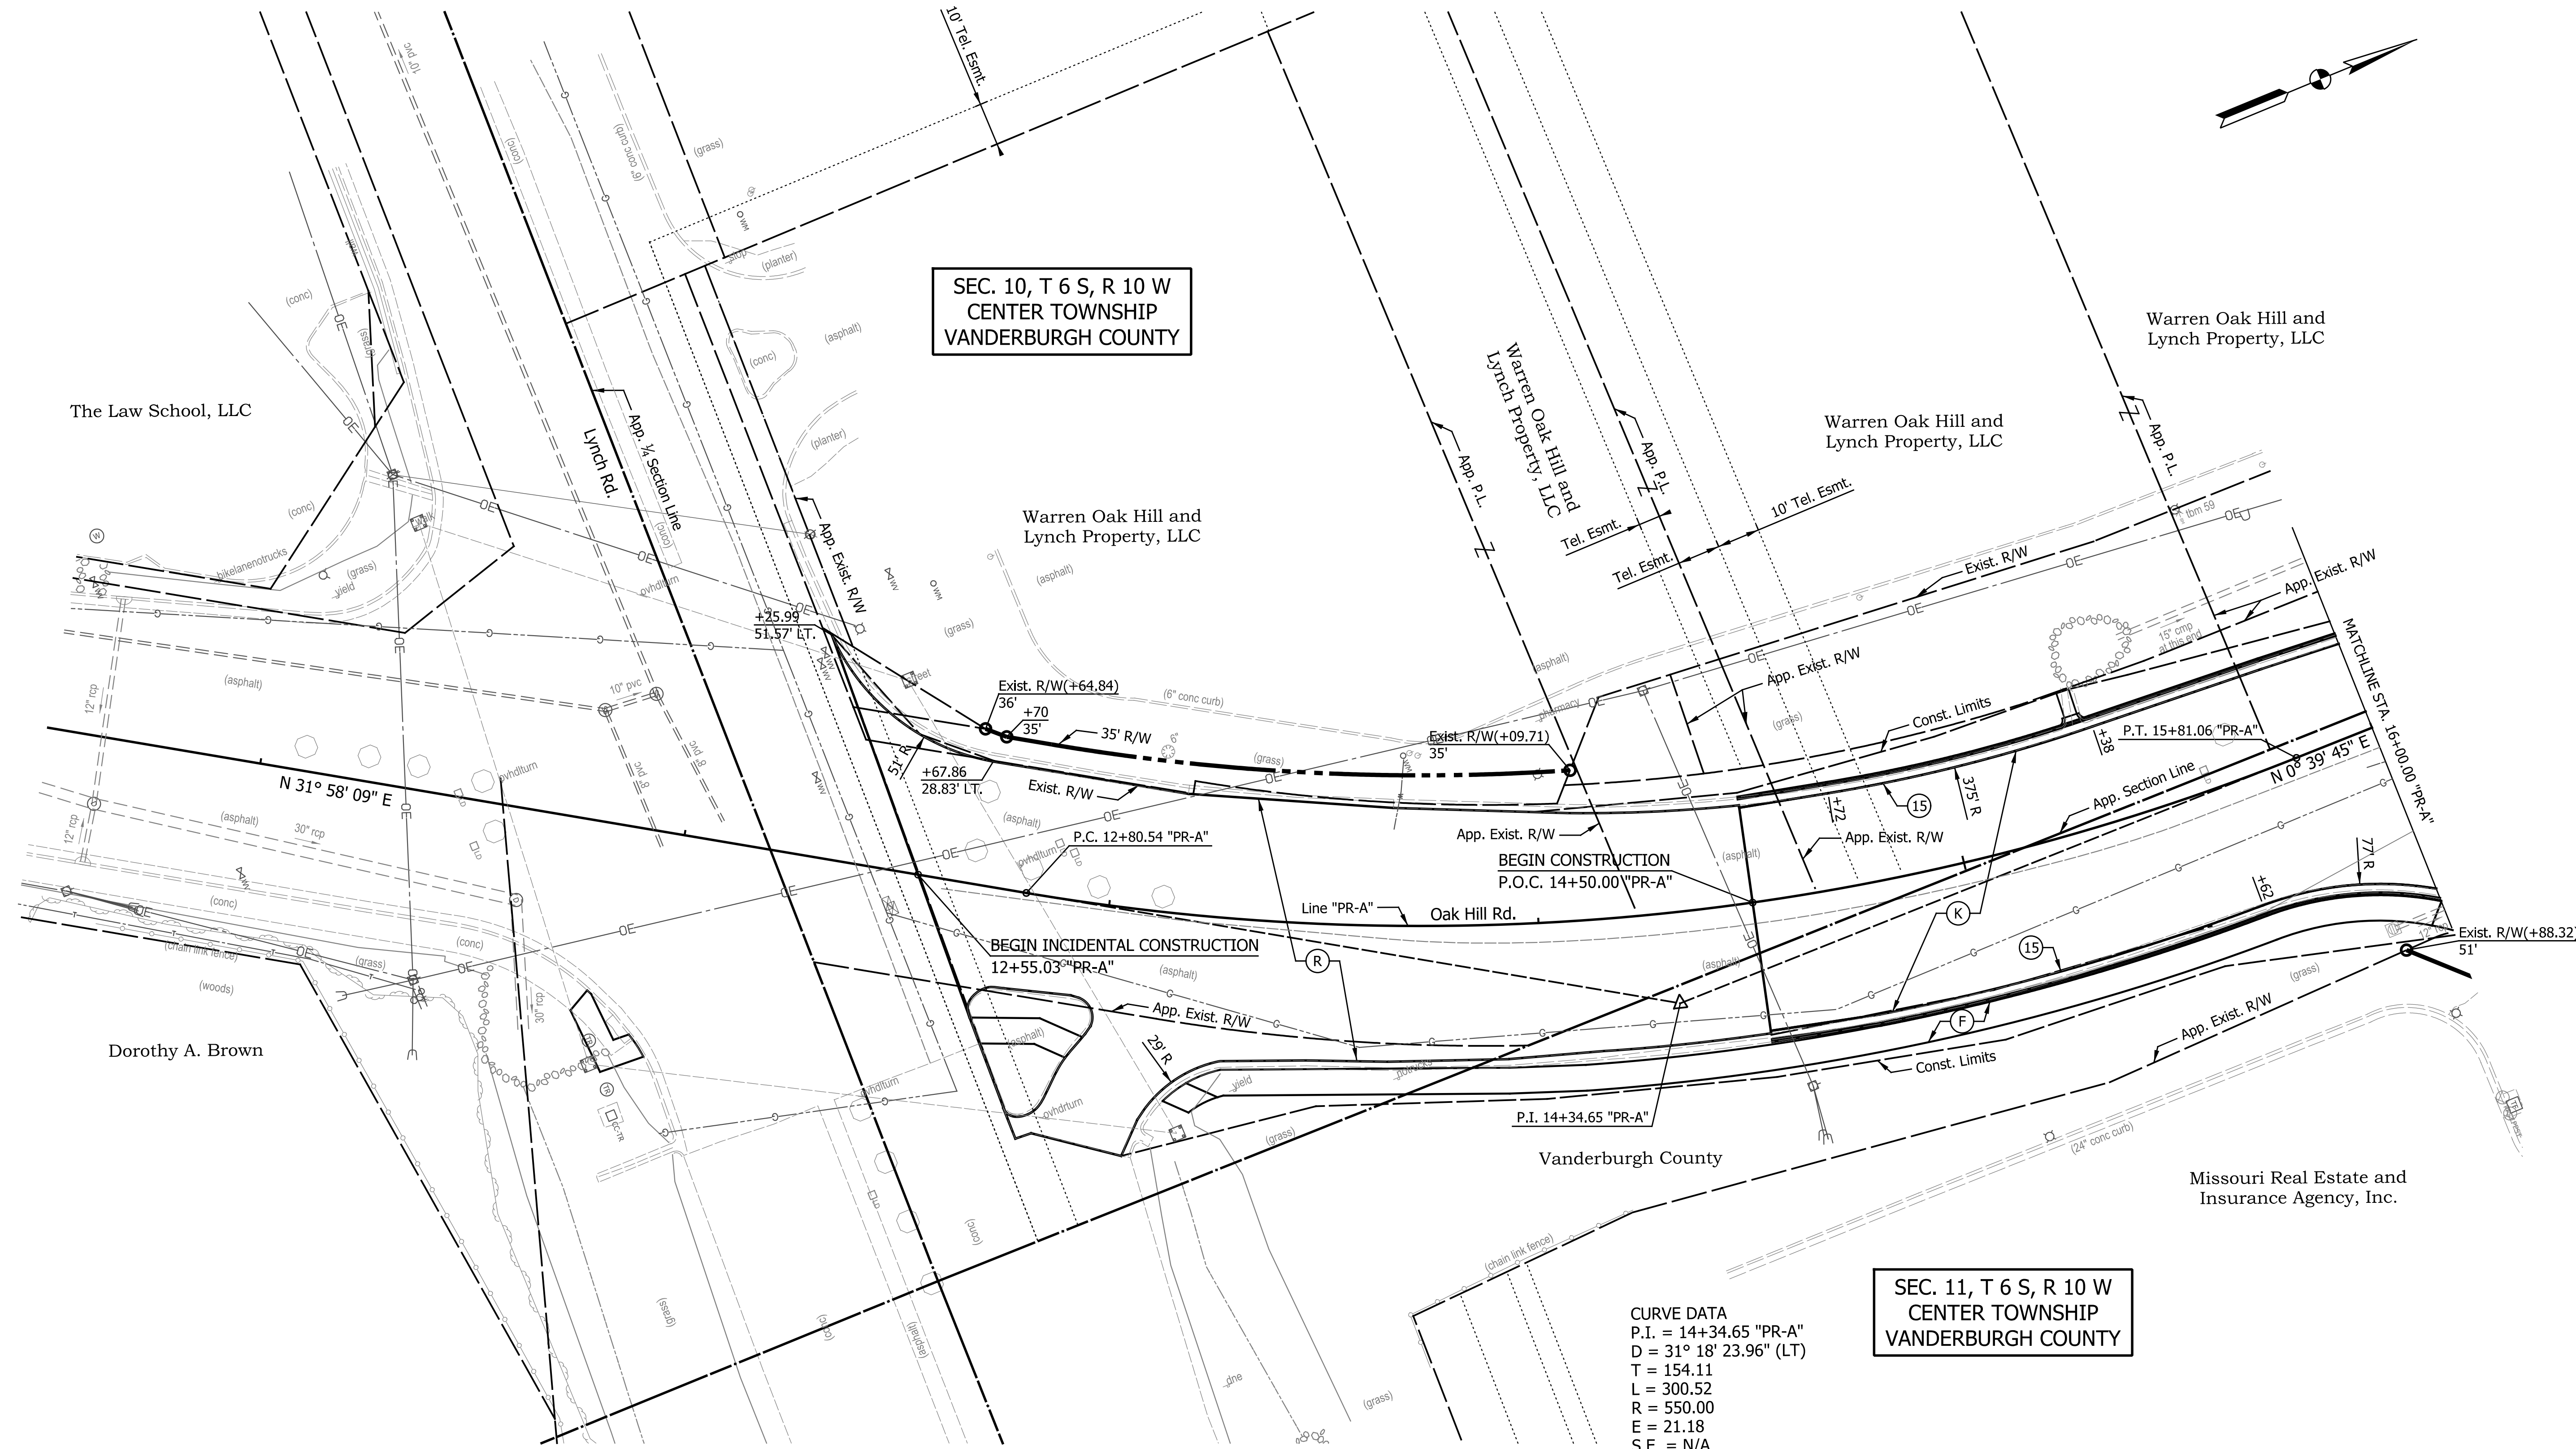DATE	REVISION

LEGEND

(K) Full Depth HMA Pavement (See Typical Section)	(C) PCCP For Approaches, 6 in.
(K1) Full Depth HMA Pavement (See Typical Section)	(C1) PCCP For Approaches, 9 in.
(R) Milling, Transition 165 #/Syd. QC/QA-HMA, 3, 70, Surface	(F) Sidewalk, Concrete, 4 in.
	(15) Curb and Gutter, Concrete



RECOMMENDED FOR APPROVAL	DESIGN ENGINEER	DATE
DESIGNED: JKH	DRAWN: BLP	
CHECKED: DSS	CHECKED: DSS	

INDIANA DEPARTMENT OF TRANSPORTATION

CONSTRUCTION DETAILS

OAK HILL ROAD

HORIZONTAL SCALE	BRIDGE FILE
1" = 20'	N/A
VERTICAL SCALE	DESIGNATION
N/A	2002538
SURVEY BOOK	SHEETS
N/A	26 of 117
CONTRACT	PROJECT
R-43470	2002538

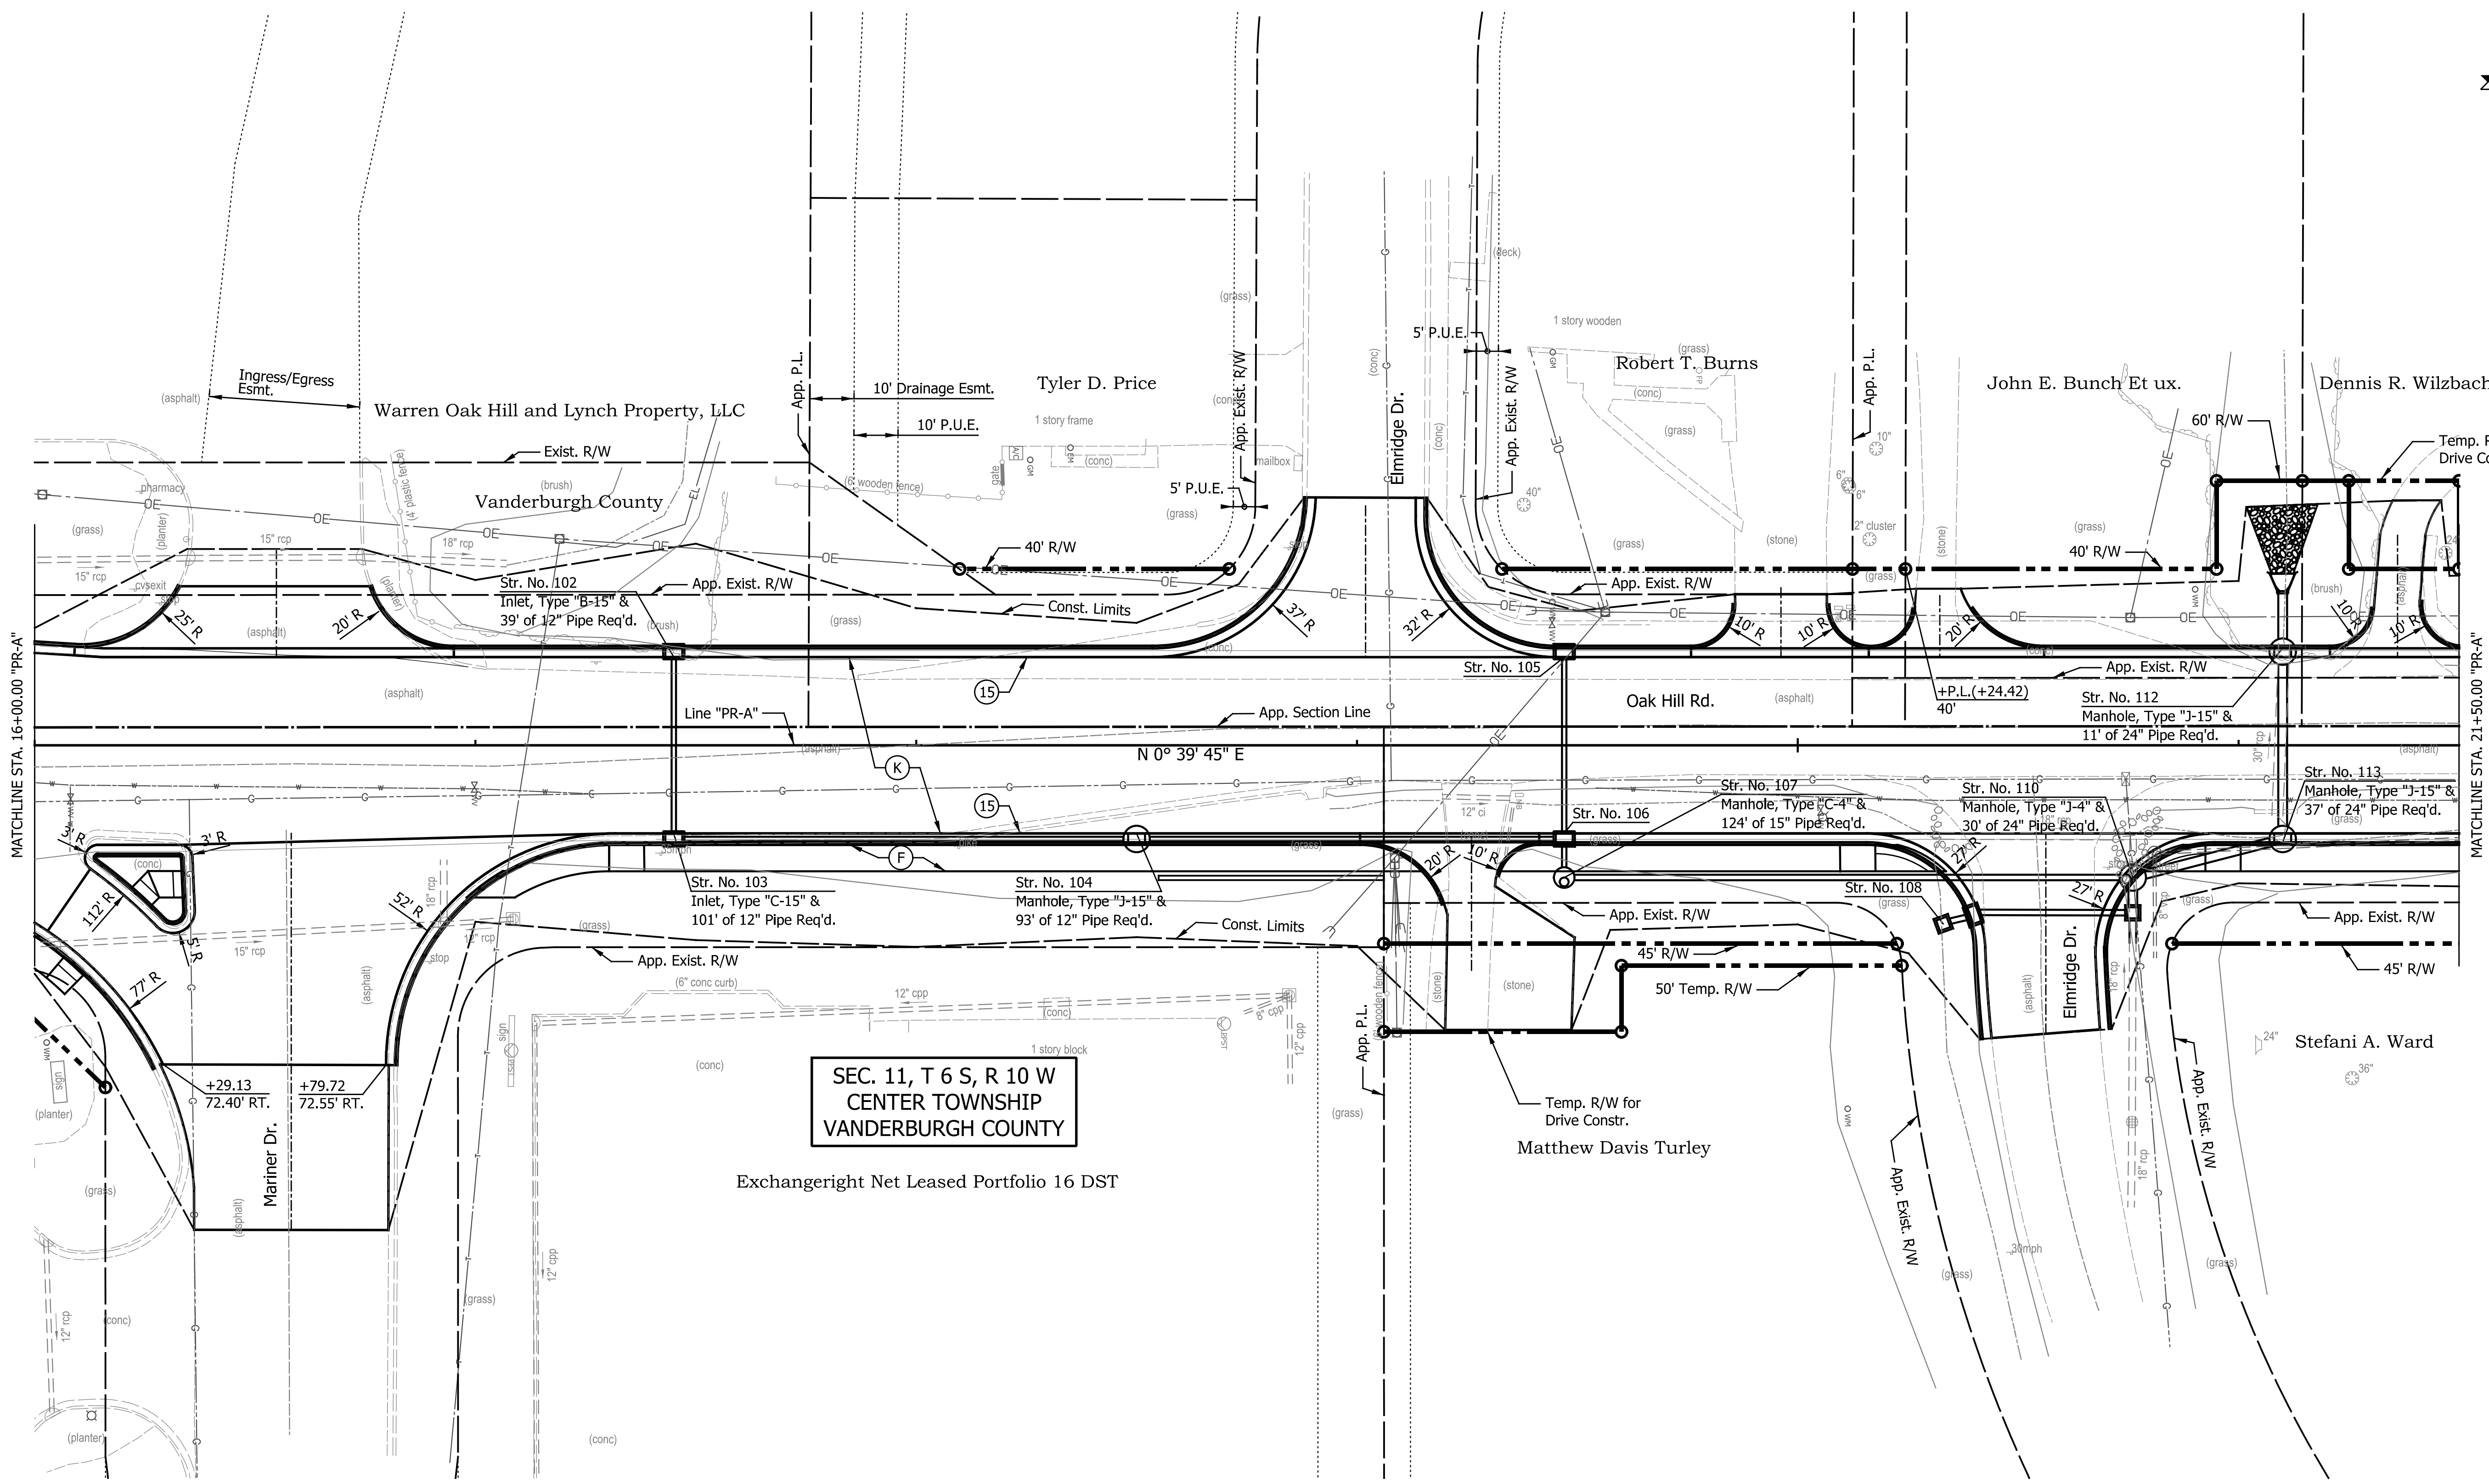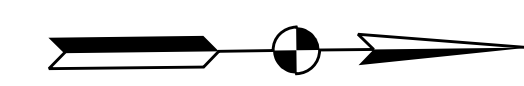

SEC. 11, T 6 S, R 10 W
CENTER TOWNSHIP
VANDERBURGH COUNTY

Exchangeright Net Leased Portfolio 16 DST

DATE	REVISION



LEGEND	
(K) Full Depth HMA Pavement (See Typical Section)	(C) PCCP For Approaches, 6 in.
(K1) Full Depth HMA Pavement (See Typical Section)	(C1) PCCP For Approaches, 9 in.
(R) Milling, Transition 165 #/Syd. QC/QA-HMA, 3, 70, Surface	(F) Sidewalk, Concrete, 4 in.
	(15) Curb and Gutter, Concrete

RECOMMENDED FOR APPROVAL	DESIGN ENGINEER	DATE
DESIGNED: JKH	DRAWN: BLP	
CHECKED: DSS	CHECKED: DSS	

INDIANA DEPARTMENT OF TRANSPORTATION
CONSTRUCTION DETAILS
OAK HILL ROAD

HORIZONTAL SCALE	BRIDGE FILE
1" = 20'	N/A
VERTICAL SCALE	DESIGNATION
N/A	2002538
SURVEY BOOK	SHEETS
N/A	27 of 117
CONTRACT	PROJECT
R-43470	2002538

SEC. 10, T 6 S, R 10 W
CENTER TOWNSHIP
VANDERBURGH COUNTY

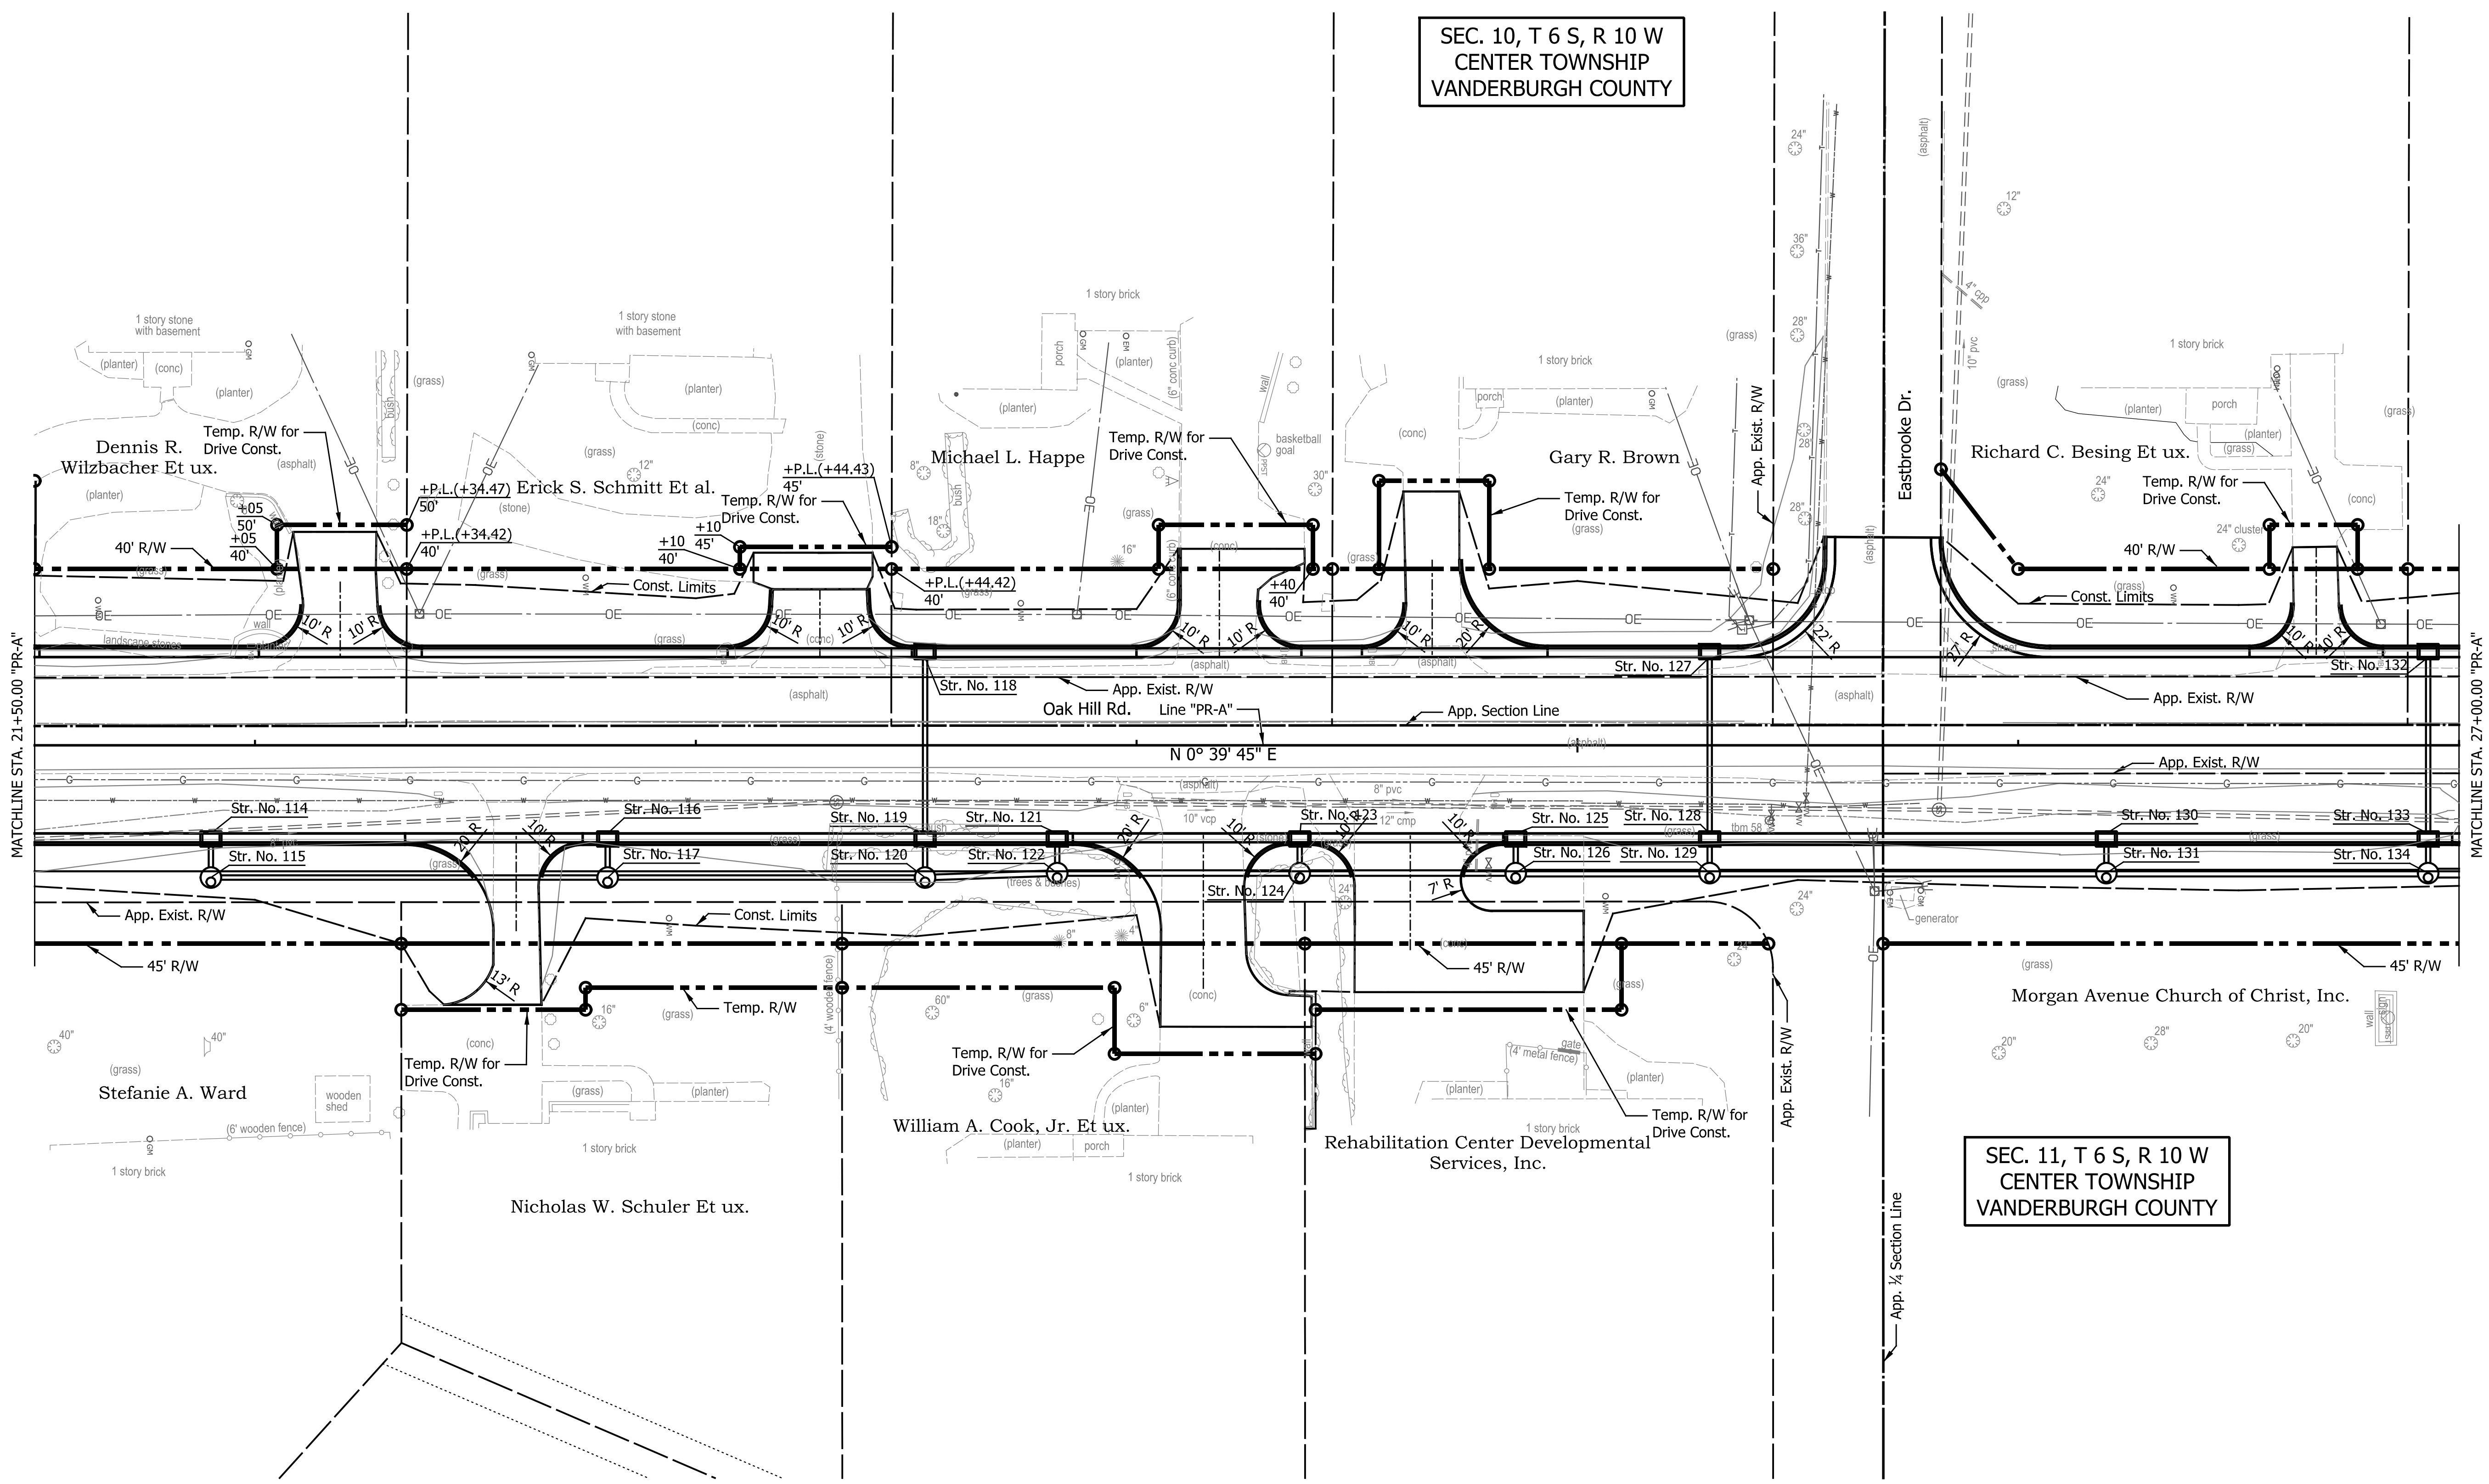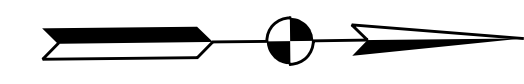

DATE	REVISION

LEGEND	
(K) Full Depth HMA Pavement (See Typical Section)	(C) PCCP For Approaches, 6 in.
(K1) Full Depth HMA Pavement (See Typical Section)	(C1) PCCP For Approaches, 9 in.
(R) Milling, Transition 165 #/Syd. QC/QA-HMA, 3, 70, Surface	(F) Sidewalk, Concrete, 4 in.
	(15) Curb and Gutter, Concrete


RECOMMENDED FOR APPROVAL	DESIGN ENGINEER	DATE
DESIGNED: JKH	DRAWN: BLP	
CHECKED: DSS	CHECKED: DSS	

INDIANA DEPARTMENT OF TRANSPORTATION

CONSTRUCTION DETAILS


OAK HILL ROAD

HORIZONTAL SCALE	BRIDGE FILE
1" = 20'	N/A
VERTICAL SCALE	DESIGNATION
N/A	2002538
SURVEY BOOK	SHEETS
N/A	28 of 117
CONTRACT	PROJECT
R-43470	2002538

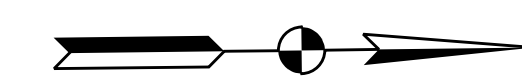

SEC. 10, T 6 S, R 10 W
CENTER TOWNSHIP
VANDERBURGH COUNTY

SEC. 11, T 6 S, R 10 W
CENTER TOWNSHIP
VANDERBURGH COUNTY

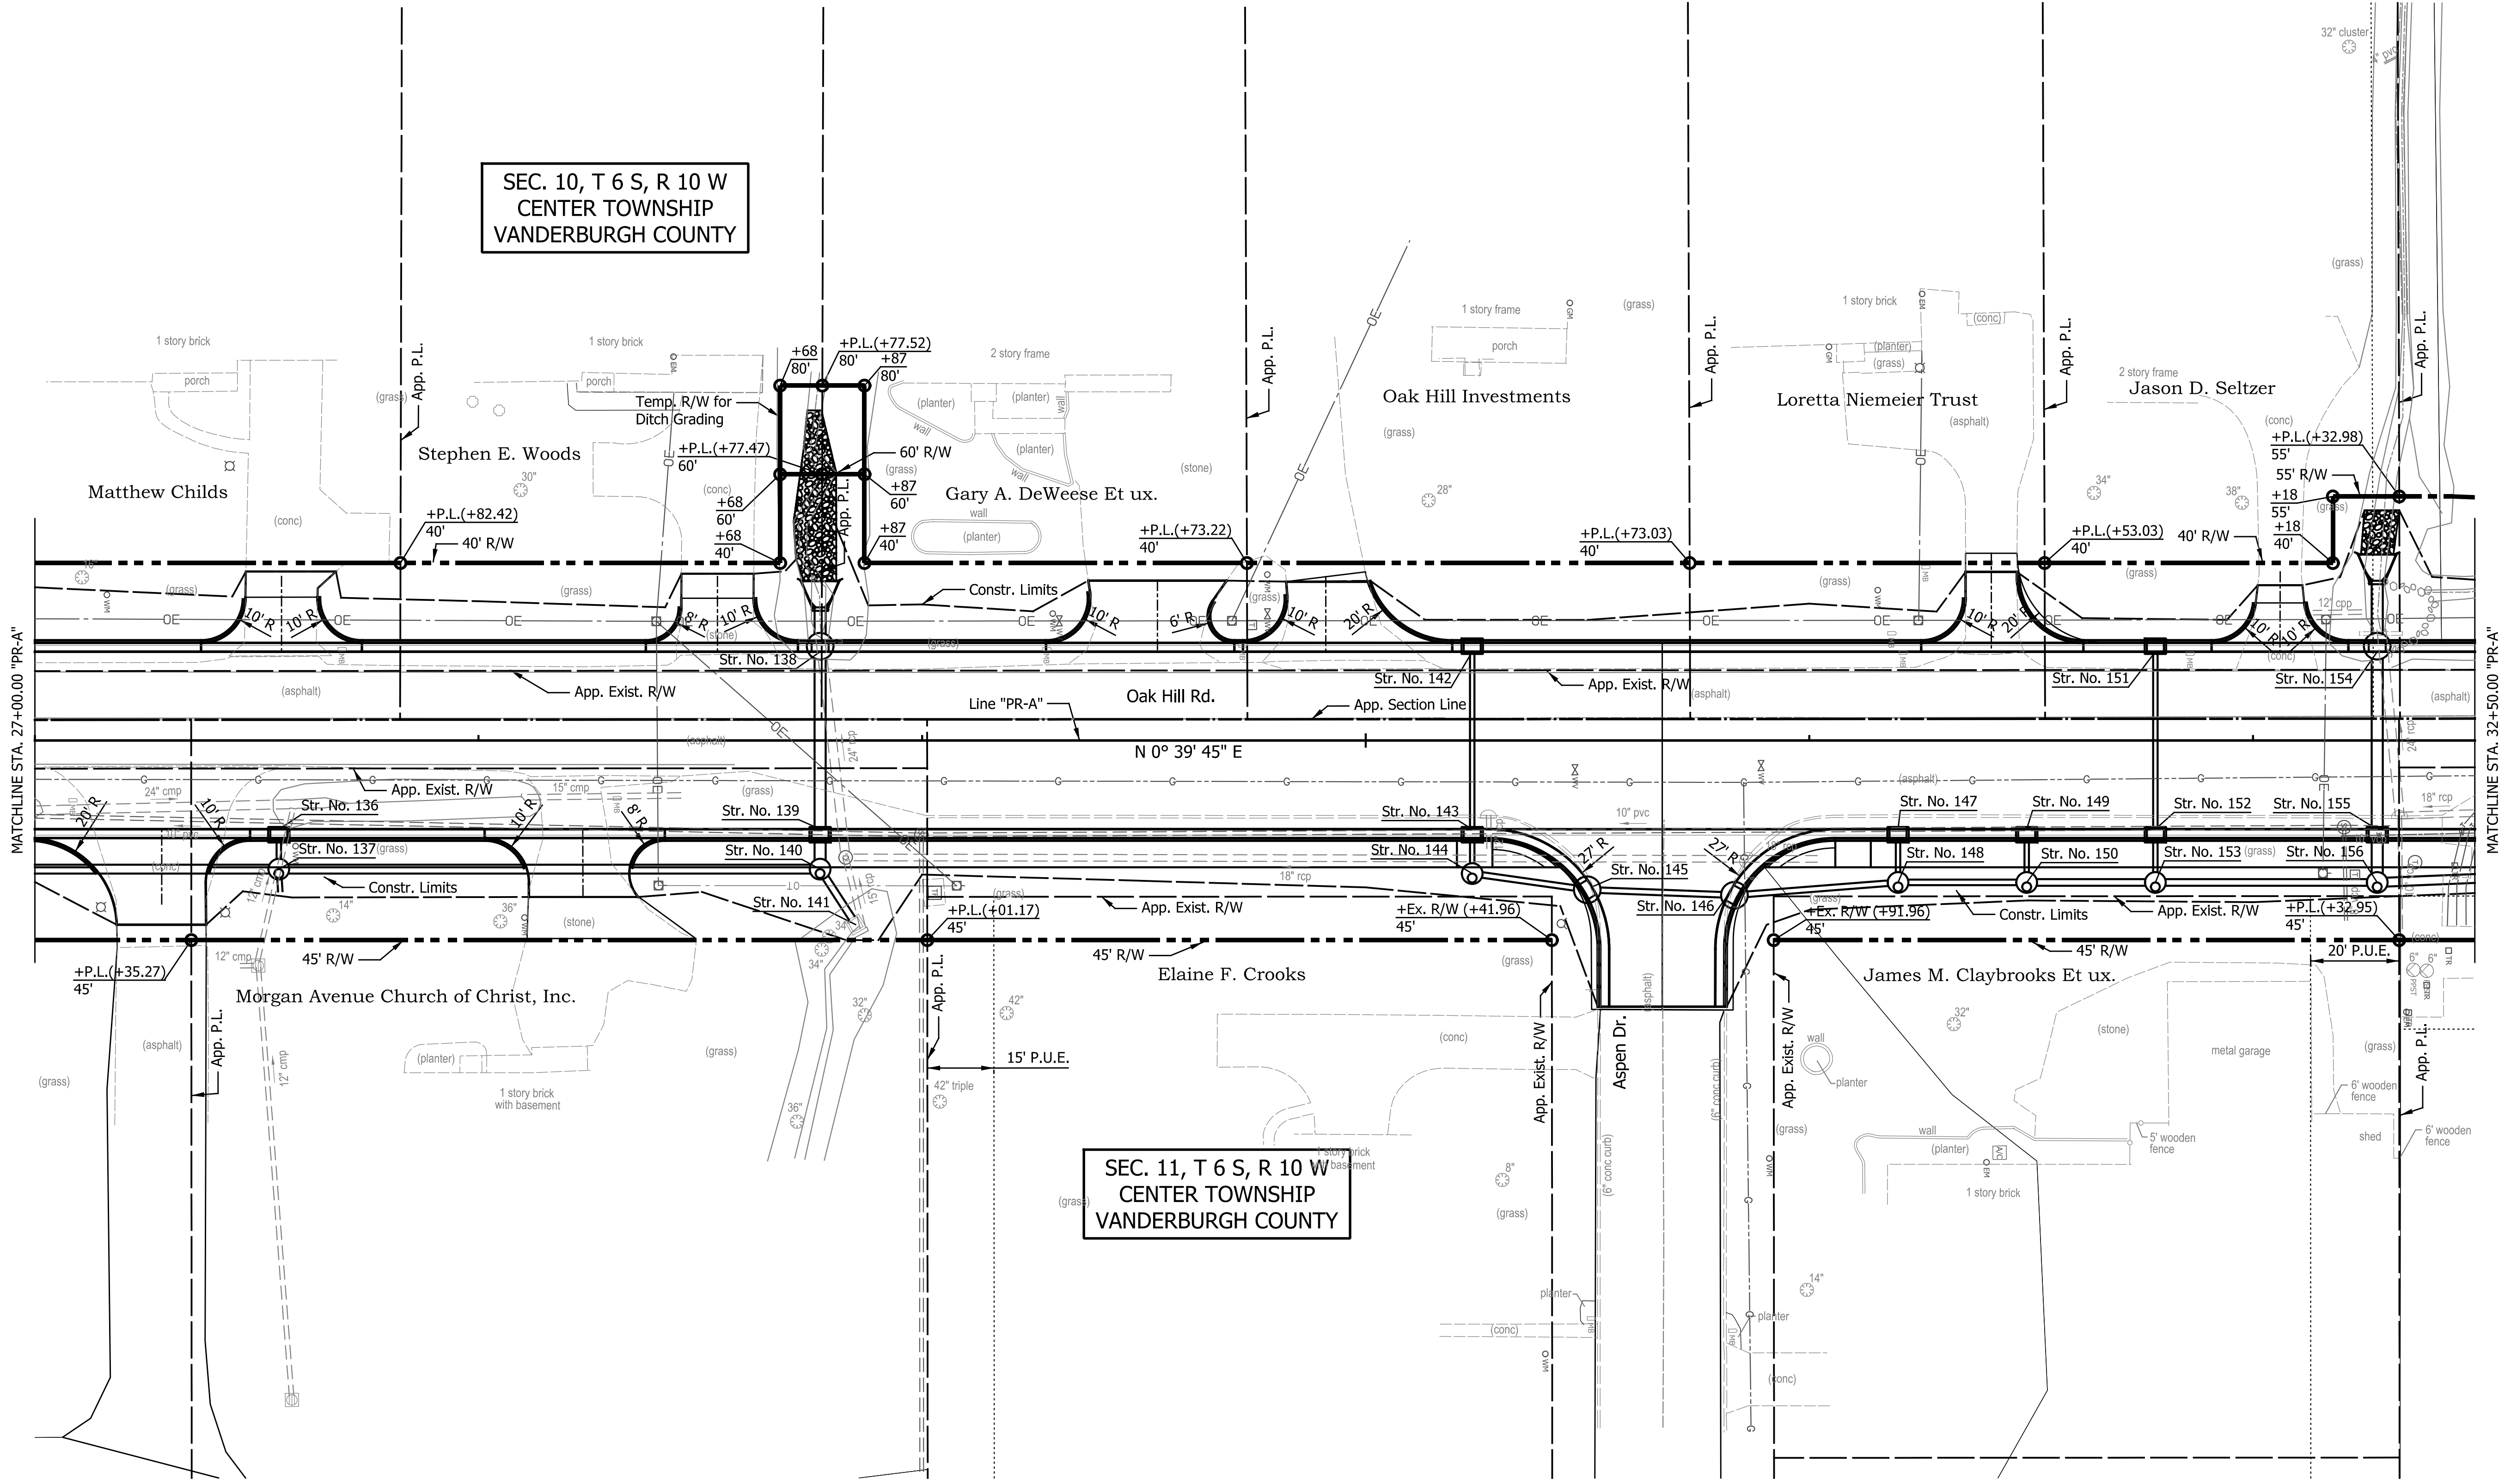

DATE	REVISION

LEGEND	
(K) Full Depth HMA Pavement (See Typical Section)	(C) PCCP For Approaches, 6 in.
(K1) Full Depth HMA Pavement (See Typical Section)	(C1) PCCP For Approaches, 9 in.
(R) Milling, Transition 165 #/Syd. QC/QA-HMA, 3, 70, Surface	(F) Sidewalk, Concrete, 4 in.
	(15) Curb and Gutter, Concrete


RECOMMENDED FOR APPROVAL	DESIGN ENGINEER	DATE
DESIGNED: JKH	DRAWN: BLP	
CHECKED: DSS	CHECKED: DSS	

INDIANA DEPARTMENT OF TRANSPORTATION

CONSTRUCTION DETAILS

OAK HILL ROAD

HORIZONTAL SCALE	BRIDGE FILE
1" = 20'	N/A
VERTICAL SCALE	DESIGNATION
N/A	2002538
SURVEY BOOK	SHEETS
N/A	29 of 117
CONTRACT	PROJECT
R-43470	2002538

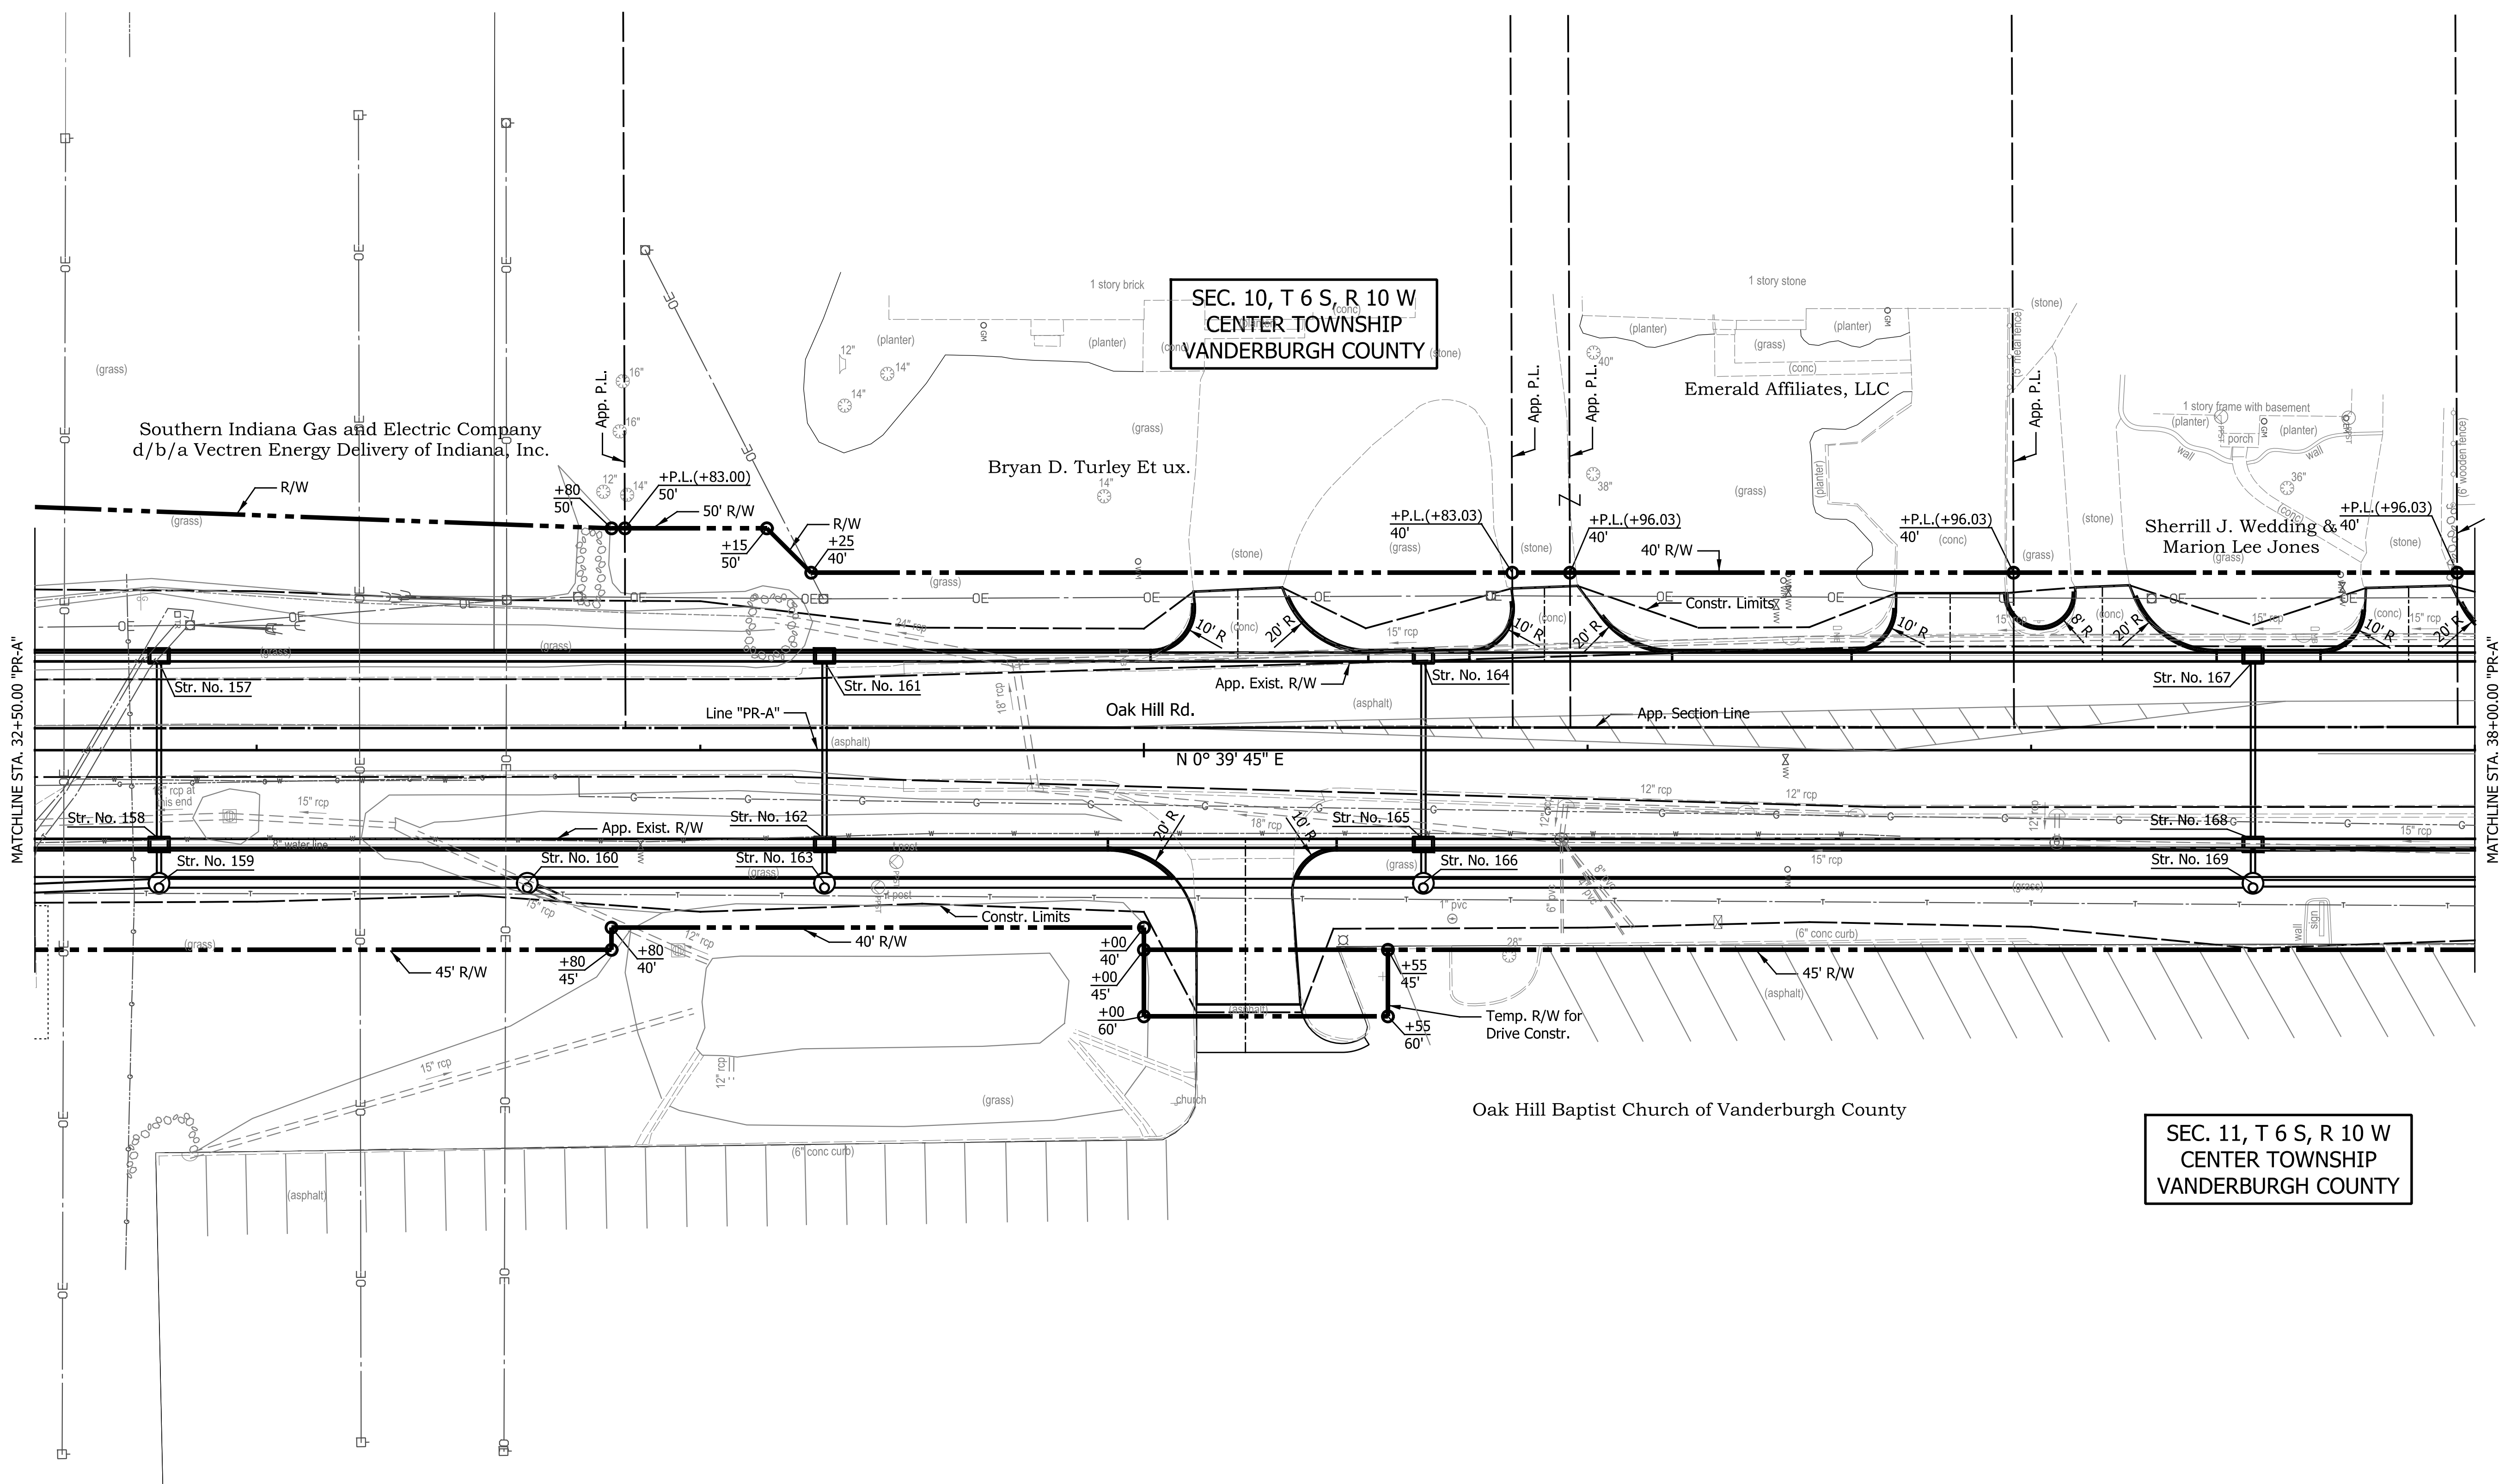

SEC. 10, T 6 S, R 10 W
CENTER TOWNSHIP
VANDERBURGH COUNTY

SEC. 11, T 6 S, R 10 W
CENTER TOWNSHIP
VANDERBURGH COUNTY

DATE	REVISION

LEGEND

(K) Full Depth HMA Pavement (See Typical Section)	(C) PCCP For Approaches, 6 in.
(K1) Full Depth HMA Pavement (See Typical Section)	(C1) PCCP For Approaches, 9 in.
(R) Milling, Transition 165 #/Syd. QC/QA-HMA, 3, 70, Surface	(F) Sidewalk, Concrete, 4 in.
	(15) Curb and Gutter, Concrete

RECOMMENDED FOR APPROVAL _____	DESIGN ENGINEER _____	DATE _____
DESIGNED: _____ JKH	DRAWN: _____ BLP	
CHECKED: _____ DSS	CHECKED: _____ DSS	

INDIANA DEPARTMENT
OF TRANSPORTATION

CONSTRUCTION DETAILS
OAK HILL ROAD

HORIZONTAL SCALE 1" = 20'	BRIDGE FILE N/A
VERTICAL SCALE N/A	DESIGNATION 2002538
SURVEY BOOK N/A	SHEETS 30 of 117
CONTRACT R-43470	PROJECT 2002538



SEC. 10, T 6 S, R 10 W
CENTER TOWNSHIP
VANDERBURGH COUNTY

SEC. 3, T 6 S, R 10 W
CENTER TOWNSHIP
VANDERBURGH COUNTY

Anthony Kightly


Timmie L. Strickland Et ux.

Helen L. Ault Revocable Trust Agreement

Paul David Gentry

Kevin W. Allen Et ux.

Thomas G. Stofleth

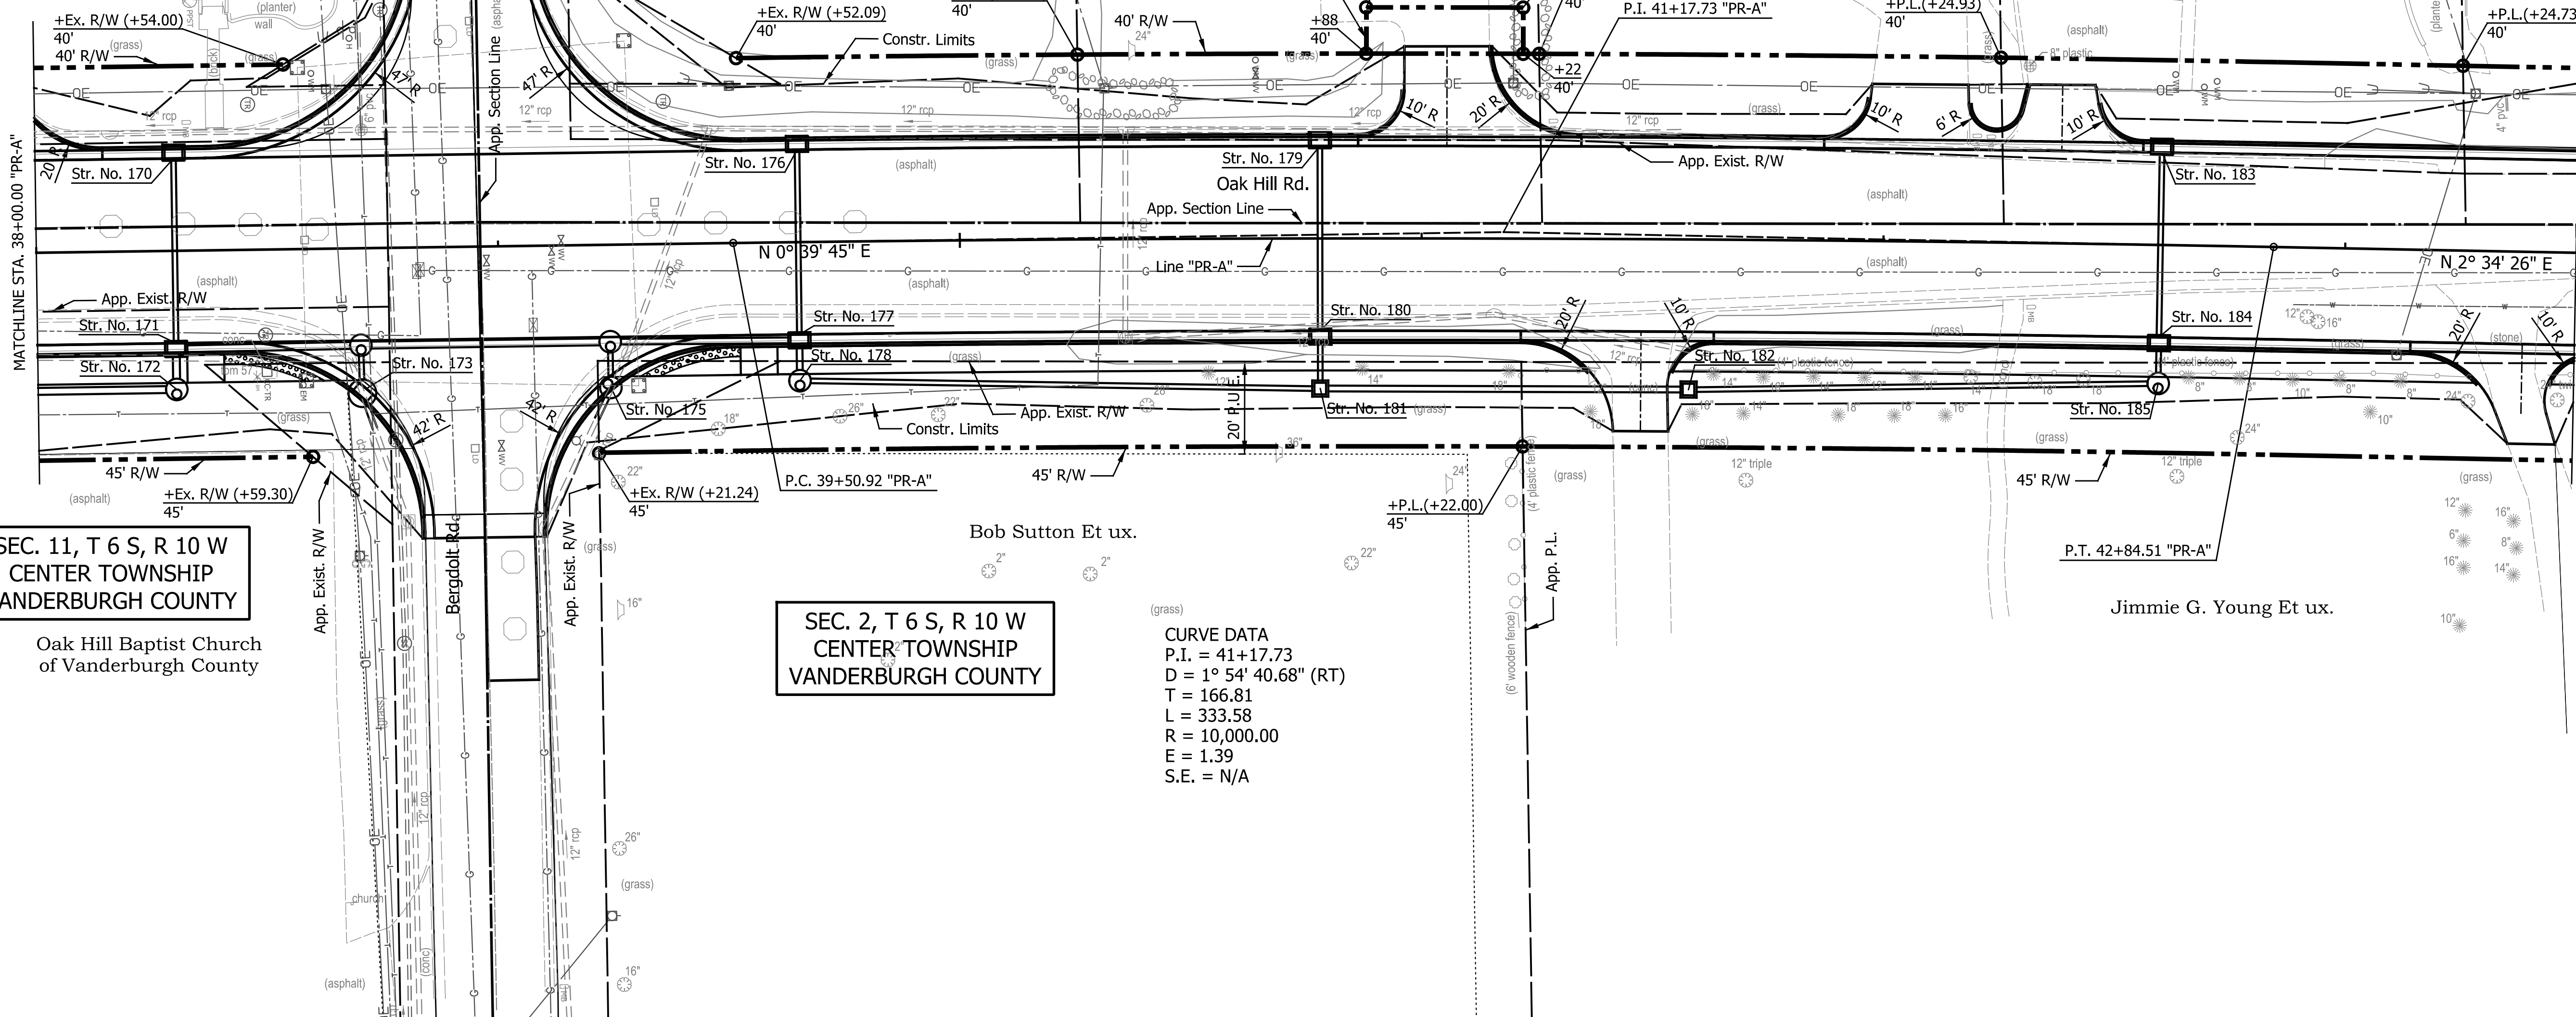

SEC. 11, T 6 S, R 10 W
CENTER TOWNSHIP
VANDERBURGH COUNTY

Oak Hill Baptist Church
of Vanderburgh County

SEC. 2, T 6 S, R 10 W
CENTER TOWNSHIP
VANDERBURGH COUNTY

Bob Sutton Et ux.

Jimmie G. Young Et ux.

CURVE DATA
P.I. = 41+17.73
D = 1° 54' 40.68" (RT)
T = 166.81
L = 333.58
R = 10,000.00
E = 1.39
S.E. = N/A



DATE	REVISION

LEGEND	
(K) Full Depth HMA Pavement (See Typical Section)	(C) PCCP For Approaches, 6 in.
(K1) Full Depth HMA Pavement (See Typical Section)	(C1) PCCP For Approaches, 9 in.
(R) Milling, Transition 165 #/Syd. QC/QA-HMA, 3, 70, Surface	(F) Sidewalk, Concrete, 4 in.
	(15) Curb and Gutter, Concrete

RECOMMENDED FOR APPROVAL	DESIGN ENGINEER	DATE
DESIGNED: JKH	DRAWN: BLP	
CHECKED: DSS	CHECKED: DSS	

INDIANA DEPARTMENT OF TRANSPORTATION
CONSTRUCTION DETAILS
OAK HILL ROAD

HORIZONTAL SCALE	BRIDGE FILE
1" = 20'	N/A
VERTICAL SCALE	DESIGNATION
N/A	2002538
SURVEY BOOK	SHEETS
N/A	31 of 117
CONTRACT	PROJECT
R-43470	2002538

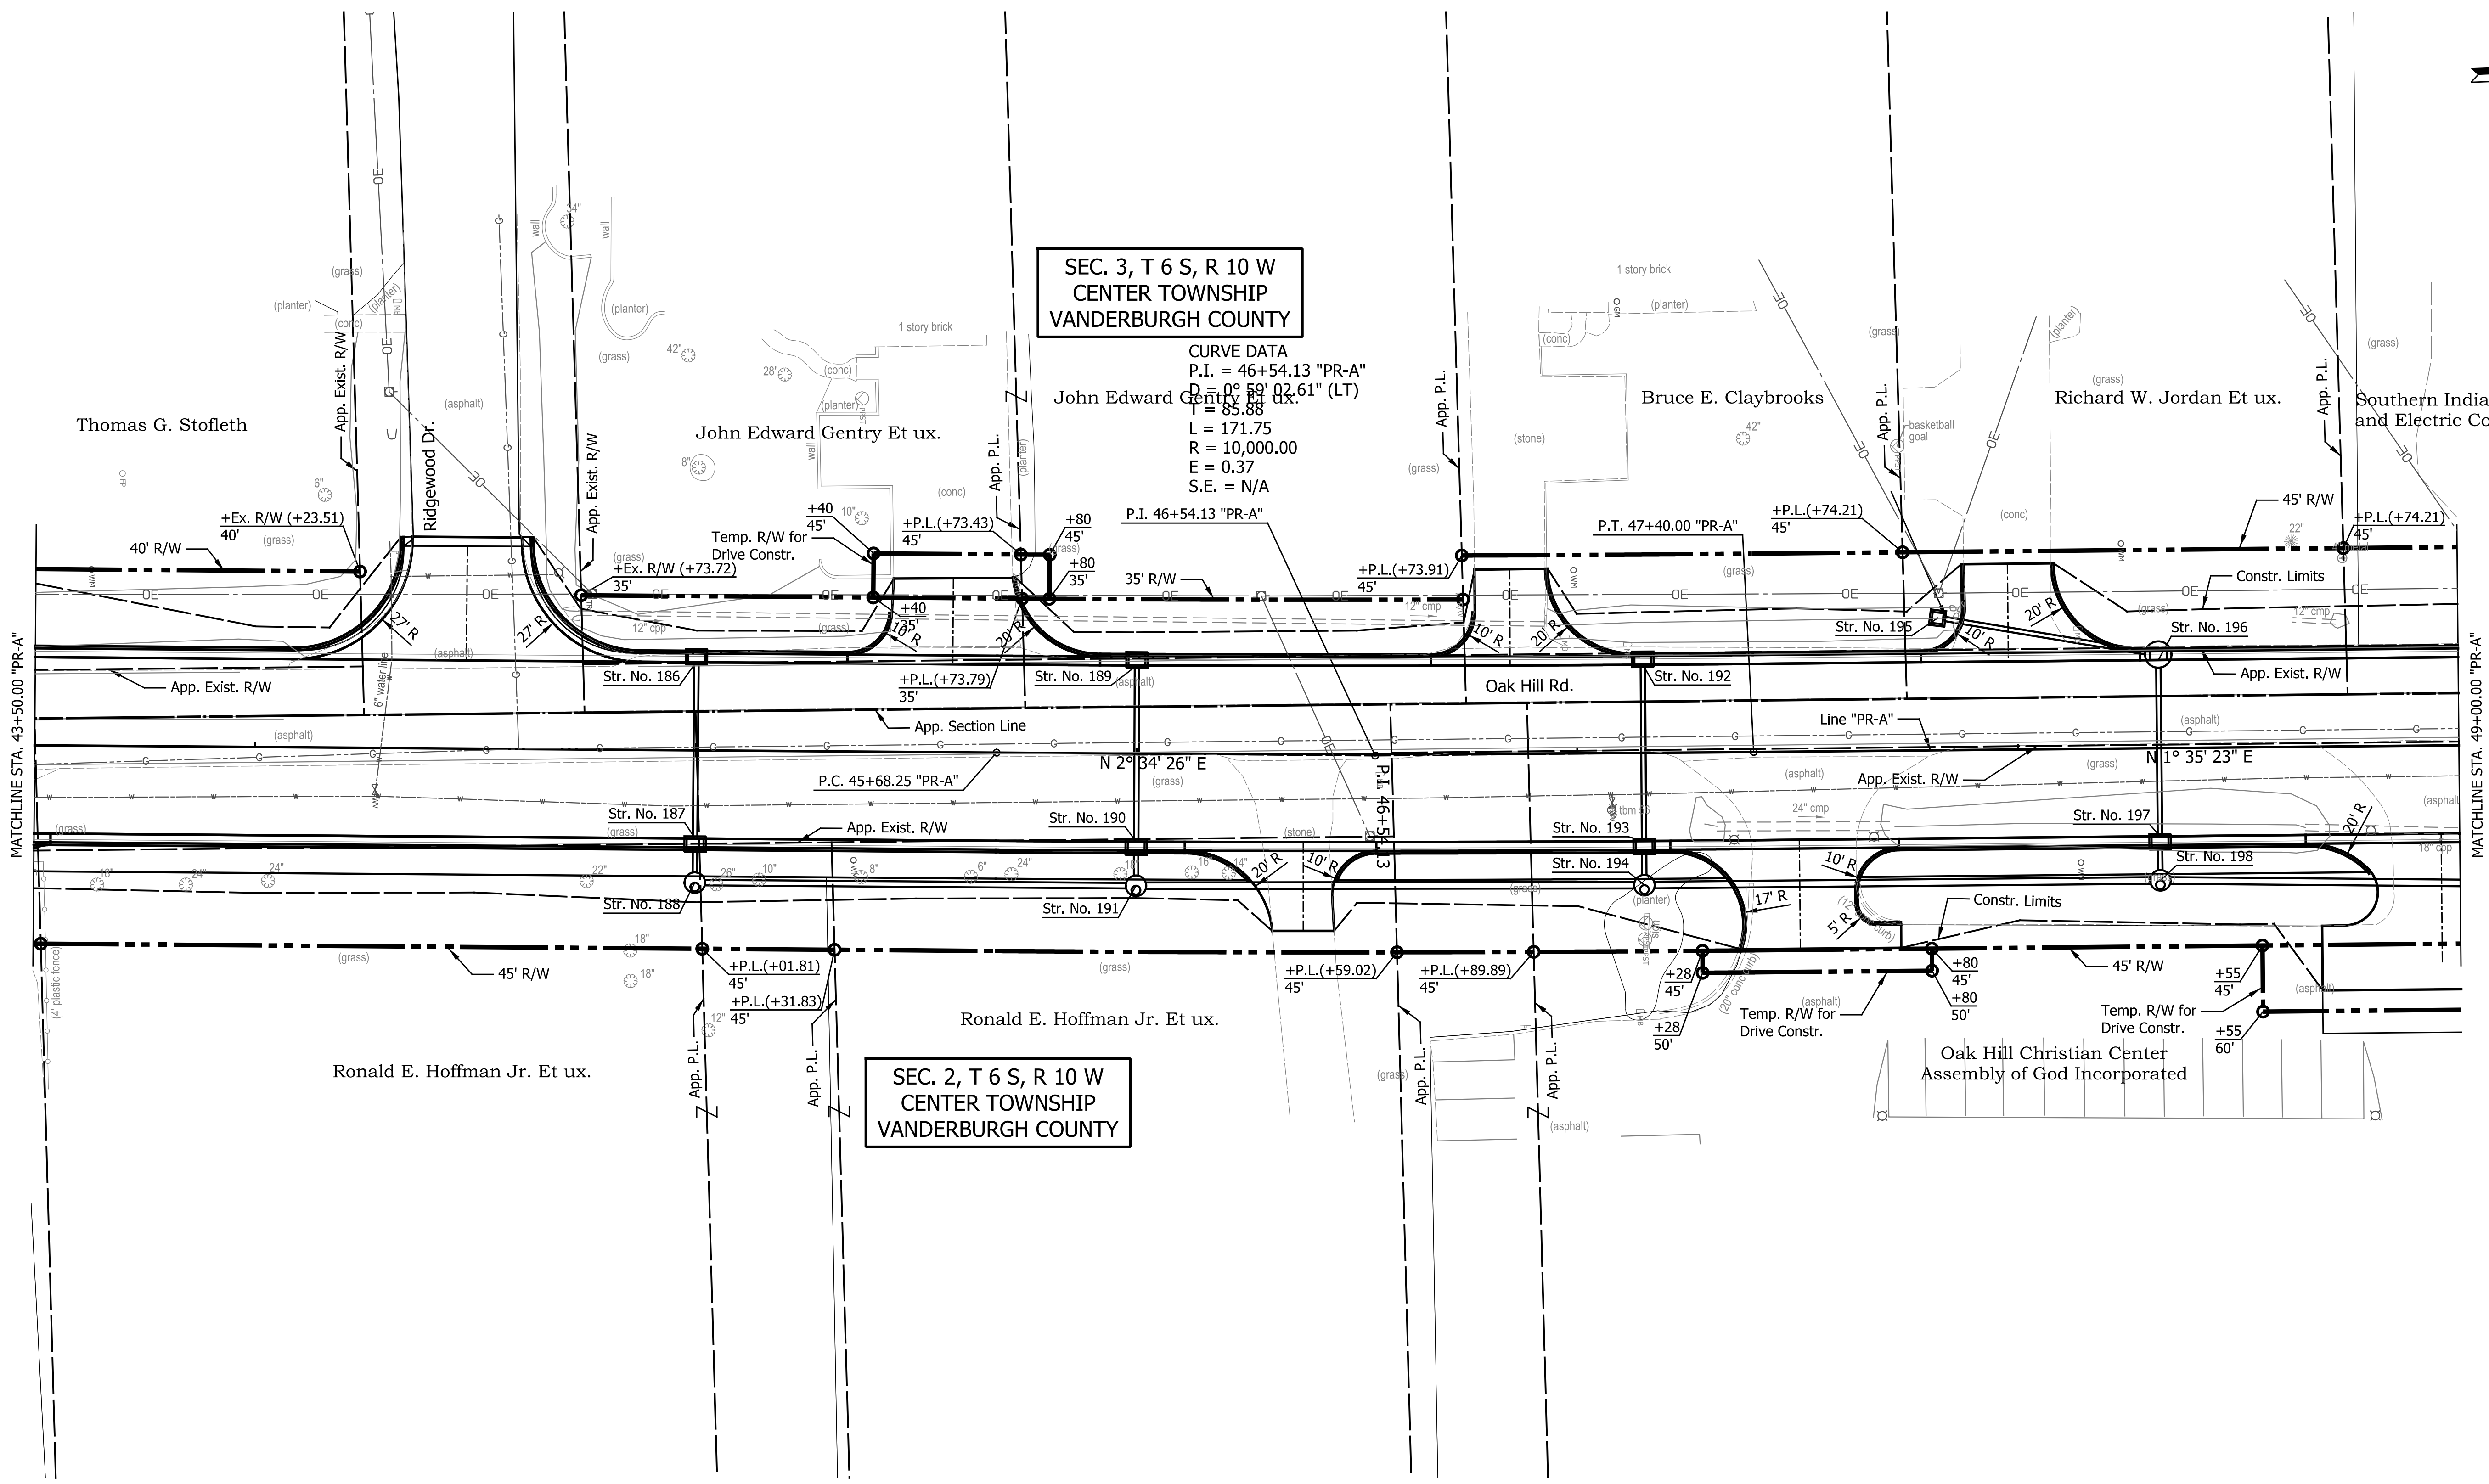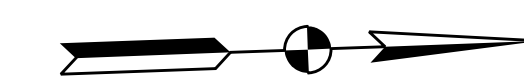

SEC. 3, T 6 S, R 10 W
CENTER TOWNSHIP
VANDERBURGH COUNTY

CURVE DATA
P.I. = 46+54.13 "PR-A"
D = 0° 59' 02.61" (LT)
T = 85.88
L = 171.75
R = 10,000.00
E = 0.37
S.E. = N/A

SEC. 2, T 6 S, R 10 W
CENTER TOWNSHIP
VANDERBURGH COUNTY

DATE	REVISION

LEGEND

(K) Full Depth HMA Pavement (See Typical Section)	(C) PCCP For Approaches, 6 in.
(K1) Full Depth HMA Pavement (See Typical Section)	(C1) PCCP For Approaches, 9 in.
(R) Milling, Transition 165 #/Syd. QC/QA-HMA, 3, 70, Surface	(F) Sidewalk, Concrete, 4 in.
	(15) Curb and Gutter, Concrete

RECOMMENDED FOR APPROVAL	DESIGN ENGINEER	DATE
DESIGNED: JKH	DRAWN: BLP	
CHECKED: DSS	CHECKED: DSS	

INDIANA DEPARTMENT OF TRANSPORTATION

CONSTRUCTION DETAILS

OAK HILL ROAD


HORIZONTAL SCALE	BRIDGE FILE
1" = 20'	N/A
VERTICAL SCALE	DESIGNATION
N/A	2002538
SURVEY BOOK	SHEETS
N/A	32 of 117
CONTRACT	PROJECT
R-43470	2002538

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SEC. 3, T 6 S, R 10 W
CENTER TOWNSHIP
VANDERBURGH COUNTY

SEC. 2, T 6 S, R 10 W
CENTER TOWNSHIP
VANDERBURGH COUNTY





DATE	REVISION

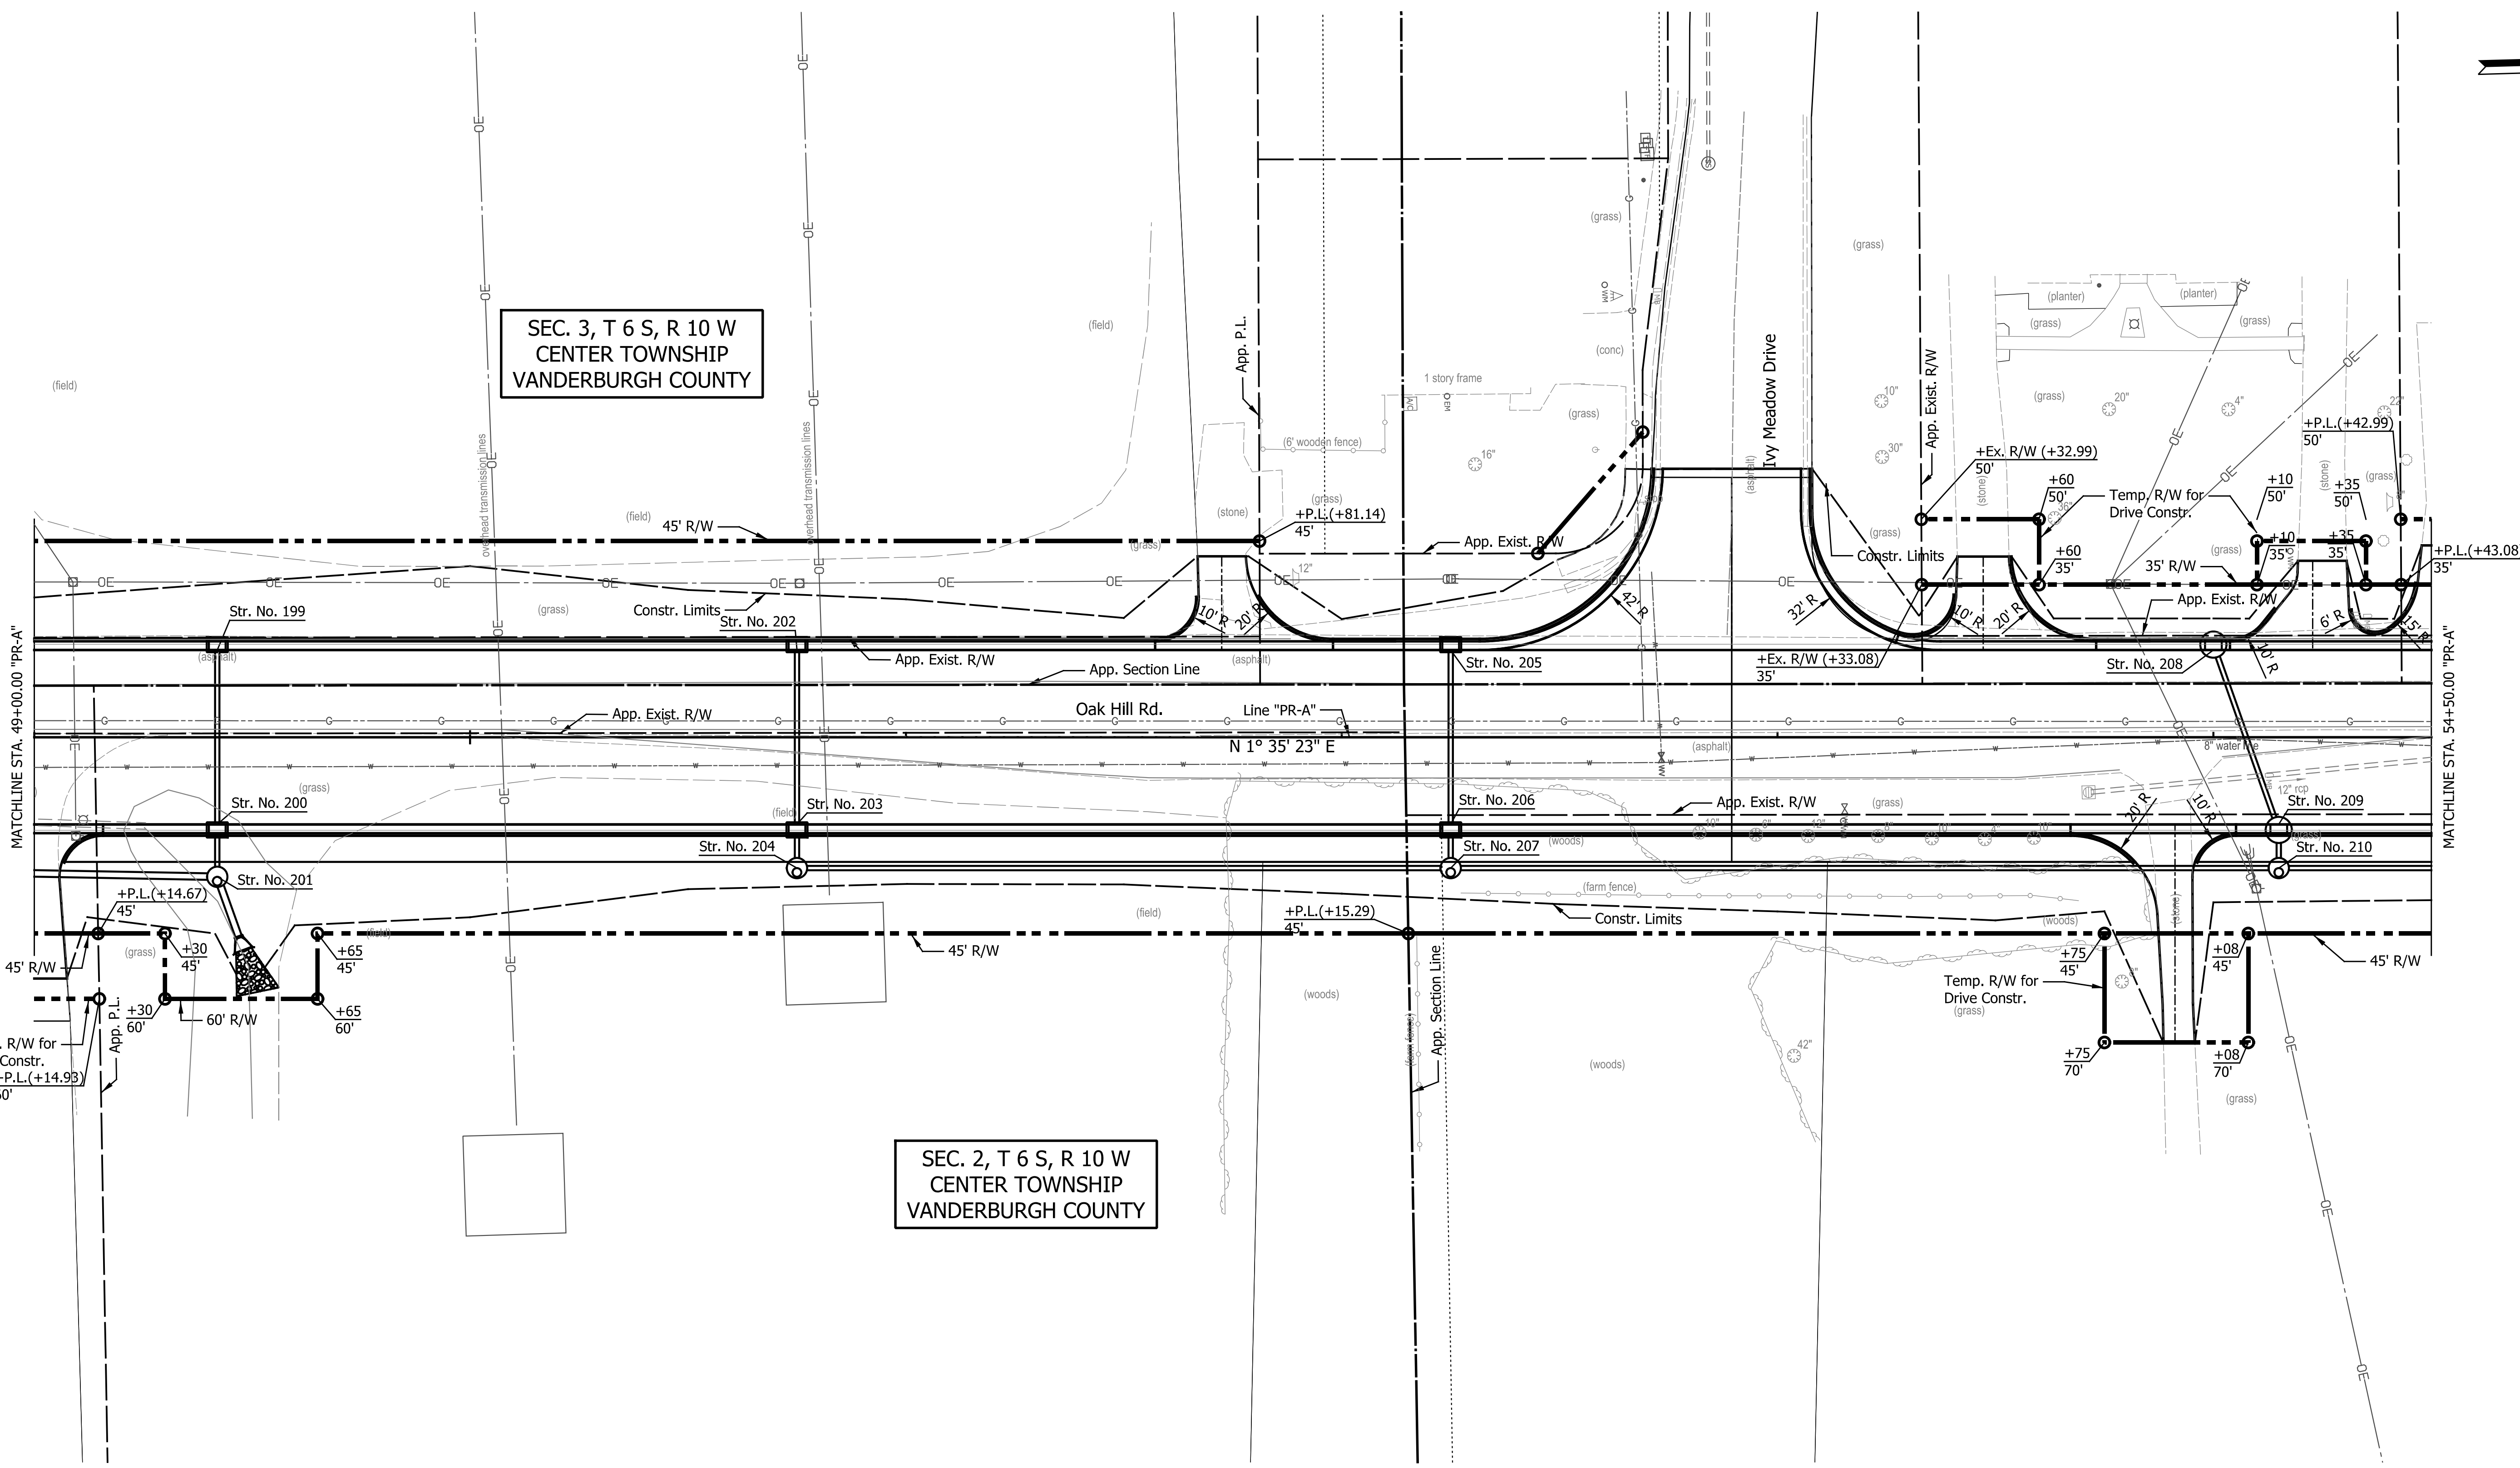LEGEND	
(K) Full Depth HMA Pavement (See Typical Section)	(C) PCCP For Approaches, 6 in.
(K1) Full Depth HMA Pavement (See Typical Section)	(C1) PCCP For Approaches, 9 in.
(R) Milling, Transition 165 #/Syd. QC/QA-HMA, 3, 70, Surface	(F) Sidewalk, Concrete, 4 in.
	(15) Curb and Gutter, Concrete

RECOMMENDED FOR APPROVAL	DESIGN ENGINEER	DATE
DESIGNED: JKH	DRAWN: BLP	
CHECKED: DSS	CHECKED: DSS	

INDIANA DEPARTMENT OF TRANSPORTATION
CONSTRUCTION DETAILS
OAK HILL ROAD

HORIZONTAL SCALE	BRIDGE FILE
1" = 20'	N/A
VERTICAL SCALE	DESIGNATION
N/A	2002538
SURVEY BOOK	SHEETS
N/A	33 of 117
CONTRACT	PROJECT
R-43470	2002538

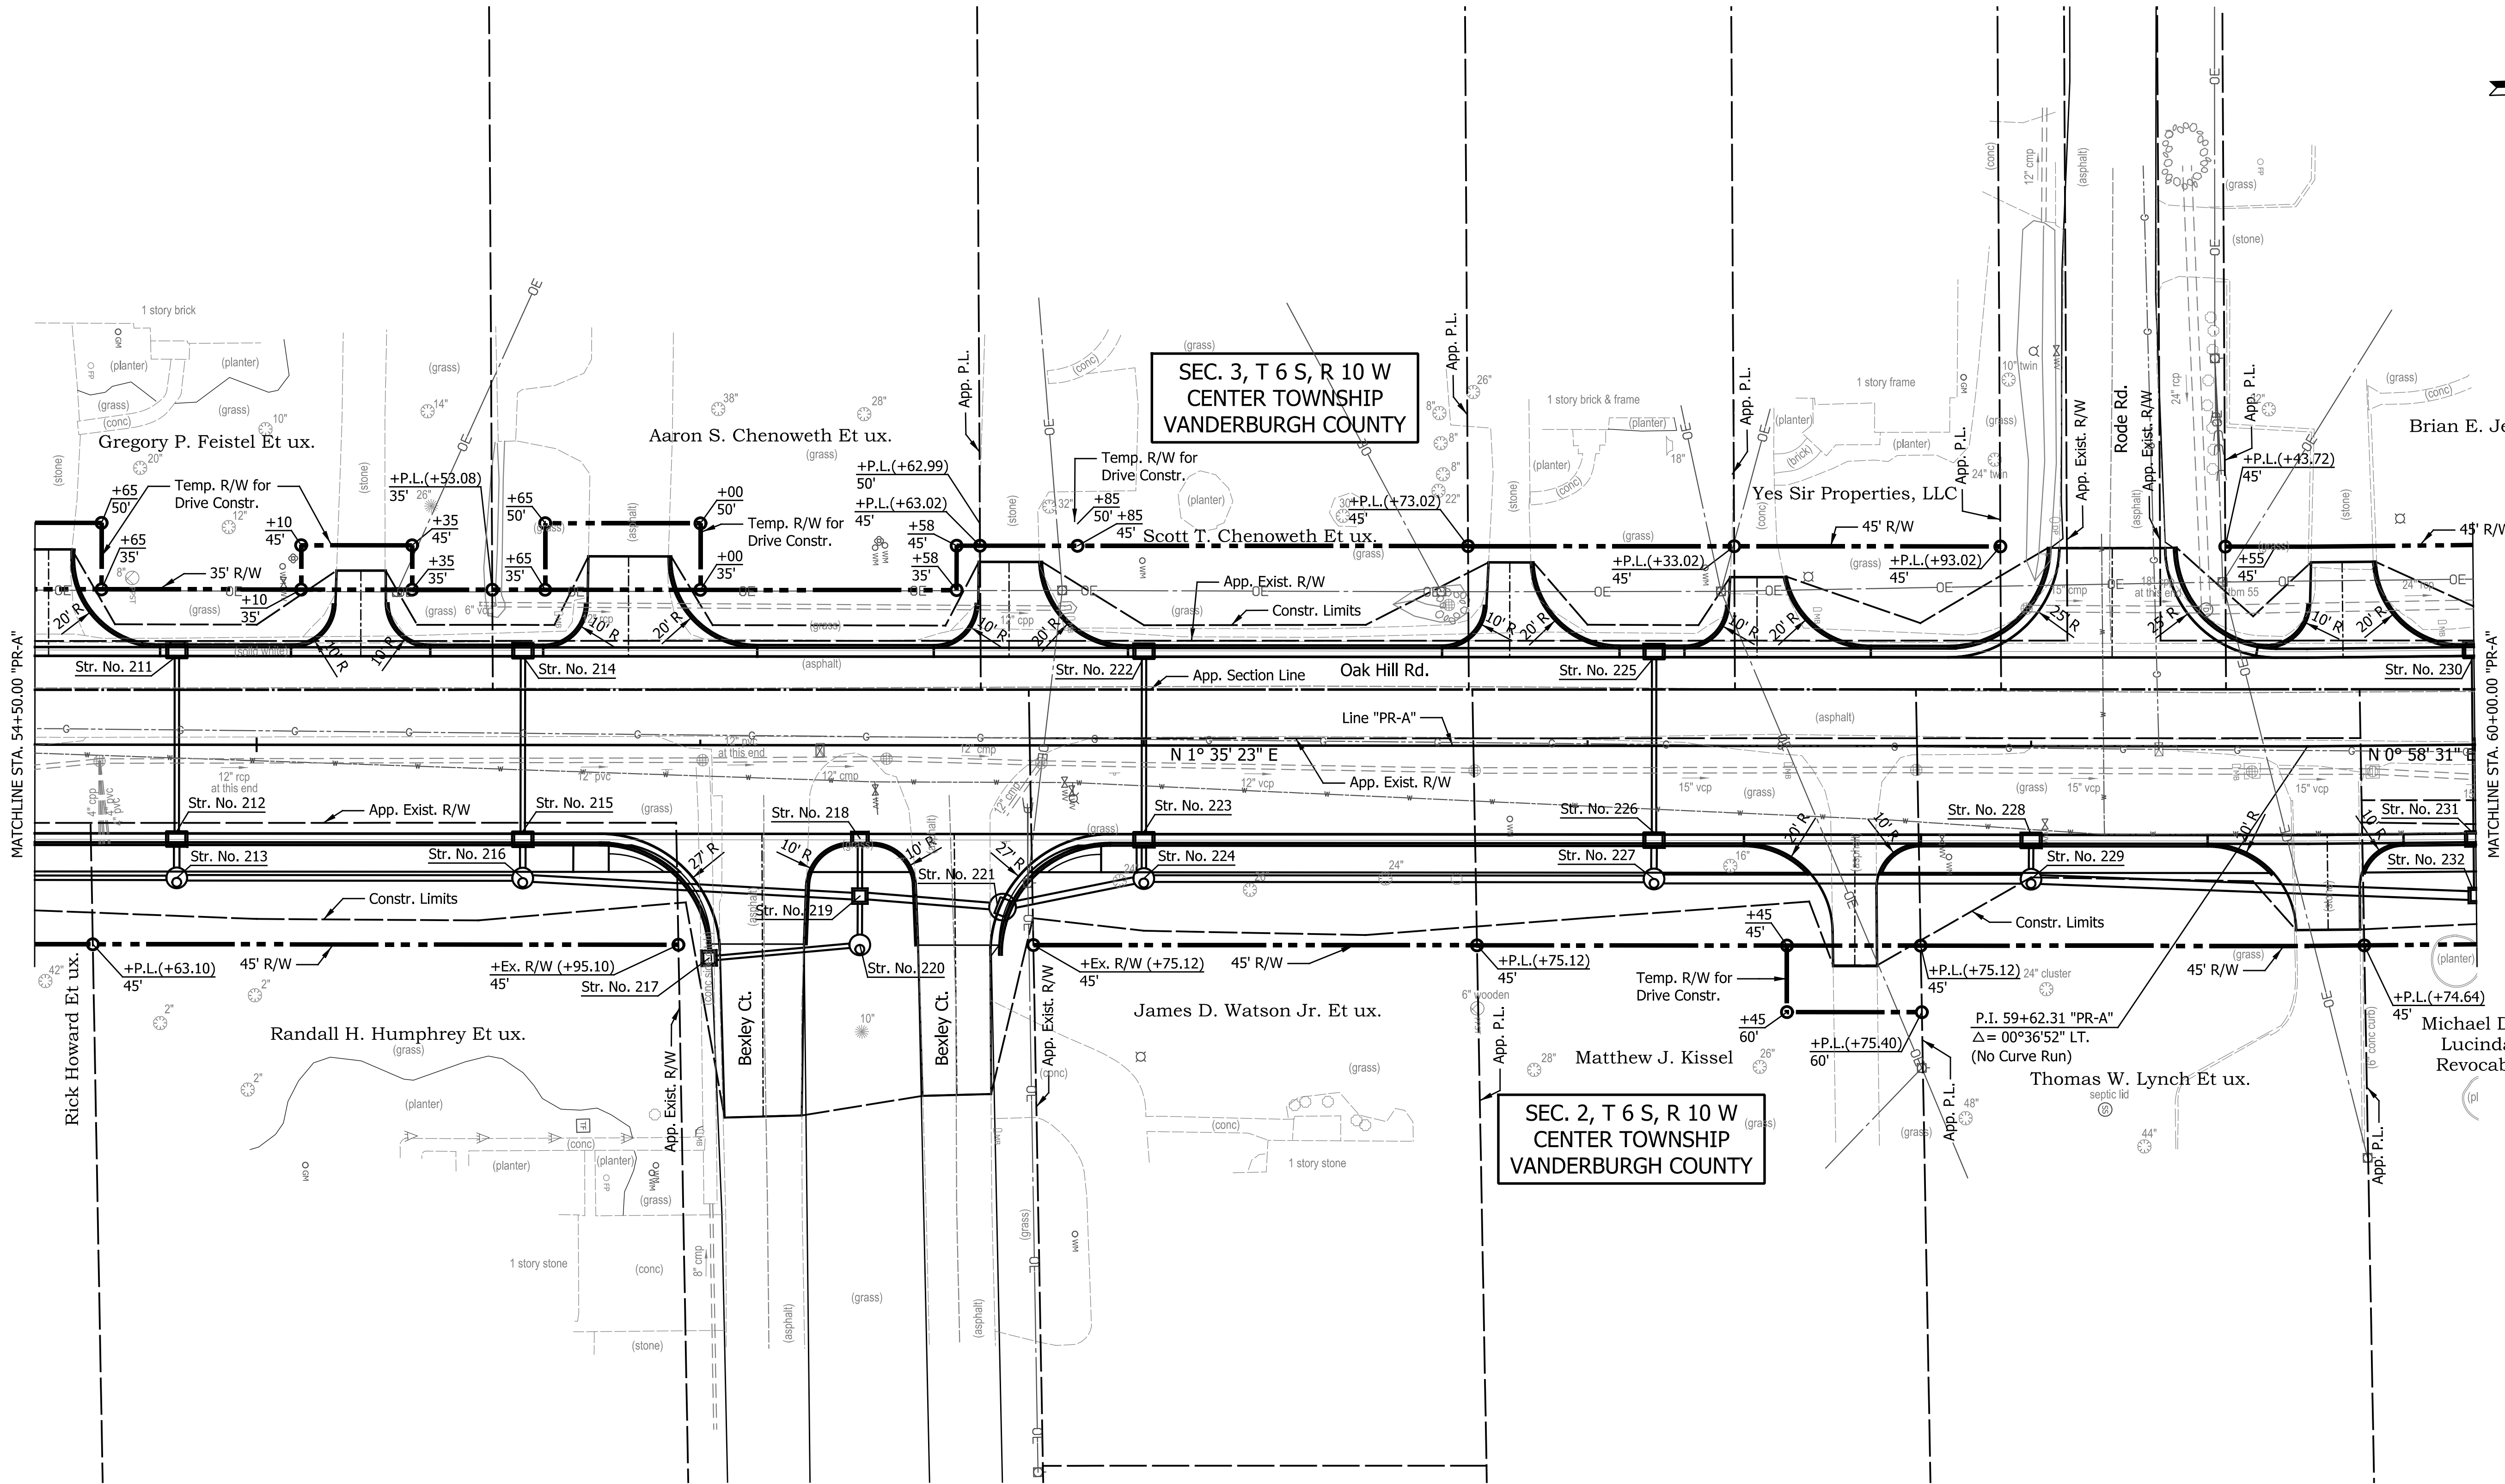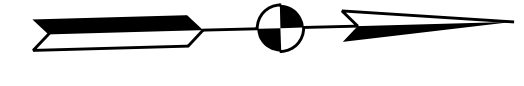

DATE	REVISION

LEGEND	
(K) Full Depth HMA Pavement (See Typical Section)	(C) PCCP For Approaches, 6 in.
(K1) Full Depth HMA Pavement (See Typical Section)	(C1) PCCP For Approaches, 9 in.
(R) Milling, Transition 165 #/Syd. QC/QA-HMA, 3, 70, Surface	(F) Sidewalk, Concrete, 4 in.
	(15) Curb and Gutter, Concrete


RECOMMENDED FOR APPROVAL	DESIGN ENGINEER	DATE
DESIGNED: JKH	DRAWN: BLP	
CHECKED: DSS	CHECKED: DSS	

INDIANA DEPARTMENT OF TRANSPORTATION

CONSTRUCTION DETAILS

OAK HILL ROAD

HORIZONTAL SCALE	BRIDGE FILE
1" = 20'	N/A
VERTICAL SCALE	DESIGNATION
N/A	2002538
SURVEY BOOK	SHEETS
N/A	34 of 117
CONTRACT	PROJECT
R-43470	2002538

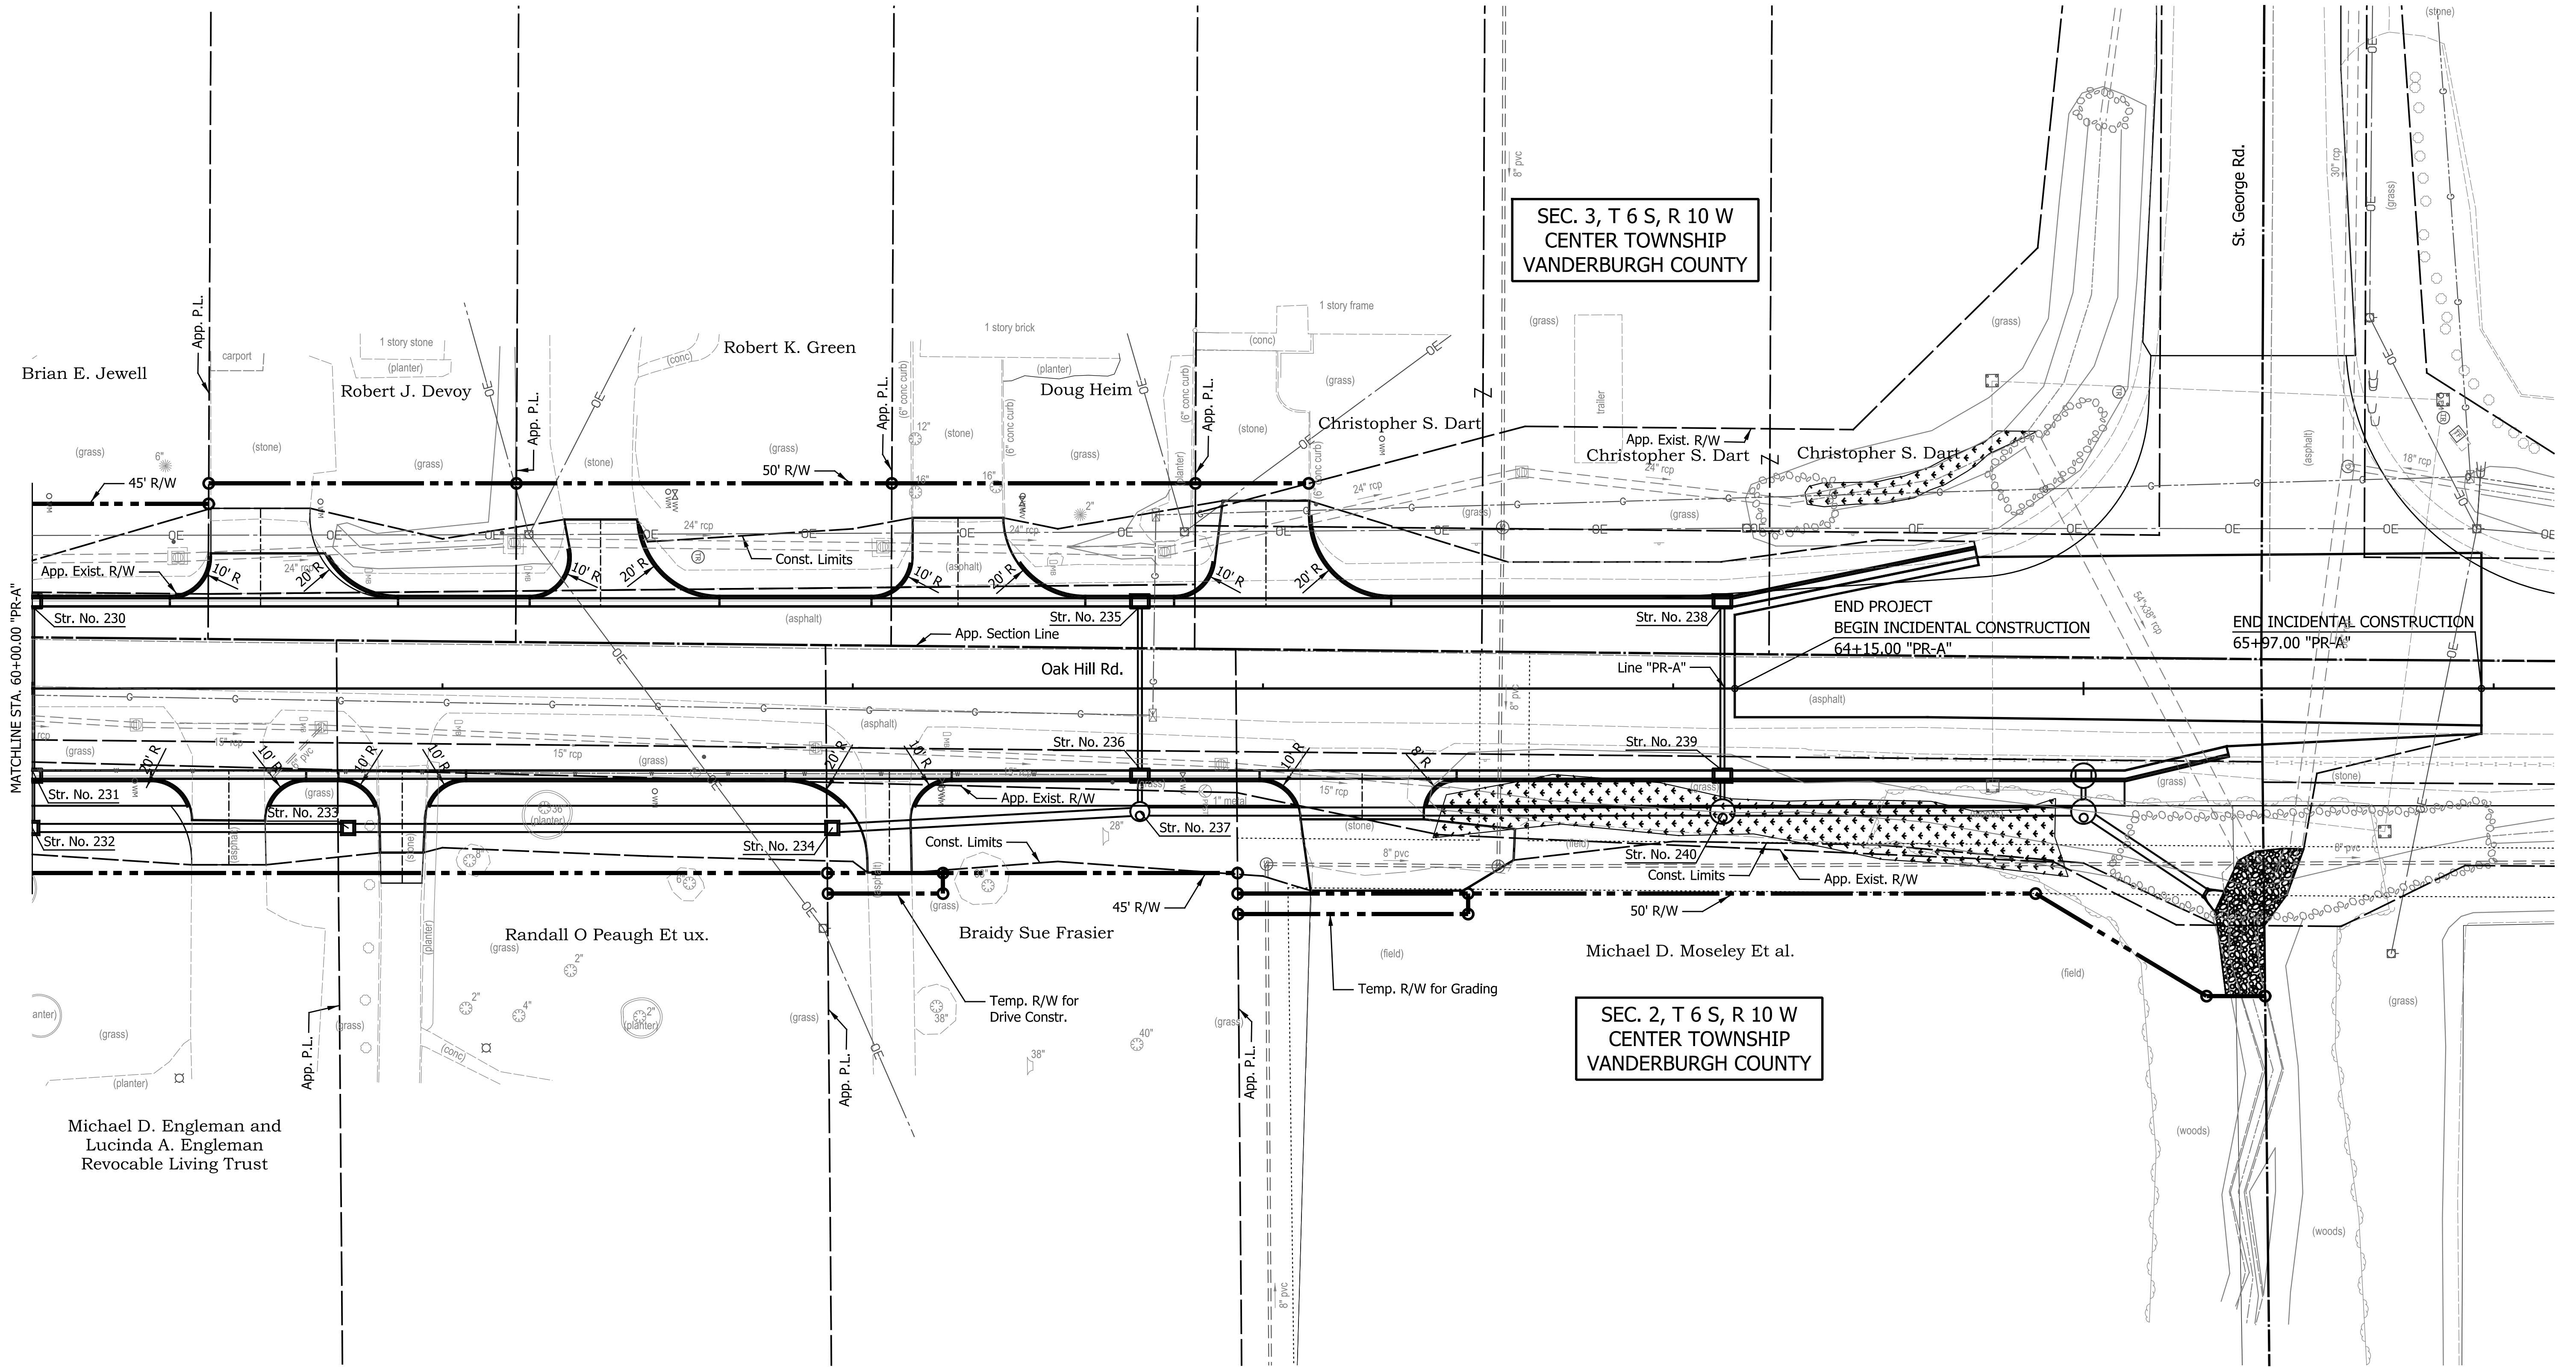

DATE	REVISION

LEGEND	
(K) Full Depth HMA Pavement (See Typical Section)	(C) PCCP For Approaches, 6 in.
(K1) Full Depth HMA Pavement (See Typical Section)	(C1) PCCP For Approaches, 9 in.
(R) Milling, Transition 165 #/Syd. QC/QA-HMA, 3, 70, Surface	(F) Sidewalk, Concrete, 4 in.
	(15) Curb and Gutter, Concrete


RECOMMENDED FOR APPROVAL	DESIGN ENGINEER	DATE
DESIGNED: JKH	DRAWN: BLP	
CHECKED: DSS	CHECKED: DSS	

INDIANA DEPARTMENT OF TRANSPORTATION


CONSTRUCTION DETAILS

OAK HILL ROAD

HORIZONTAL SCALE	BRIDGE FILE
1" = 20'	N/A
VERTICAL SCALE	DESIGNATION
N/A	2002538
SURVEY BOOK	SHEETS
N/A	35 of 117
CONTRACT	PROJECT
R-43470	2002538

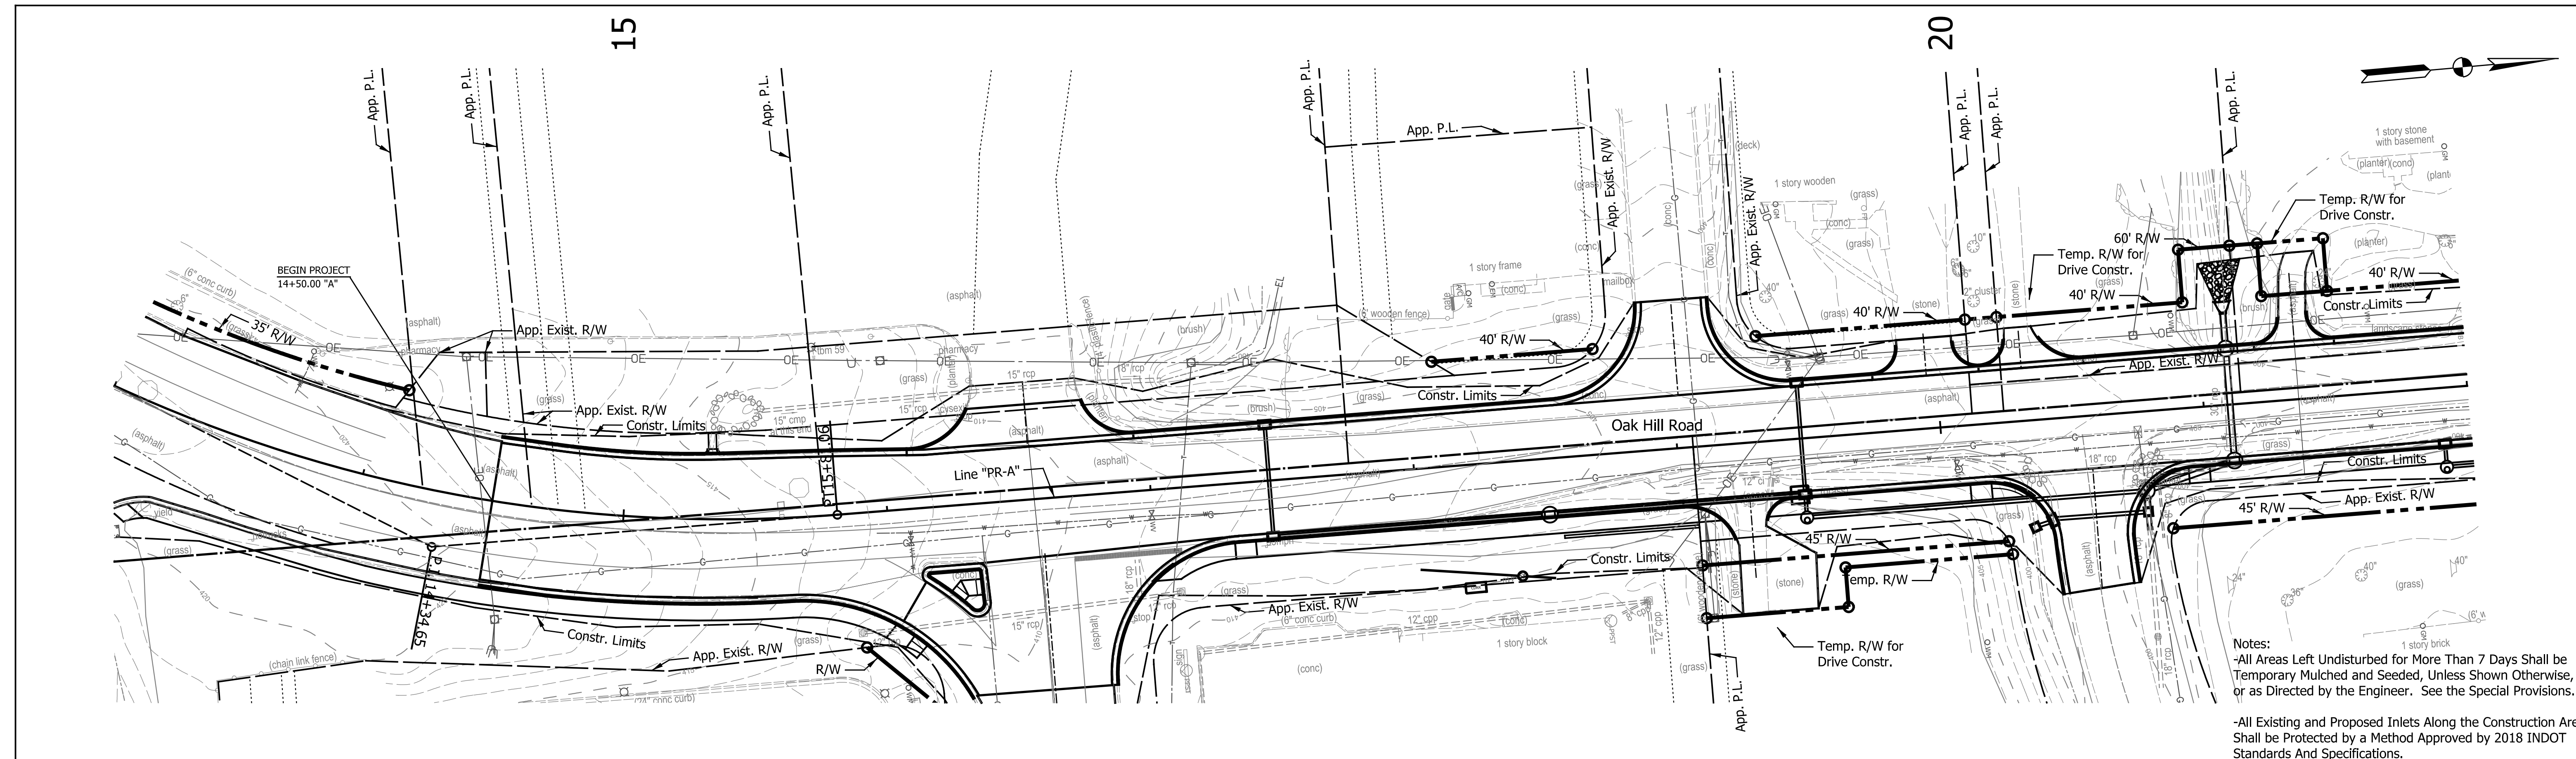

Notes:
 -All Areas Left Undisturbed for More Than 7 Days Shall be Temporary Mulched and Seeded, Unless Shown Otherwise, or as Directed by the Engineer. See the Special Provisions.
 -All Existing and Proposed Inlets Along the Construction Area Shall be Protected by a Method Approved by 2018 INDOT Standards And Specifications.

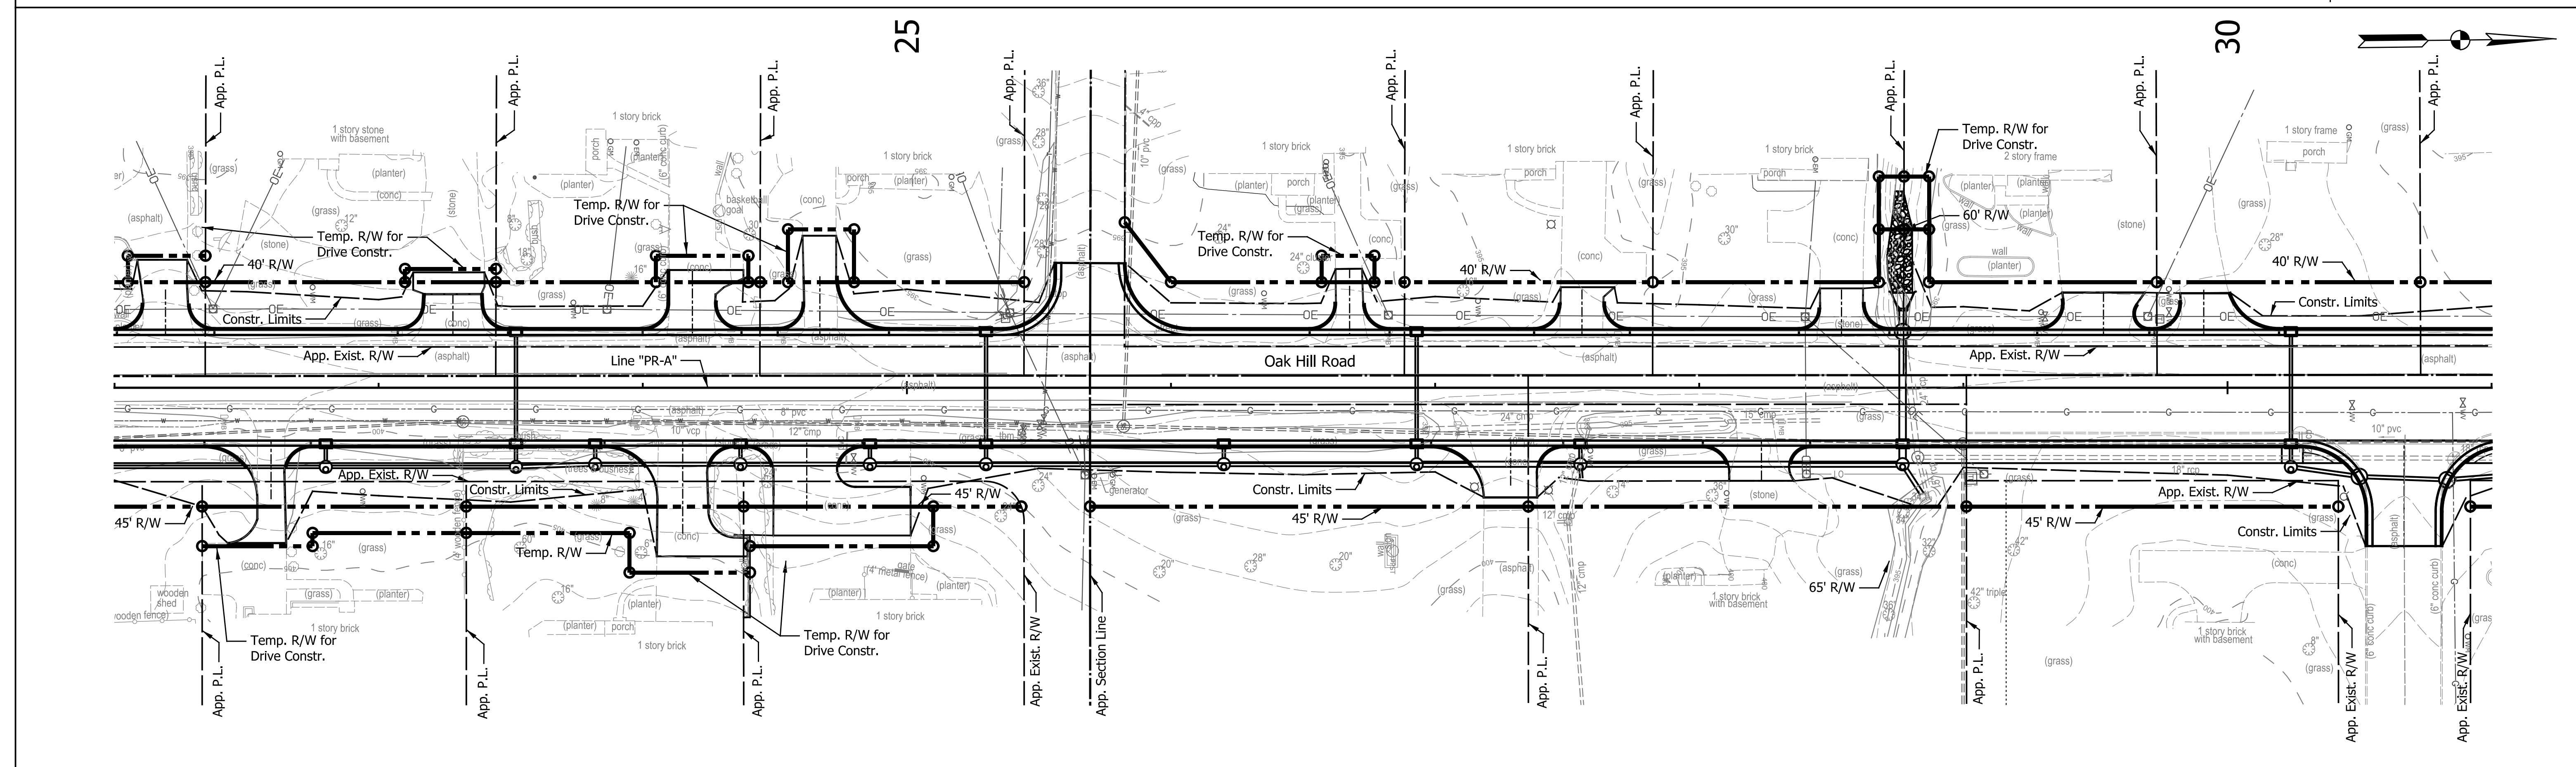

DATE	REVISION

LEGEND	
	Temporary Inlet Protection
	Temporary Silt Fence


RECOMMENDED FOR APPROVAL	DESIGN ENGINEER	DATE
DESIGNED: JKH	DRAWN: BLP	
CHECKED: DSS	CHECKED: DSS	

INDIANA DEPARTMENT OF TRANSPORTATION


EROSION CONTROL DETAILS

HORIZONTAL SCALE	BRIDGE FILE
1" = 30'-0"	N/A
VERTICAL SCALE	DESIGNATION
N/A	2002538
SURVEY BOOK	SHEETS
N/A	36 of 117
CONTRACT	PROJECT
R-43470	2002538

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Notes:
 -All Areas Left Undisturbed for More Than 7 Days Shall be Temporary Mulched and Seeded, Unless Shown Otherwise, or as Directed by the Engineer. See the Special Provisions.
 -All Existing and Proposed Inlets Along the Construction Area Shall be Protected by a Method Approved by 2018 INDOT Standards And Specifications.

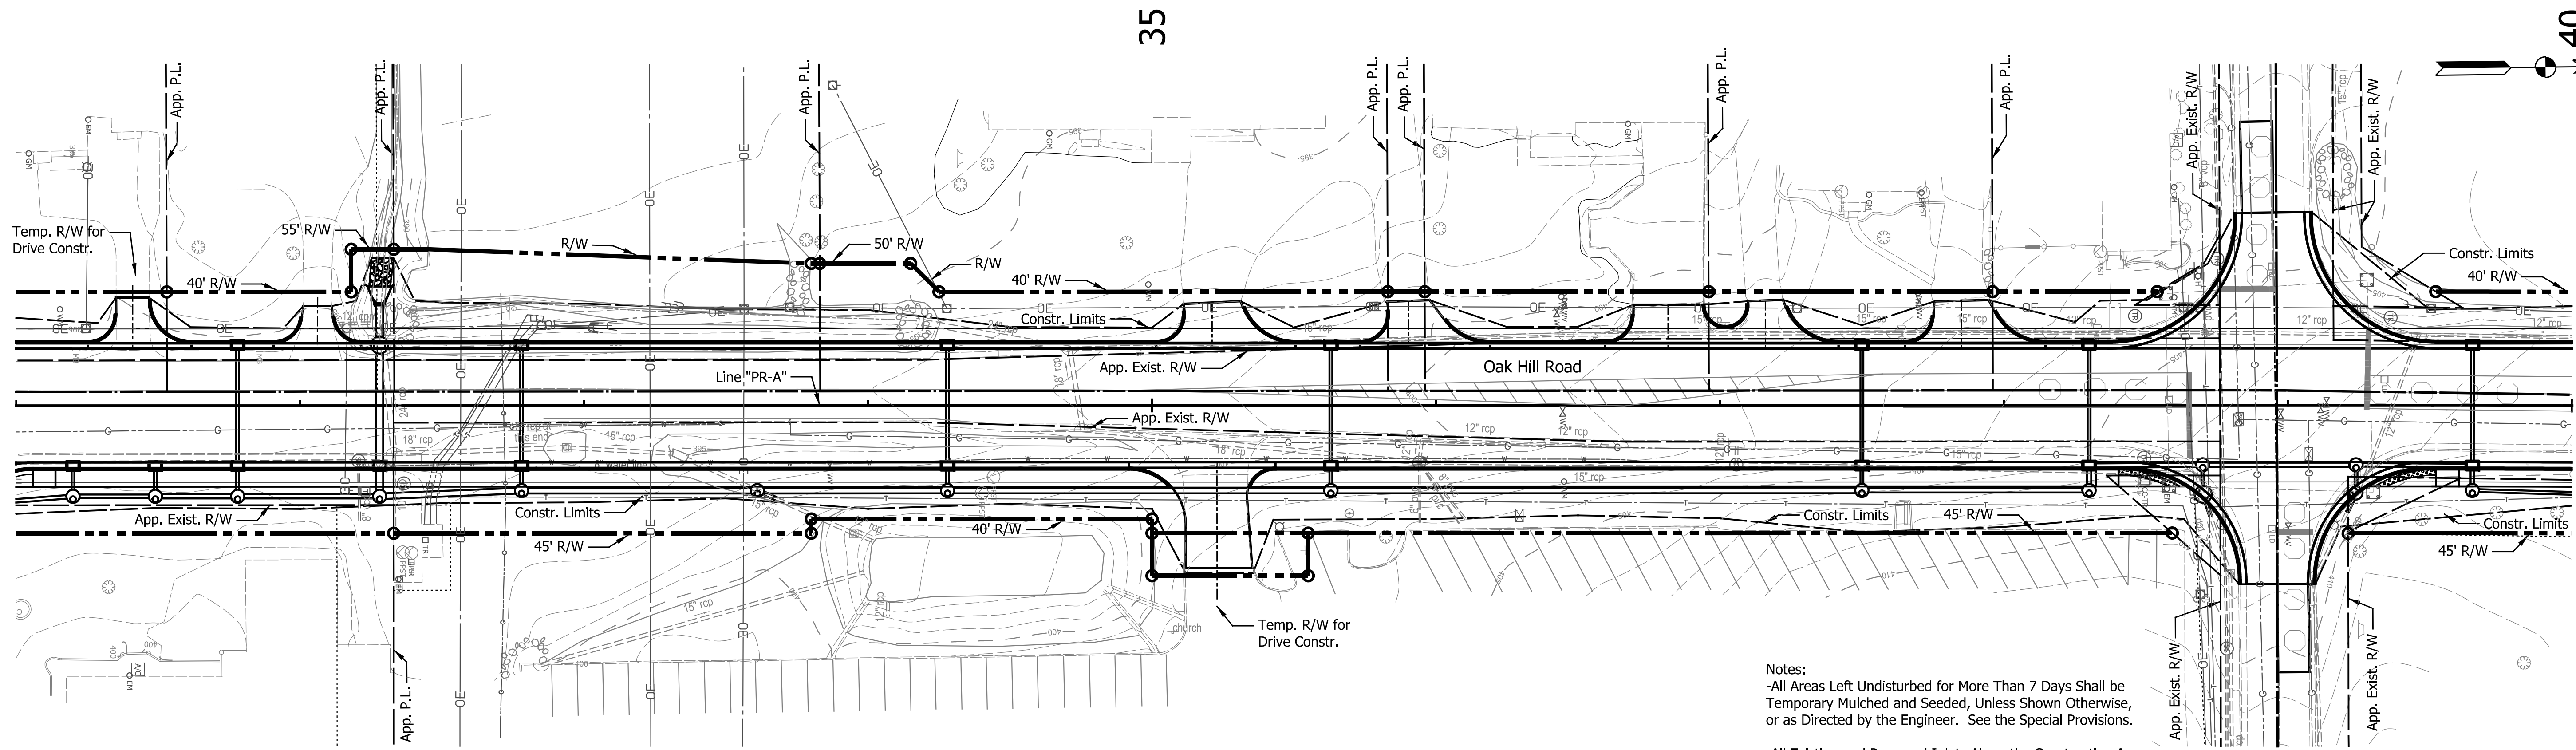

DATE	REVISION

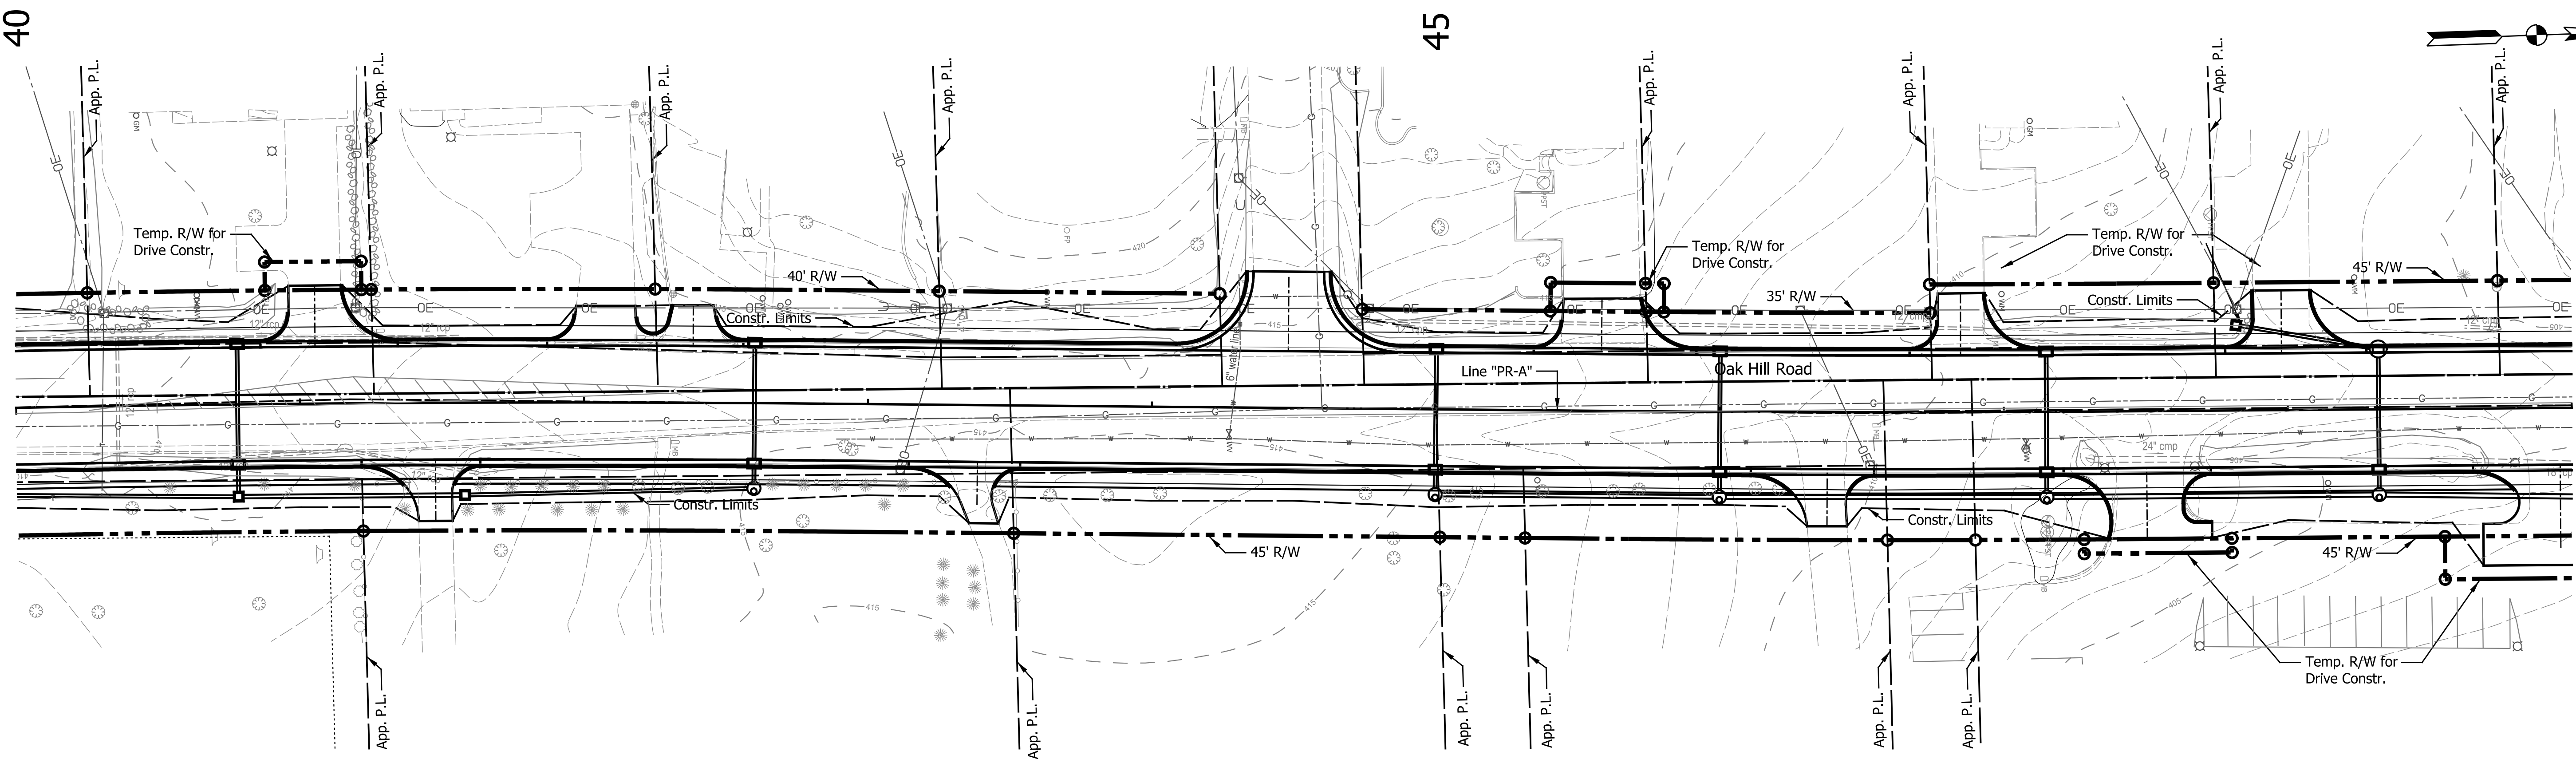
LEGEND	
	Temporary Inlet Protection
	Temporary Silt Fence

RECOMMENDED FOR APPROVAL	DESIGN ENGINEER	DATE
DESIGNED: JKH	DRAWN: BLP	
CHECKED: DSS	CHECKED: DSS	


INDIANA DEPARTMENT OF TRANSPORTATION
 EROSION CONTROL DETAILS

HORIZONTAL SCALE	BRIDGE FILE
1" = 30'-0"	N/A
VERTICAL SCALE	DESIGNATION
N/A	2002538
SURVEY BOOK	SHEETS
N/A	37 of 117
CONTRACT	PROJECT
R-43470	2002538

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Notes:
 -All Areas Left Undisturbed for More Than 7 Days Shall be Temporary Mulched and Seeded, Unless Shown Otherwise, or as Directed by the Engineer. See the Special Provisions.
 -All Existing and Proposed Inlets Along the Construction Area Shall be Protected by a Method Approved by 2018 INDOT Standards And Specifications.

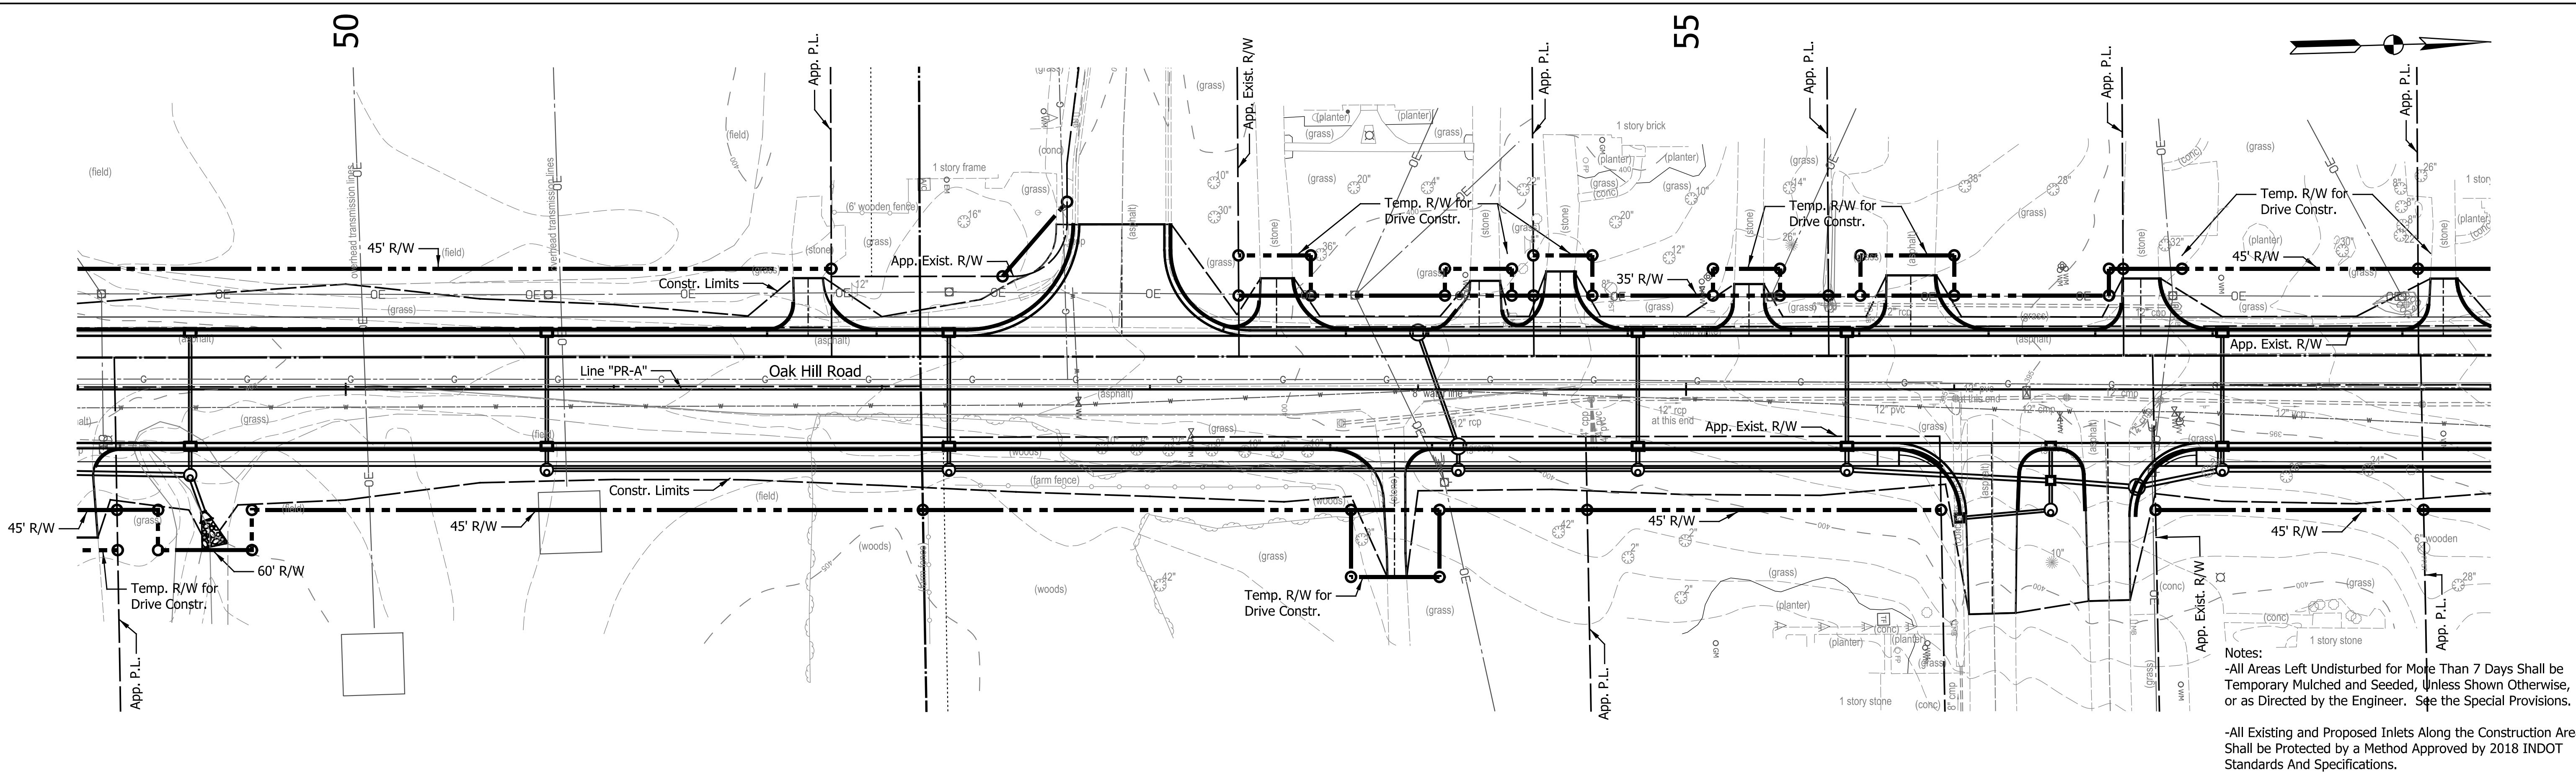

DATE	REVISION

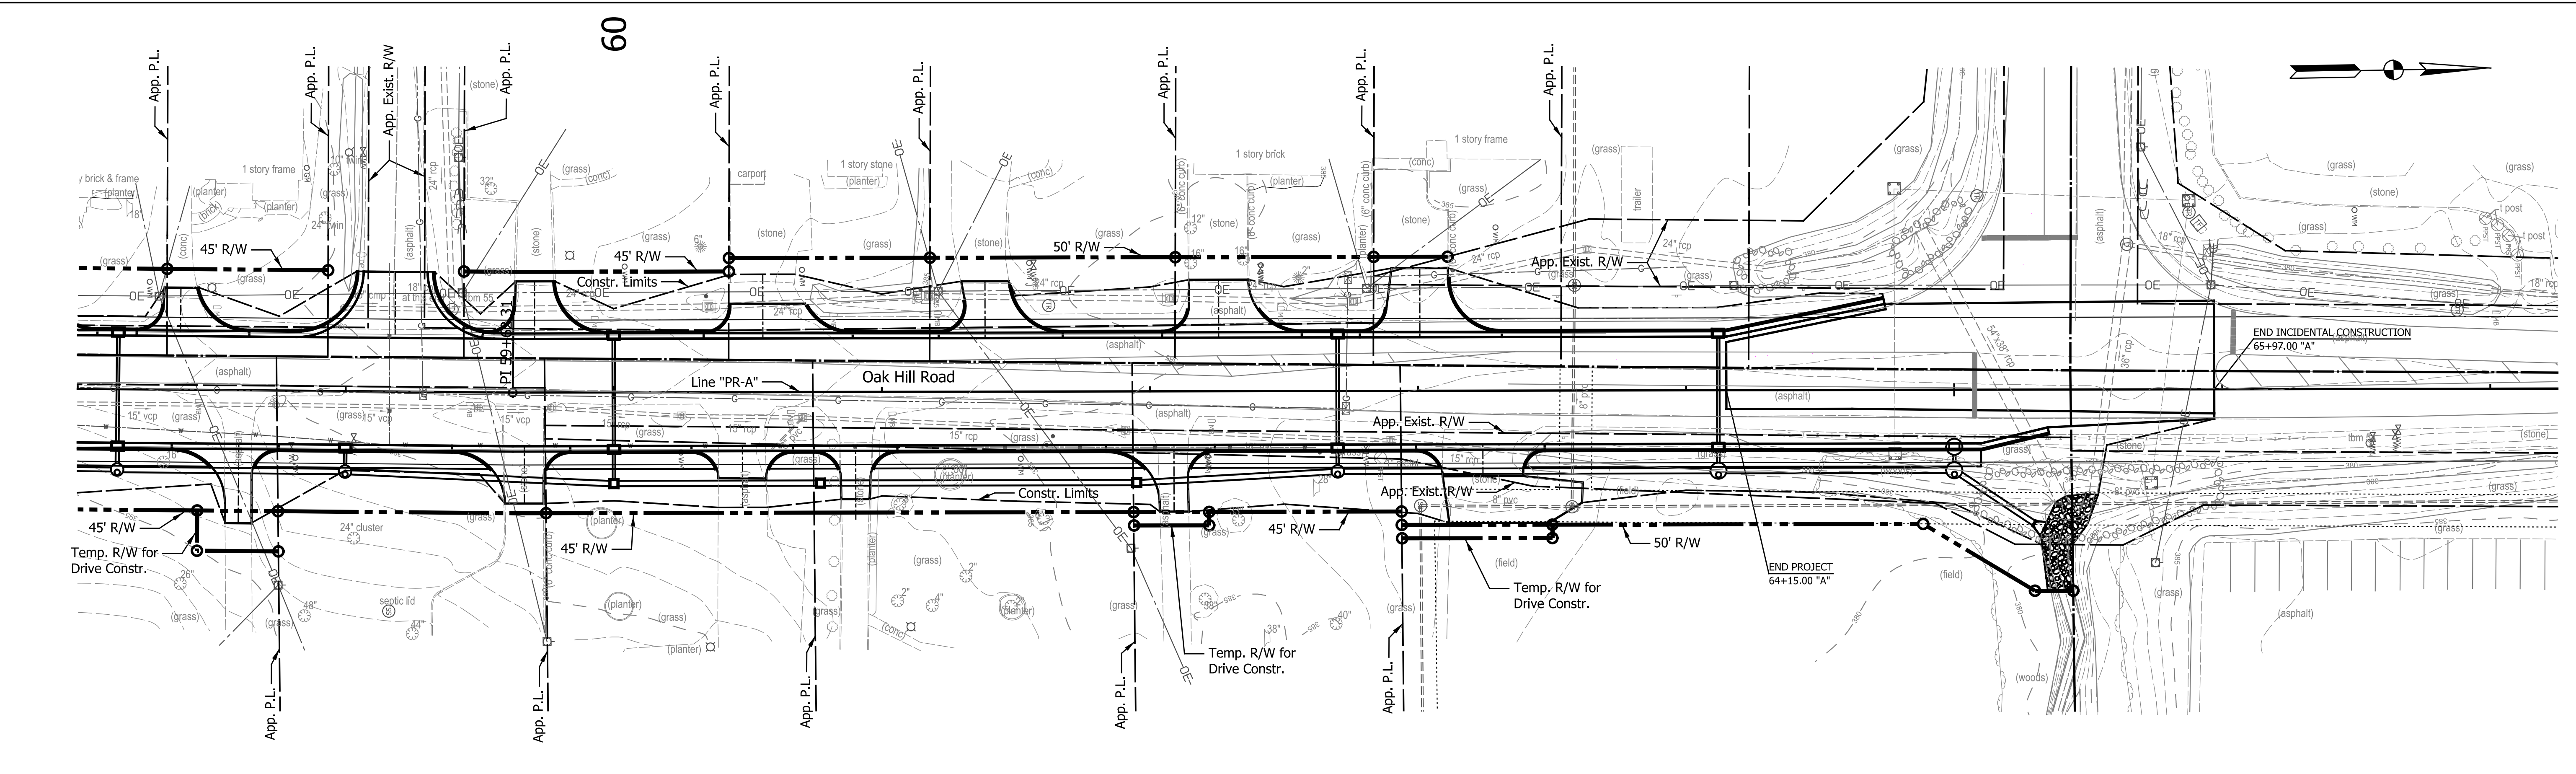LEGEND	
	Temporary Inlet Protection
	Temporary Silt Fence

RECOMMENDED FOR APPROVAL	DESIGN ENGINEER	DATE
DESIGNED: JKH	DRAWN: BLP	
CHECKED: DSS	CHECKED: DSS	



INDIANA DEPARTMENT OF TRANSPORTATION
EROSION CONTROL DETAILS

HORIZONTAL SCALE	BRIDGE FILE
1" = 30'-0"	N/A
VERTICAL SCALE	DESIGNATION
N/A	2002538
SURVEY BOOK	SHEETS
N/A	38 of 117
CONTRACT	PROJECT
R-43470	2002538

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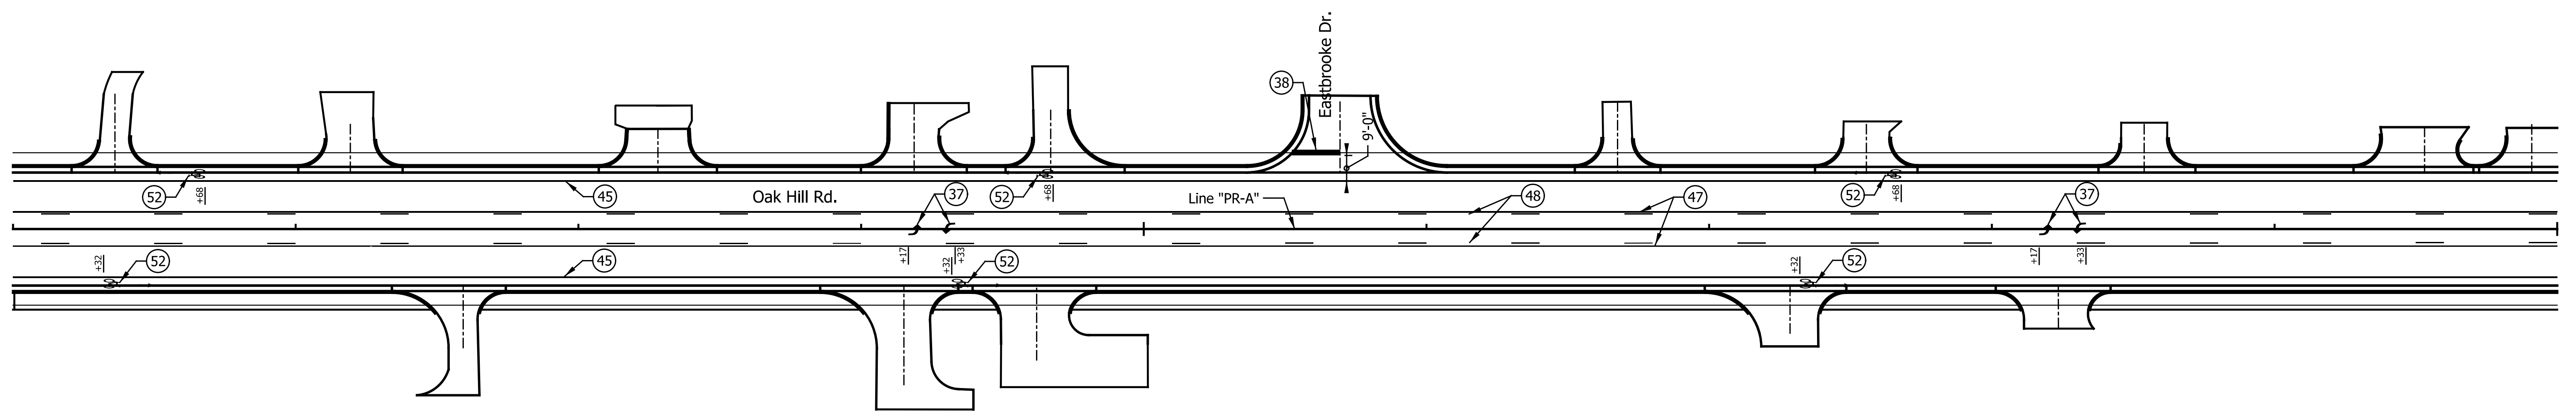
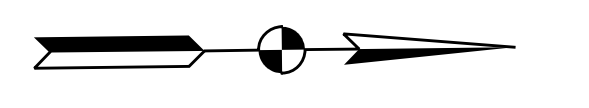
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25

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43 Transverse Marking, Thermoplastic, Parking Line, White 4 in.

LEGEND

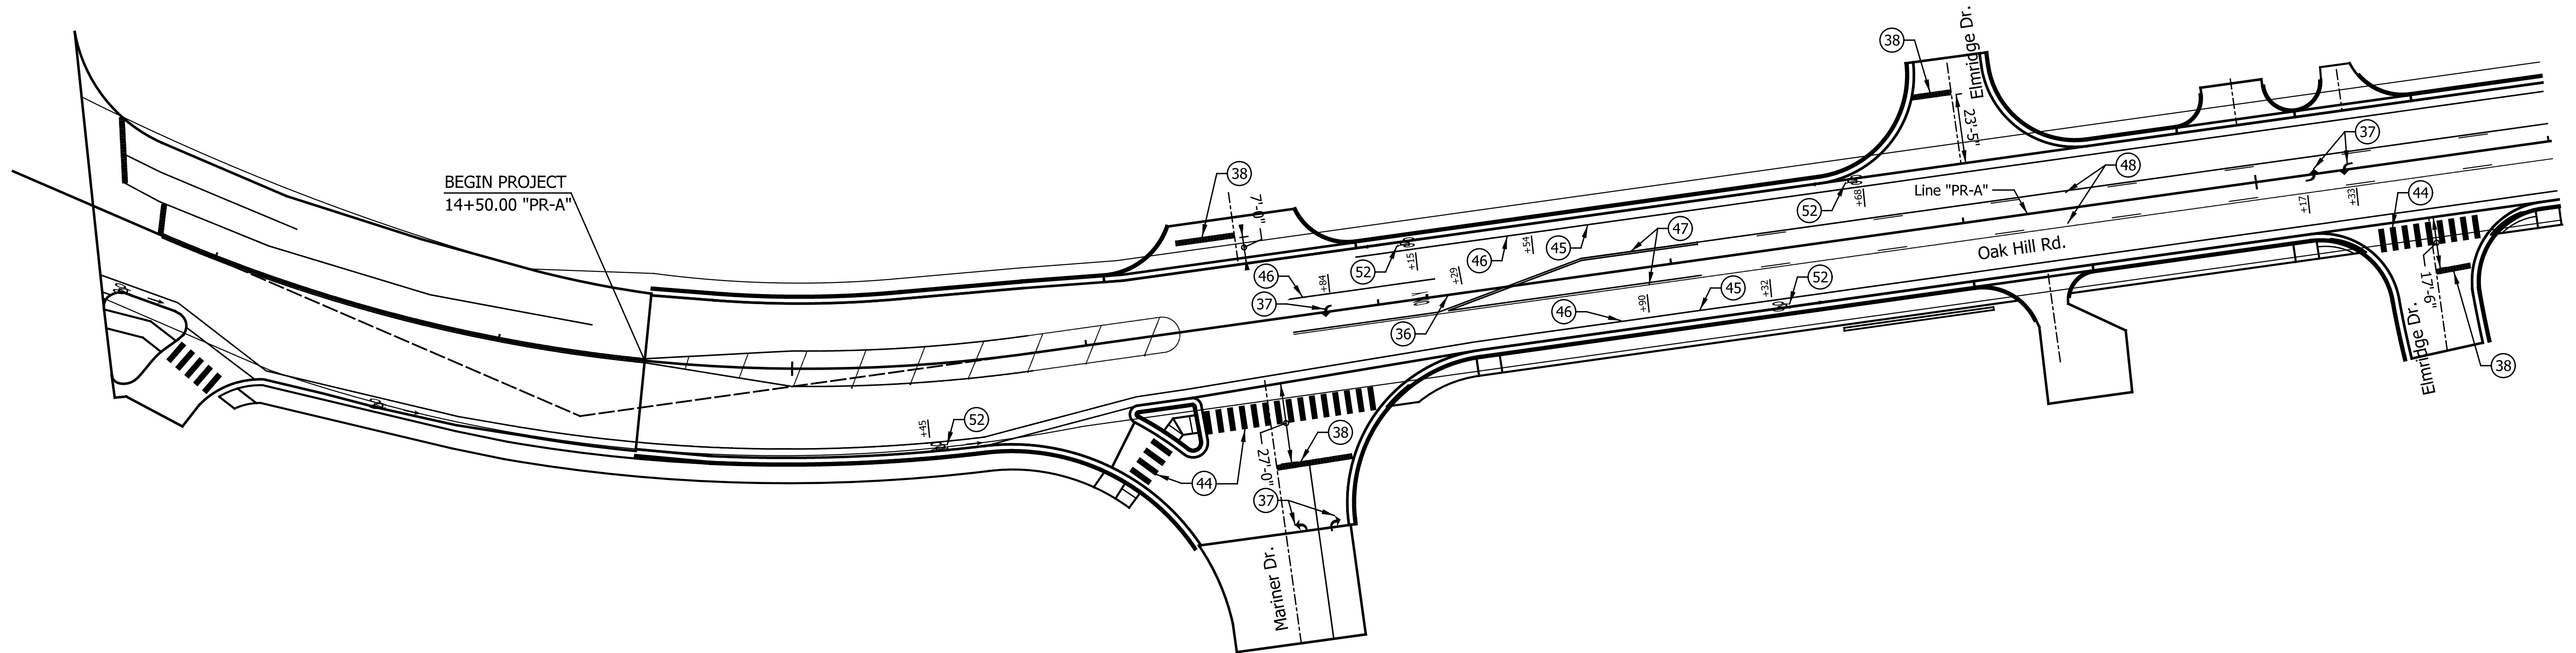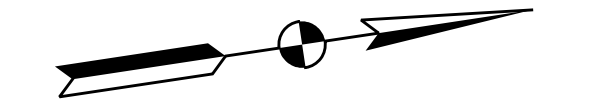36 Pavement Message Markings, Thermoplastic, Word (ONLY)

44 Transverse Marking, Thermoplastic, Crosswalk Line, 6 in.

48 Line, Thermoplastic, Broken, Yellow, 4 in.

37 Pavement Message Marking, Thermoplastic, Lane Indication Arrow

45 Line, Thermoplastic, Solid, White, 6 in.

49 Transverse Marking, Thermoplastic, Crosshatch Line, White, 12 in.

38 Transverse Markings, Thermoplastic, Stop Line, 24 in.

46 Line, Thermoplastic, Solid, White, 4 in.

50 Sign, Sheet, Relocate

39 Pavement Message Markings, Thermoplastic, Handicap Symbol

47 Line, Thermoplastic, Solid, Yellow, 4 in.

51 Sign, Remove

52 Pavement Message Marking, Thermoplastic, Shared Lane

RECOMMENDED FOR APPROVAL _____
DESIGN ENGINEER DATE

DESIGNED: JKH DRAWN: BLP

CHECKED: DSS CHECKED: DSS

INDIANA DEPARTMENT OF TRANSPORTATION

PAVEMENT MARKING DETAILS
LINE "PR-A"

HORIZONTAL SCALE BRIDGE FILE

1" = 30'-0" N/A

VERTICAL SCALE DESIGNATION

N/A 2002538

SURVEY BOOK SHEETS


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CONTRACT PROJECT

R-43470 2002538


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45



43 Transverse Marking, Thermoplastic, Parking Line, White 4 in.

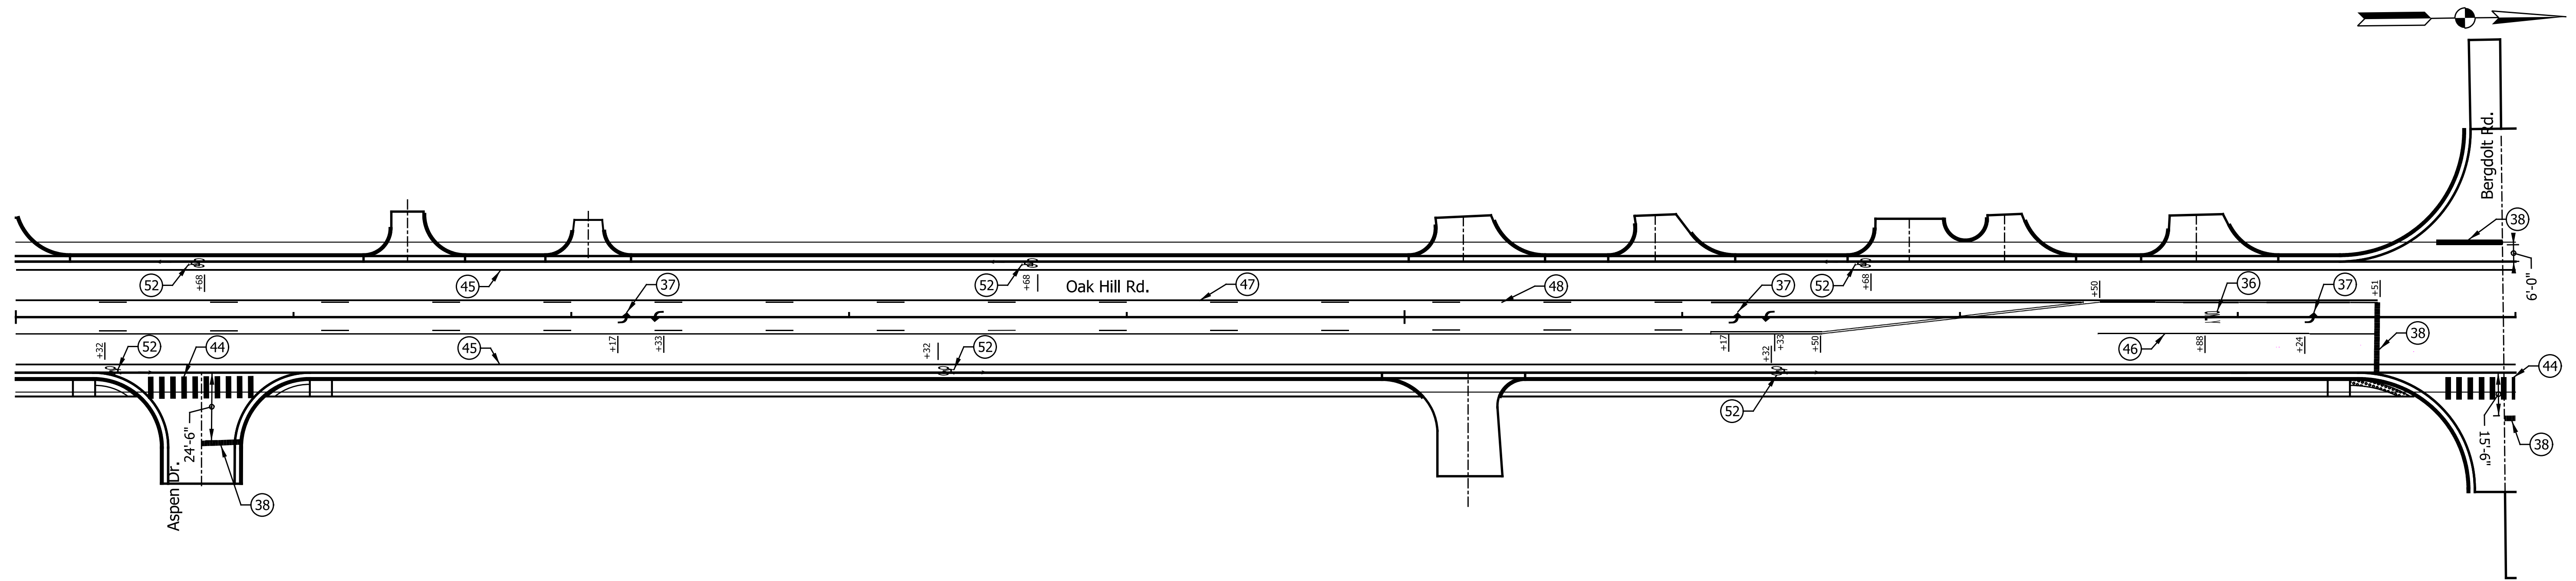LEGEND

36 Pavement Message Markings, Thermoplastic, Word (ONLY)

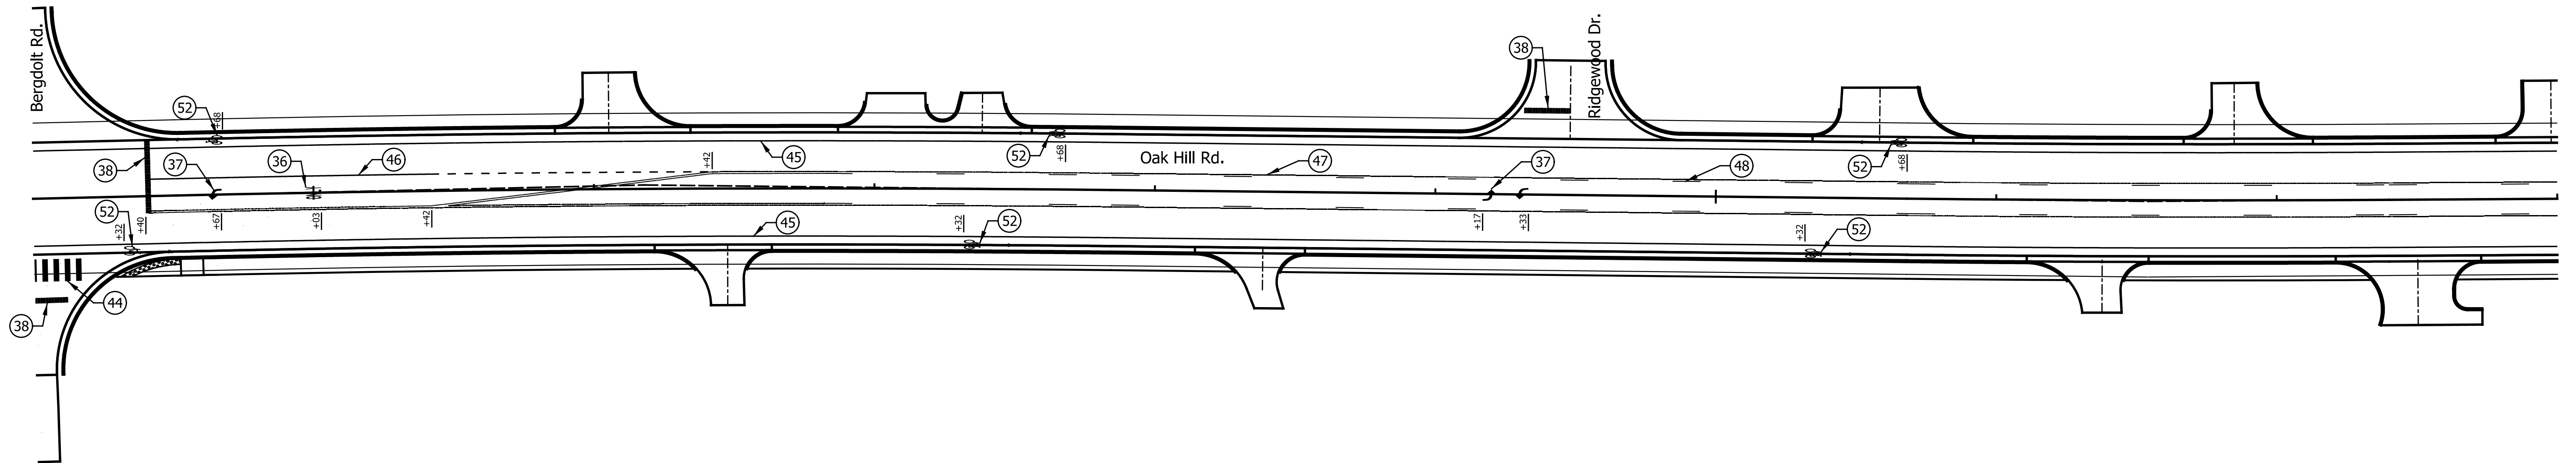44 Transverse Marking, Thermoplastic, Crosswalk Line, 6 in.

48 Line, Thermoplastic, Broken, Yellow, 4 in.

37 Pavement Message Marking, Thermoplastic, Lane Indication Arrow

45 Line, Thermoplastic, Solid, White, 6 in.

49 Transverse Marking, Thermoplastic, Crosshatch Line, White, 12 in.

38 Transverse Markings, Thermoplastic, Stop Line, 24 in.

46 Line, Thermoplastic, Solid, White, 4 in.

50 Sign, Sheet, Relocate

39 Pavement Message Markings, Thermoplastic, Handicap Symbol

47 Line, Thermoplastic, Solid, Yellow, 4 in.

51 Sign, Remove

52 Pavement Message Marking, Thermoplastic, Shared Lane

RECOMMENDED FOR APPROVAL _____ DESIGN ENGINEER DATE _____

DESIGNED: _____ JKH _____ DRAWN: _____ BLP _____

CHECKED: _____ DSS _____ CHECKED: _____ DSS _____

INDIANA DEPARTMENT OF TRANSPORTATION

PAVEMENT MARKING DETAILS LINE "PR-A"

HORIZONTAL SCALE BRIDGE FILE

1" = 30'-0" N/A

VERTICAL SCALE DESIGNATION

N/A 2002538

SURVEY BOOK SHEETS



N/A 40 of 117

CONTRACT PROJECT

R-43470 2002538



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55

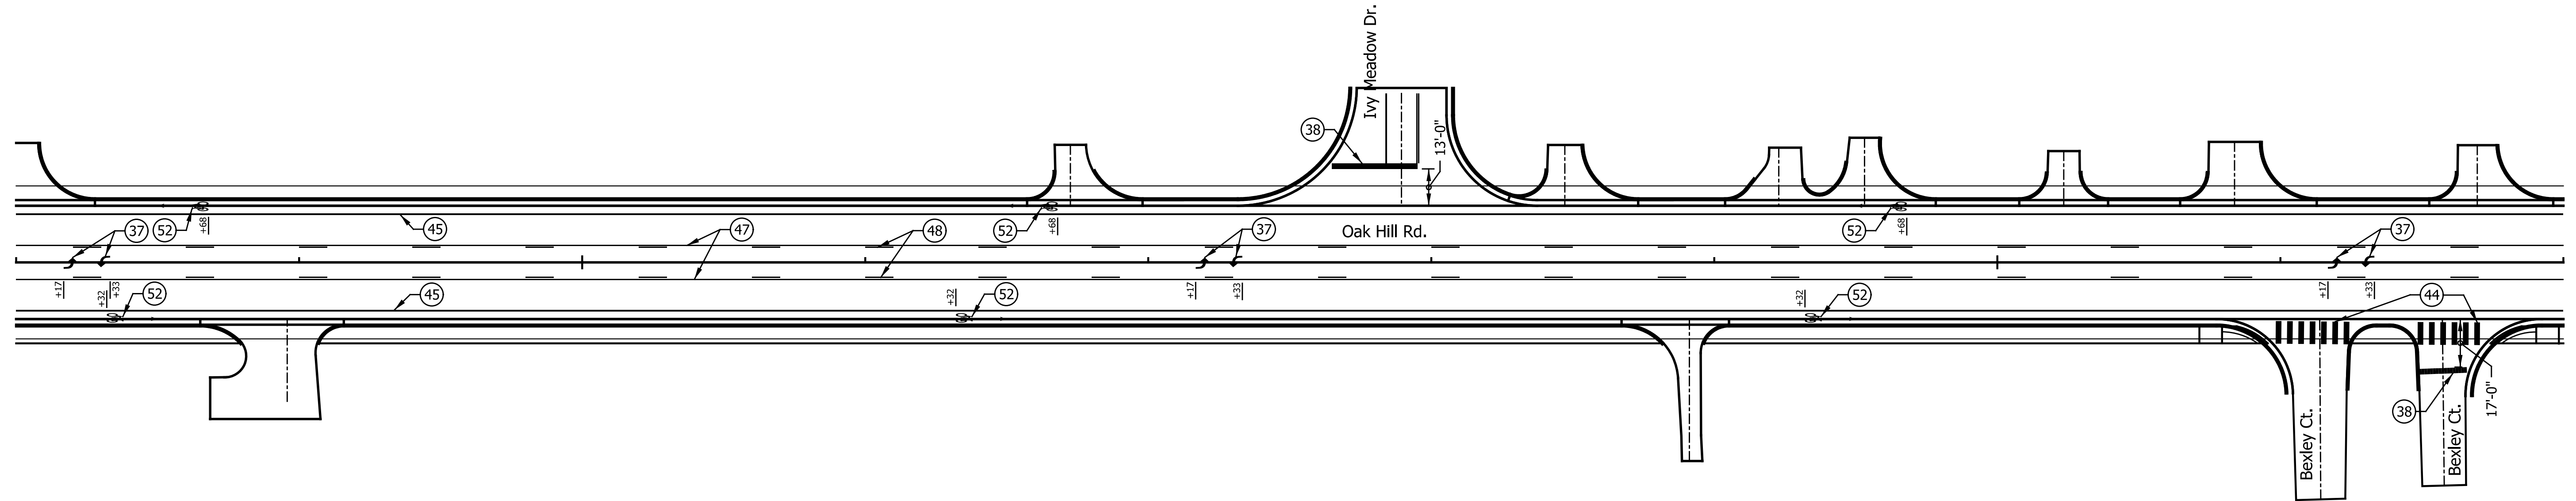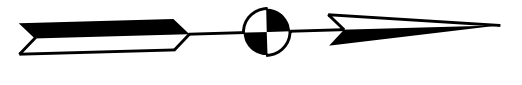

60

65

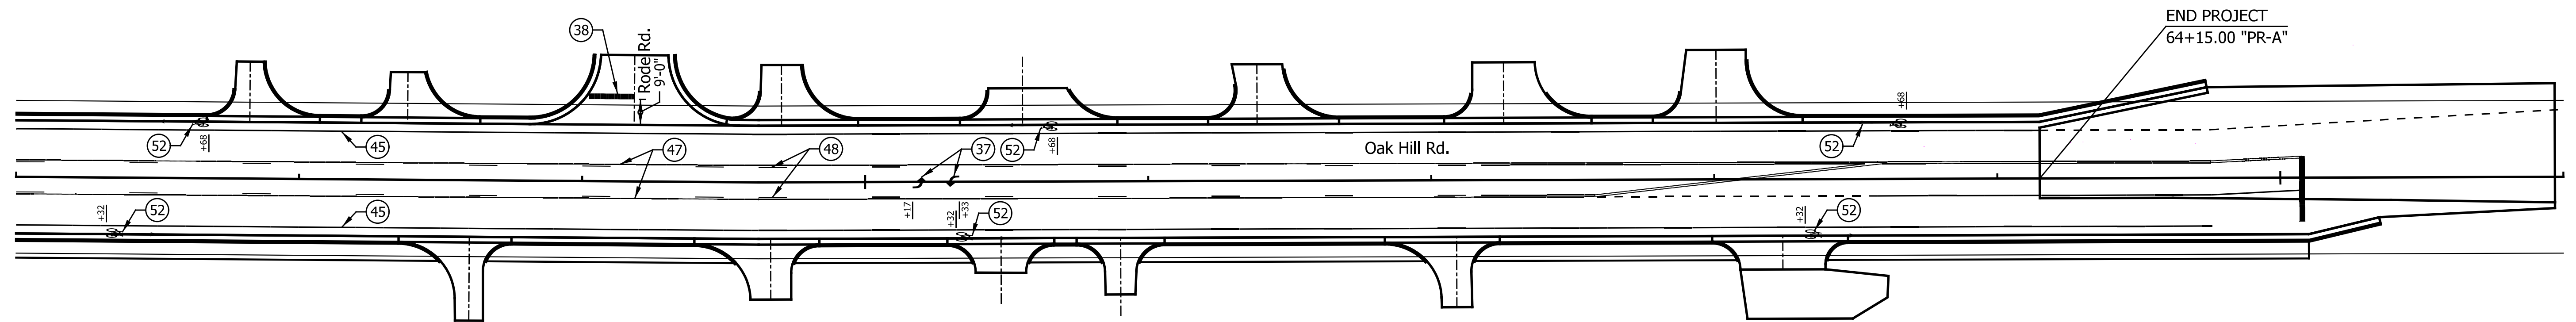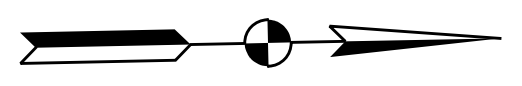

43 Transverse Marking, Thermoplastic, Parking Line, White 4 in.

LEGEND

36 Pavement Message Markings, Thermoplastic, Word (ONLY)

44 Transverse Marking, Thermoplastic, Crosswalk Line, 6 in.

48 Line, Thermoplastic, Broken, Yellow, 4 in.

37 Pavement Message Marking, Thermoplastic, Lane Indication Arrow

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46 Line, Thermoplastic, Solid, White, 4 in.

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47 Line, Thermoplastic, Solid, Yellow, 4 in.

51 Sign, Remove

52 Pavement Message Marking, Thermoplastic, Shared Lane

RECOMMENDED FOR APPROVAL _____ DESIGN ENGINEER DATE _____

DESIGNED: _____ JKH _____ DRAWN: _____ BLP _____

CHECKED: _____ DSS _____ CHECKED: _____ DSS _____

INDIANA DEPARTMENT OF TRANSPORTATION

PAVEMENT MARKING DETAILS LINE "PR-A"

HORIZONTAL SCALE BRIDGE FILE

1" = 30'-0" N/A

VERTICAL SCALE DESIGNATION

N/A 2002538

SURVEY BOOK SHEETS

N/A 41 of 117

CONTRACT PROJECT

R-43470 2002538

STRUCTURE DATA

STRUCTURE NUMBER	LOCATION					SIZE FT IN	DESCRIPTION MANHOLE, INLET, CATCH BASIN, OR SPECIALTY STRUCTURE AND TYPE	LENGTH LFT	SKEW	FLOW LINE			SERVICE LIFE YR.	SITE DESIGNATION	pH	BACKFILL METHOD	STRUCTURE BACKFILL CYS	TYPE	FLOWABLE BACKFILL CYS	TYPE	GEOTEXTILES SYS	REVTMENT RIPRAP TON	SCOUR PROTECTION				CONCRETE, CLASS A, FOR STRUCTURES CYS	VIDEO INSPECTION LFT	PIPE END SECTION EA	GRATED BOX END SECTION			SAFETY METAL END SECTION			CONNECT TO STR. NO.	REMARKS		
	STATION	LEFT	RIGHT	CROSS	OFFSET FT					PIPE TYPE	COVER FT	UP STREAM ELEV.											DOWN STREAM ELEV.	SUMP DEPTH IN	GEOTEXTILE SYS	RIPRAP TYPE				TONS	TYPE	SLOPE	EA	TYPE	SLOPE			EA	
																																							TYPE
Line "PR-A"					#N/A																																		
101	15+33.7	x																																					
102	17+45.0	x				12	2	Inlet B-15	39	2.3	402.83	402.33	50	NA	6.5	1	13.9																			103			
103	17+45.0		x			12	2	Inlet C-15	101	3.3	402.52	399.43	50	NA	6.5	1	49.7																				104		
104	18+50.0		x		20.0	12	2	Manhole C-4	93	3.6	399.43	397.30	50	NA	6.5	1	47.2																				106		
105	19+47.0	x				12	2	Inlet B-15	39	2.3	397.90	397.48	50	NA	6.5	1	13.6																				106		
106	19+47.0		x			12	2	Inlet C-15	5	3.6	397.30	397.14	50	NA	6.5	1	2.7																				107		
107	19+47.0		x		30.0	15	2	Manhole C-4	124	3.4	397.14	395.83	50	NA	6.5	1	69.5																				110		
108	20+33.0		x			15	2	#N/A	4	0.0	395.76	395.70	50	NA	6.5	1	0.5																				109		
109	20+41.0		x			15	2	Inlet B-15	33	2.1	395.70	395.22	50	NA	6.5	1	13.7																					111	
110	20+76.0		x		30.0	24	2	Manhole J-4	30	3.0	395.08	394.78	50	NA	6.5	1	19.9																					113	
111	20+76.0		x			24	2	Inlet F-7	4	0.8	395.17	395.08	50	NA	6.5	1	1.7																					110	
112	21+10.0	x				24	2	Manhole J-15	11	#VALUE!	394.42	394.25	50	NA	6.5	1	#####									1													
113	21+10.0		x			24	2	Manhole J-15	37	2.3	394.78	394.42	50	NA	6.5	1	20.2																					112	
114	21+90.0		x			12	2	Inlet C-15	5	2.3	395.32	395.23	50	NA	6.5	1	1.9																					115	
115	21+90.0		x		30.0	12	2	Manhole C-4	86	2.9	395.24	394.79	50	NA	6.5	1	34.2																					117	
116	22+80.0		x			12	2	Inlet C-15	5	3.0	394.87	394.78	50	NA	6.5	1	2.3																					117	
117	22+80.0		x		30.0	12	2	Manhole C-4	68	3.7	394.79	394.00	50	NA	6.5	1	35.2																					120	
118	23+52.0	x				12	2	Inlet B-15	39	2.3	394.51	394.09	50	NA	6.5	1	13.7																					119	
119	23+52.0		x			12	2	Inlet C-15	5	2.8	394.09	394.00	50	NA	6.5	1	2.1																					120	
120	23+52.0		x		30.0	15	2	Manhole C-4	26	4.1	393.75	393.60	50	NA	6.5	1	15.9																					122	
121	23+82.0		x			12	2	Inlet C-15	4	2.3	394.36	393.85	50	NA	6.5	1	1.6																					122	
122	23+82.0		x		29.0	15	2	Manhole C-4	51	3.4	393.60	393.33	50	NA	6.5	1	25.9																					124	
123	24+37.0		x			12	2	Inlet C-15	4	3.5	394.09	393.57	50	NA	6.5	1	2.2																					124	
124	24+37.0		x		29.0	15	2	Manhole C-4	45	3.4	393.32	393.08	50	NA	6.5	1	22.9																					126	

DATE	REVISION

RECOMMENDED FOR APPROVAL	DESIGN ENGINEER	DATE
DESIGNED: JKH	DRAWN: BLP	
CHECKED: DSS	CHECKED: DSS	

INDIANA DEPARTMENT OF TRANSPORTATION

STRUCTURE DATA TABLE

HORIZONTAL SCALE	BRIDGE FILE
N/A	N/A
VERTICAL SCALE	DESIGNATION
N/A	2002538
SURVEY BOOK	SHEETS
N/A	46 of 117
CONTRACT	PROJECT
R-43470	2002538

STRUCTURE DATA

STRUCTURE NUMBER	LOCATION					SIZE FT IN	DESCRIPTION PIPE TYPE MANHOLE, INLET, CATCH BASIN, OR SPECIALTY STRUCTURE AND TYPE	LENGTH LFT	SKEW	FLOW LINE			SERVICE LIFE YR.	SITE DESIGNATION	pH	BACKFILL METHOD	STRUCTURE BACKFILL CYS	TYPE	FLOWABLE BACKFILL CYS	TYPE	GEOTEXTILES SYS	REVETMENT RIPRAP TON	SCOUR PROTECTION				CONCRETE, CLASS A, FOR STRUCTURES CYS	VIDEO INSPECTION LFT	PIPE END SECTION EA	GRATED BOX END SECTION			SAFETY METAL END SECTION			CONNECT TO STR. NO.	REMARKS		
	STATION	LEFT	RIGHT	CROSS	OFFSET					COVER FT	UP STREAM ELEV.	DOWN STREAM ELEV.											SUMP DEPTH IN	GEOTEXTILE SYS	RIPRAP TYPE	TONS				TYPE	SLOPE	EA	TYPE	SLOPE	EA				
																																						TYPE	SLOPE
125	24+86.0	x				12	2	Inlet C-15	4		3.5	393.84	392.27	50	NA	6.5	1	2.5																			126		
126	24+86.0		x		29.0	18	2	Manhole C-4	40		3.4	392.83	392.62	50	NA	6.5	1	22.9																			129		
127	25+30.0	x				12	2	Inlet B-15	39		2.3	393.62	393.20	50	NA	6.5	1	13.7																			128		
128	25+30.0		x			12	2	Inlet C-15	4		2.8	393.20	393.12	50	NA	6.5	1	1.7																			129		
129	25+30.0		x		29.0	18	2	Manhole C-4	86		4.5	392.62	392.26	50	NA	6.5	1	64.6																			131		
130	26+20.0		x			12	2	Inlet C-15	4		2.3	393.17	392.66	50	NA	6.5	1	1.6																			131		
131	26+20.0		x		29.0	18	2	Manhole C-4	69		3.3	392.26	391.81	50	NA	6.5	1	39.0																			134		
132	26+93.0	x				12	2	Inlet B-15	39		0.0	392.81	392.38	50	NA	6.5	1	10.1																			133		
133	26+93.0		x			12	2	Inlet C-15	4		0.0	392.38	392.30	50	NA	6.5	1	0.9																			134		
134	26+93.0		x		29.0	24	2	Manhole C-4	58		0.0	391.56	391.19	50	NA	6.5	1	22.8																			137		
135	27+53.5		x			12	2	#N/A	3		0.8	393.83	393.60	50	NA	6.5	1	0.7																			137		
136	27+55.0		x			12	2	Inlet C-15	4		2.3	392.50	392.19	50	NA	6.5	1	1.5																			137		
137	27+55.0		x		29.0	24	2	Manhole C-4	118		3.8	391.19	390.70	50	NA	6.5	1	90.5																			140		
138	28+77.0	x				30	2	Manhole J-15	6		#VALUE!	390.26	390.16	50	NA	6.5	1	#####									1												
139	28+77.0		x			30	2	Inlet C-15	38		2.1	390.67	390.26	50	NA	6.5	1	23.5																				138	
140	28+77.0		x		29.0	30	2	Manhole C-4	4		2.7	390.70	390.67	50	NA	6.5	1	3.1																				139	
141	28+85.0		x			18	2	#N/A	11		#VALUE!	391.78	391.45	50	NA	6.5	1	#####																				140	
142	30+24.0	x				12	2	Inlet B-15	39		2.3	391.15	390.73	50	NA	6.5	1	13.7																				143	
143	30+24.0		x			12	2	Inlet C-15	5		3.4	390.73	390.64	50	NA	6.5	1	2.5																				144	
144	30+24.0		x		30.0	15	2	Manhole C-4	21		3.0	390.39	389.67	50	NA	6.5	1	11.2																				145	
145	30+51.0		x			15	2	Manhole J-15	28		2.3	389.67	389.33	50	NA	6.5	1	10.8																				146	
146	30+82.0		x			15	2	Manhole J-15	32		3.2	389.33	389.15	50	NA	6.5	1	19.1																				148	
147	31+20.0		x			12	2	Inlet C-15	7		3.0	390.67	390.46	50	NA	6.5	1	3.2																				148	
148	31+20.0		x		32.0	15	2	Manhole C-4	25		4.1	389.15	389.01	50	NA	6.5	1	15.3																				150	
149	31+49.0		x			12	2	Inlet C-15	7		0.0	390.53	390.17	50	NA	6.5	1	1.7																				150	

DATE	REVISION

RECOMMENDED FOR APPROVAL	DESIGN ENGINEER	DATE
DESIGNED: JKH	DRAWN: BLP	
CHECKED: DSS	CHECKED: DSS	

INDIANA DEPARTMENT OF TRANSPORTATION

STRUCTURE DATA TABLE

HORIZONTAL SCALE	BRIDGE FILE
N/A	N/A
VERTICAL SCALE	DESIGNATION
N/A	2002538
SURVEY BOOK	SHEETS
N/A	47 of 117
CONTRACT	PROJECT
R-43470	2002538

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STRUCTURE DATA

STRUCTURE NUMBER	LOCATION					DESCRIPTION MANHOLE, INLET, CATCH BASIN, OR SPECIALTY STRUCTURE AND TYPE	LENGTH LFT	SKEW	FLOW LINE			SERVICE LIFE YR.	SITE DESIGNATION	PH	BACKFILL METHOD	STRUCTURE BACKFILL CYS	TYPE	FLOWABLE BACKFILL CYS	TYPE	GEOTEXTILES SYS	REVETMENT RIPRAP TON	SCOUR PROTECTION			CONCRETE CLASS A, FOR STRUCTURES CYS	VIDEO INSPECTION LFT	PIPE END SECTION EA	GRATED BOX END SECTION			SAFETY METAL END SECTION			CONNECT TO STR. NO.	REMARKS					
	STATION	LEFT	RIGHT	CROSS	OFFSET FT				SIZE IN	PIPE TYPE	COVER FT											UP STREAM ELEV.	DOWN STREAM ELEV.	SUMP DEPTH IN				GEOTEXTILE SYS	RIPRAP TYPE	TONS	TYPE	SLOPE	EA			TYPE	SLOPE	EA		
																																							TYPE	SLOPE
572	42+60.0		x		30.0	12	2	Manhole C-4	177																									569						
573	45+00.0	x				12	2	Inlet B-15	39																										574					
574	45+00.0		x			18	2	Inlet C-15	5																										575	Replace Existing Structure; Use Existing Pipe				
575	45+00.0		x		30.0	18	2	Manhole C-4	159																											578				
576	46+63.0	x				12	2	Inlet B-15	39																											577				
577	46+63.0		x			18	2	Inlet C-15	5																											578	Replace Existing Structure; Use Existing Pipe			
578	46+63.0		x		30.0	18	2	Manhole C-4	165																											581				
579	48+32.0	x				12	2	Inlet B-15	39																												580			
580	48+32.0		x			18	2	Inlet C-15	5																												581			
581	48+32.0		x		30.0	18	2	Manhole C-4	106																												584	Replace Existing Structure; Use Existing Pipe		
582	49+42.0	x				12	2	Inlet B-15	39																												583			
583	49+42.0		x			18	2	Inlet C-15	7																												584	Replace Existing Structure; Use Existing Pipe		
584	49+42.0		x		32.0	18	2	Manhole C-4	13																	1														
585	50+75.0	x				12	2	Inlet B-15	39																												586	Intercept Existing Trunkline; Replace Existing Pipe		
586	50+75.0		x			12	2	Inlet C-15	5																													587		
587	50+75.0		x		30.0	12	2	Manhole C-4	146																													590	Replace Existing Structure; Replace Existing Pipe	
588	52+25.0	x				12	2	Inlet B-15	39																													589		
589	52+25.0		x			12	2	Inlet C-15	5																													590		
590	52+25.0		x		30.0	12	2	Manhole C-4	186																													593	Intercept Existing Trunkline; Replace Existing Pipe	
591	54+00.0	x				12	2	Manhole J-15	40																													592		
592	54+15.0		x			12	2	Manhole J-15	4																														593	Replace Existing Structure; Replace Existing Pipe
593	54+15.0		x		30.0	12	2	Manhole C-4	63																														596	Adjust Casting to Grade
594	54+82.0	x				12	2	Inlet B-15	39																														595	
595	54+82.0		x			12	2	Inlet C-15	5																														596	Replace Existing Structure; Replace Existing Pipe
596	54+82.0		x		30.0	12	2	Manhole C-4	74																														599	

DATE	REVISION


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DESIGNED: JKH	DRAWN: BLP	
CHECKED: DSS	CHECKED: DSS	

**INDIANA DEPARTMENT
OF TRANSPORTATION**

STRUCTURE DATA TABLE

HORIZONTAL SCALE	BRIDGE FILE
N/A	N/A
VERTICAL SCALE	DESIGNATION
N/A	2002538
SURVEY BOOK	SHEETS
N/A	49 of 117
CONTRACT	PROJECT
R-43470	2002538

Project: 2002538
Indiana State Dept of Transportation

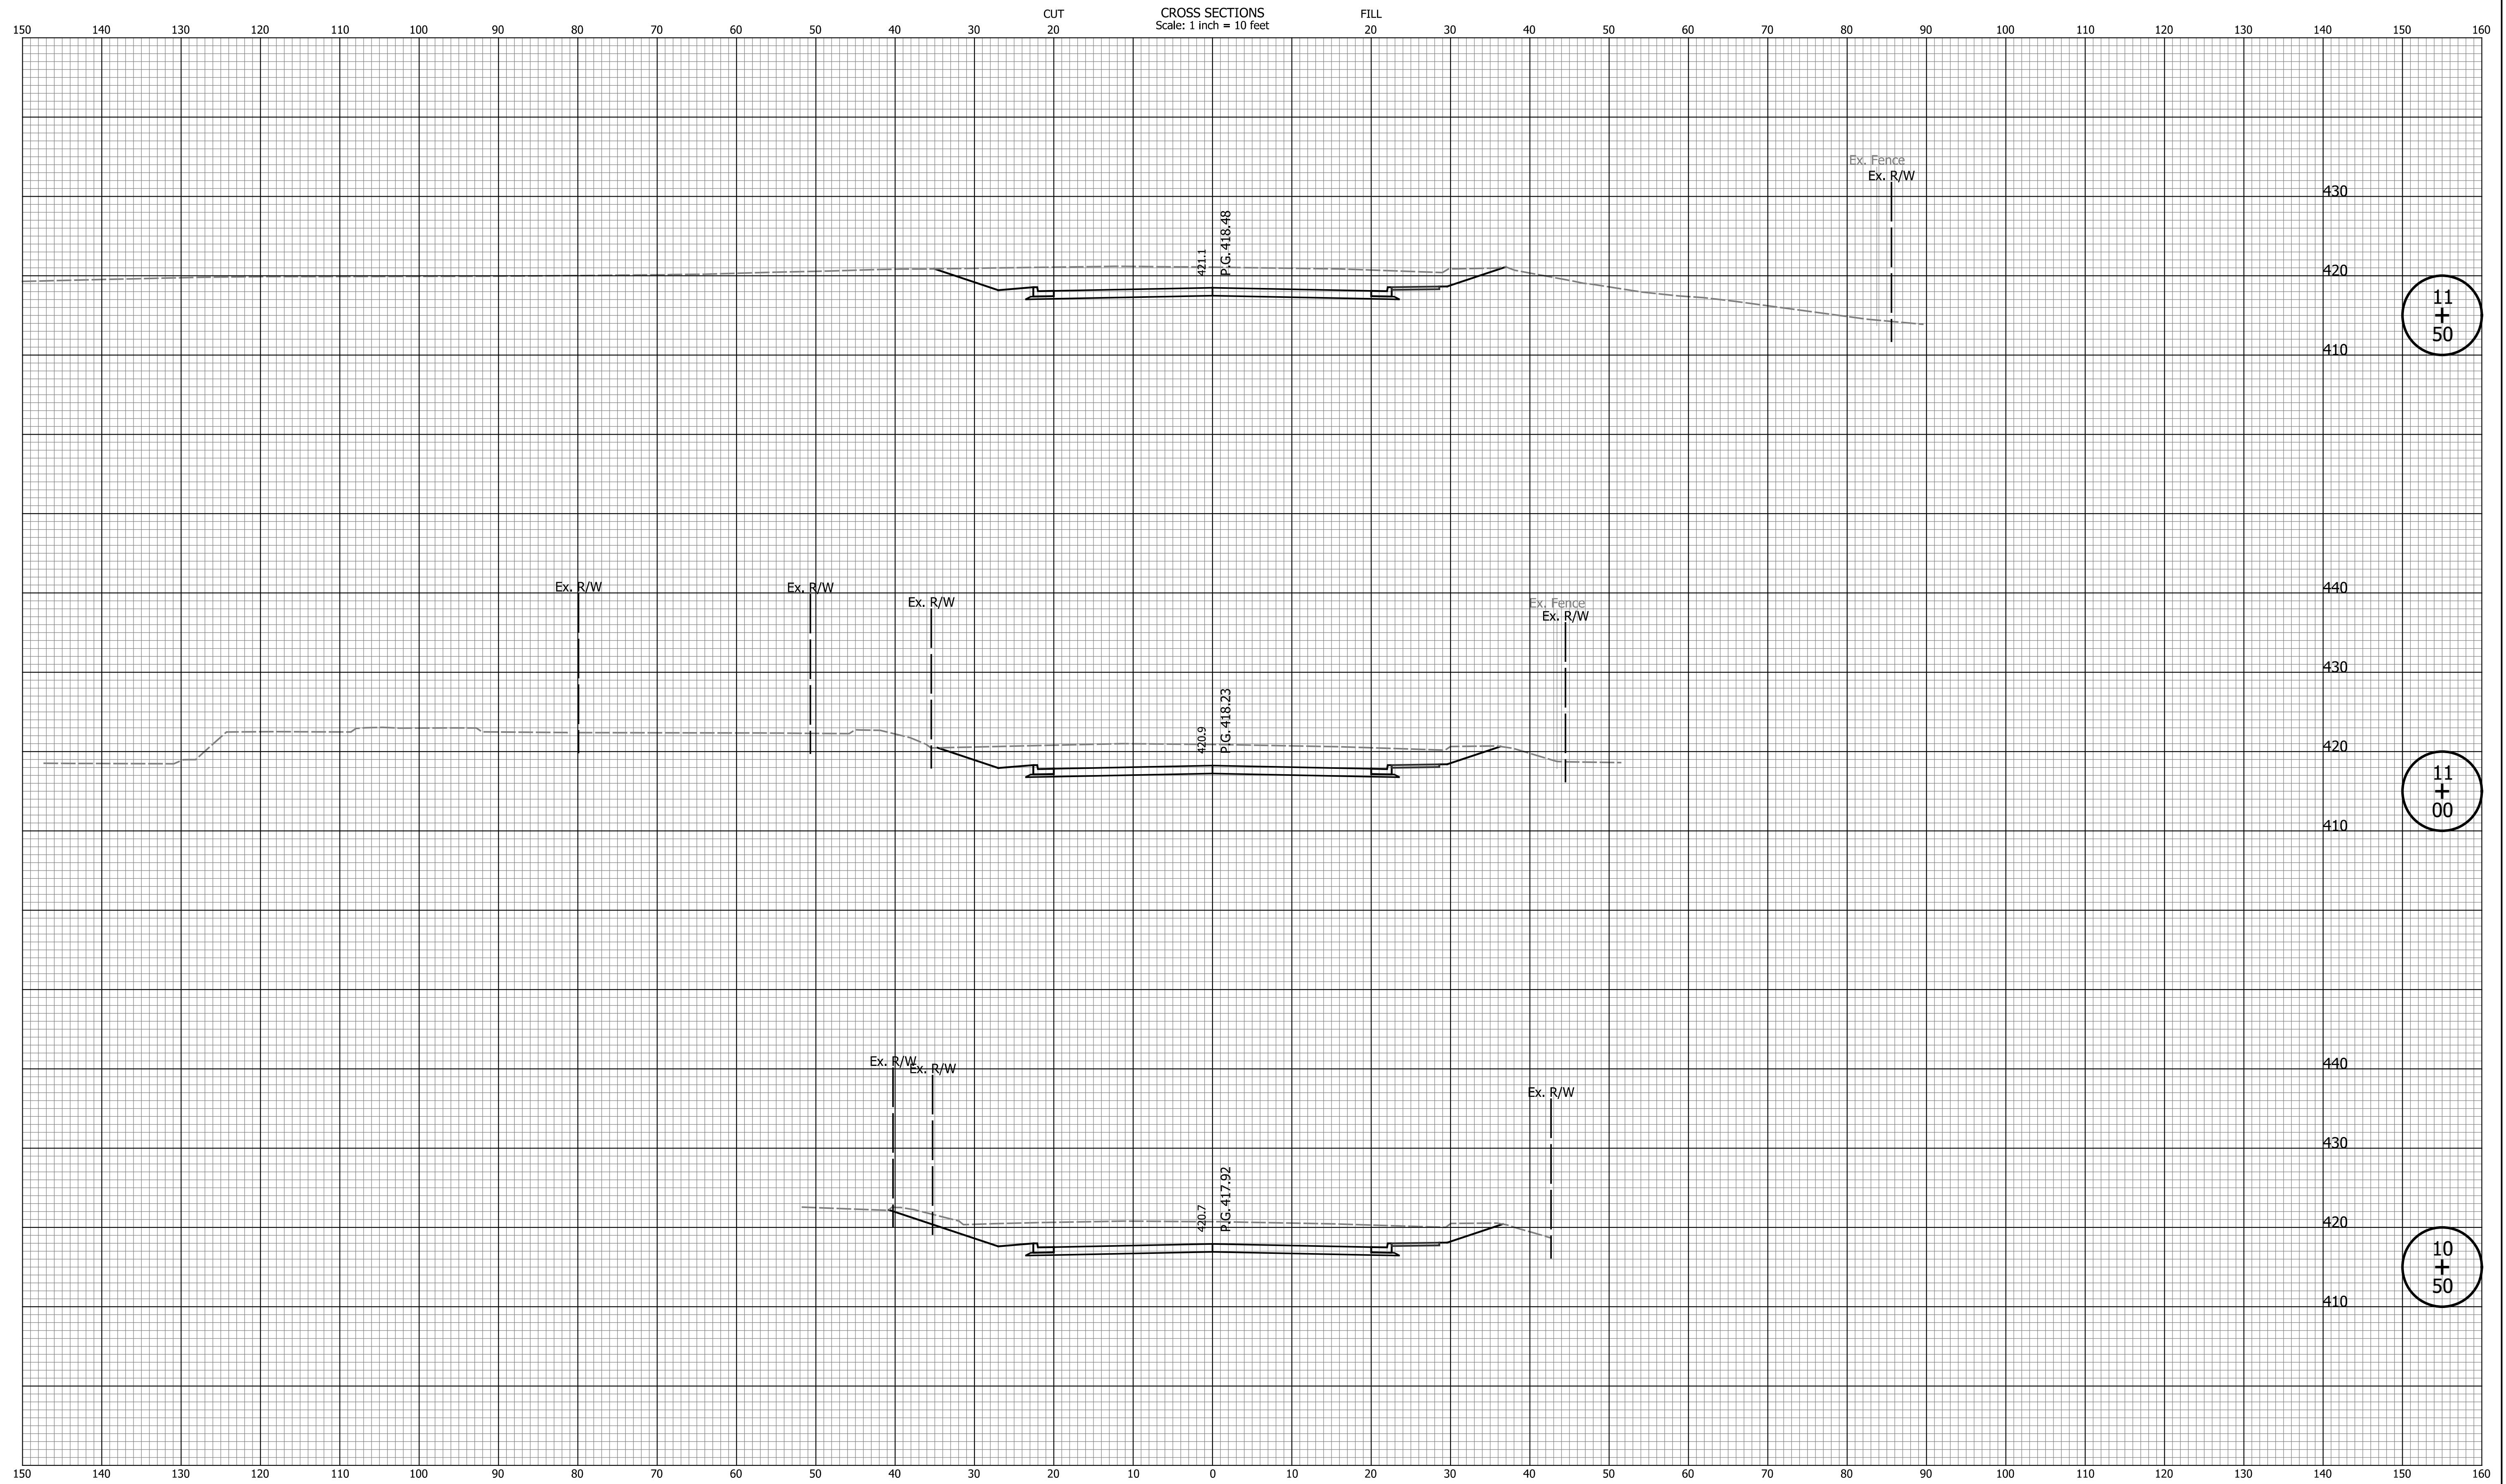

11
+
50

11
+
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10
+
50


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DESIGNED: JAB	DRAWN: EAK	
CHECKED: TMS	CHECKED: TMS	

INDIANA DEPARTMENT OF TRANSPORTATION

CROSS SECTIONS LINE "PR-A"

HORIZONTAL SCALE	BRIDGE FILE
1" = 10'	N/A
VERTICAL SCALE	DESIGNATION
1" = 10'	2002538
SURVEY BOOK	SHEETS
N/A	51 of 117
CONTRACT	PROJECT
R-43470	2002538

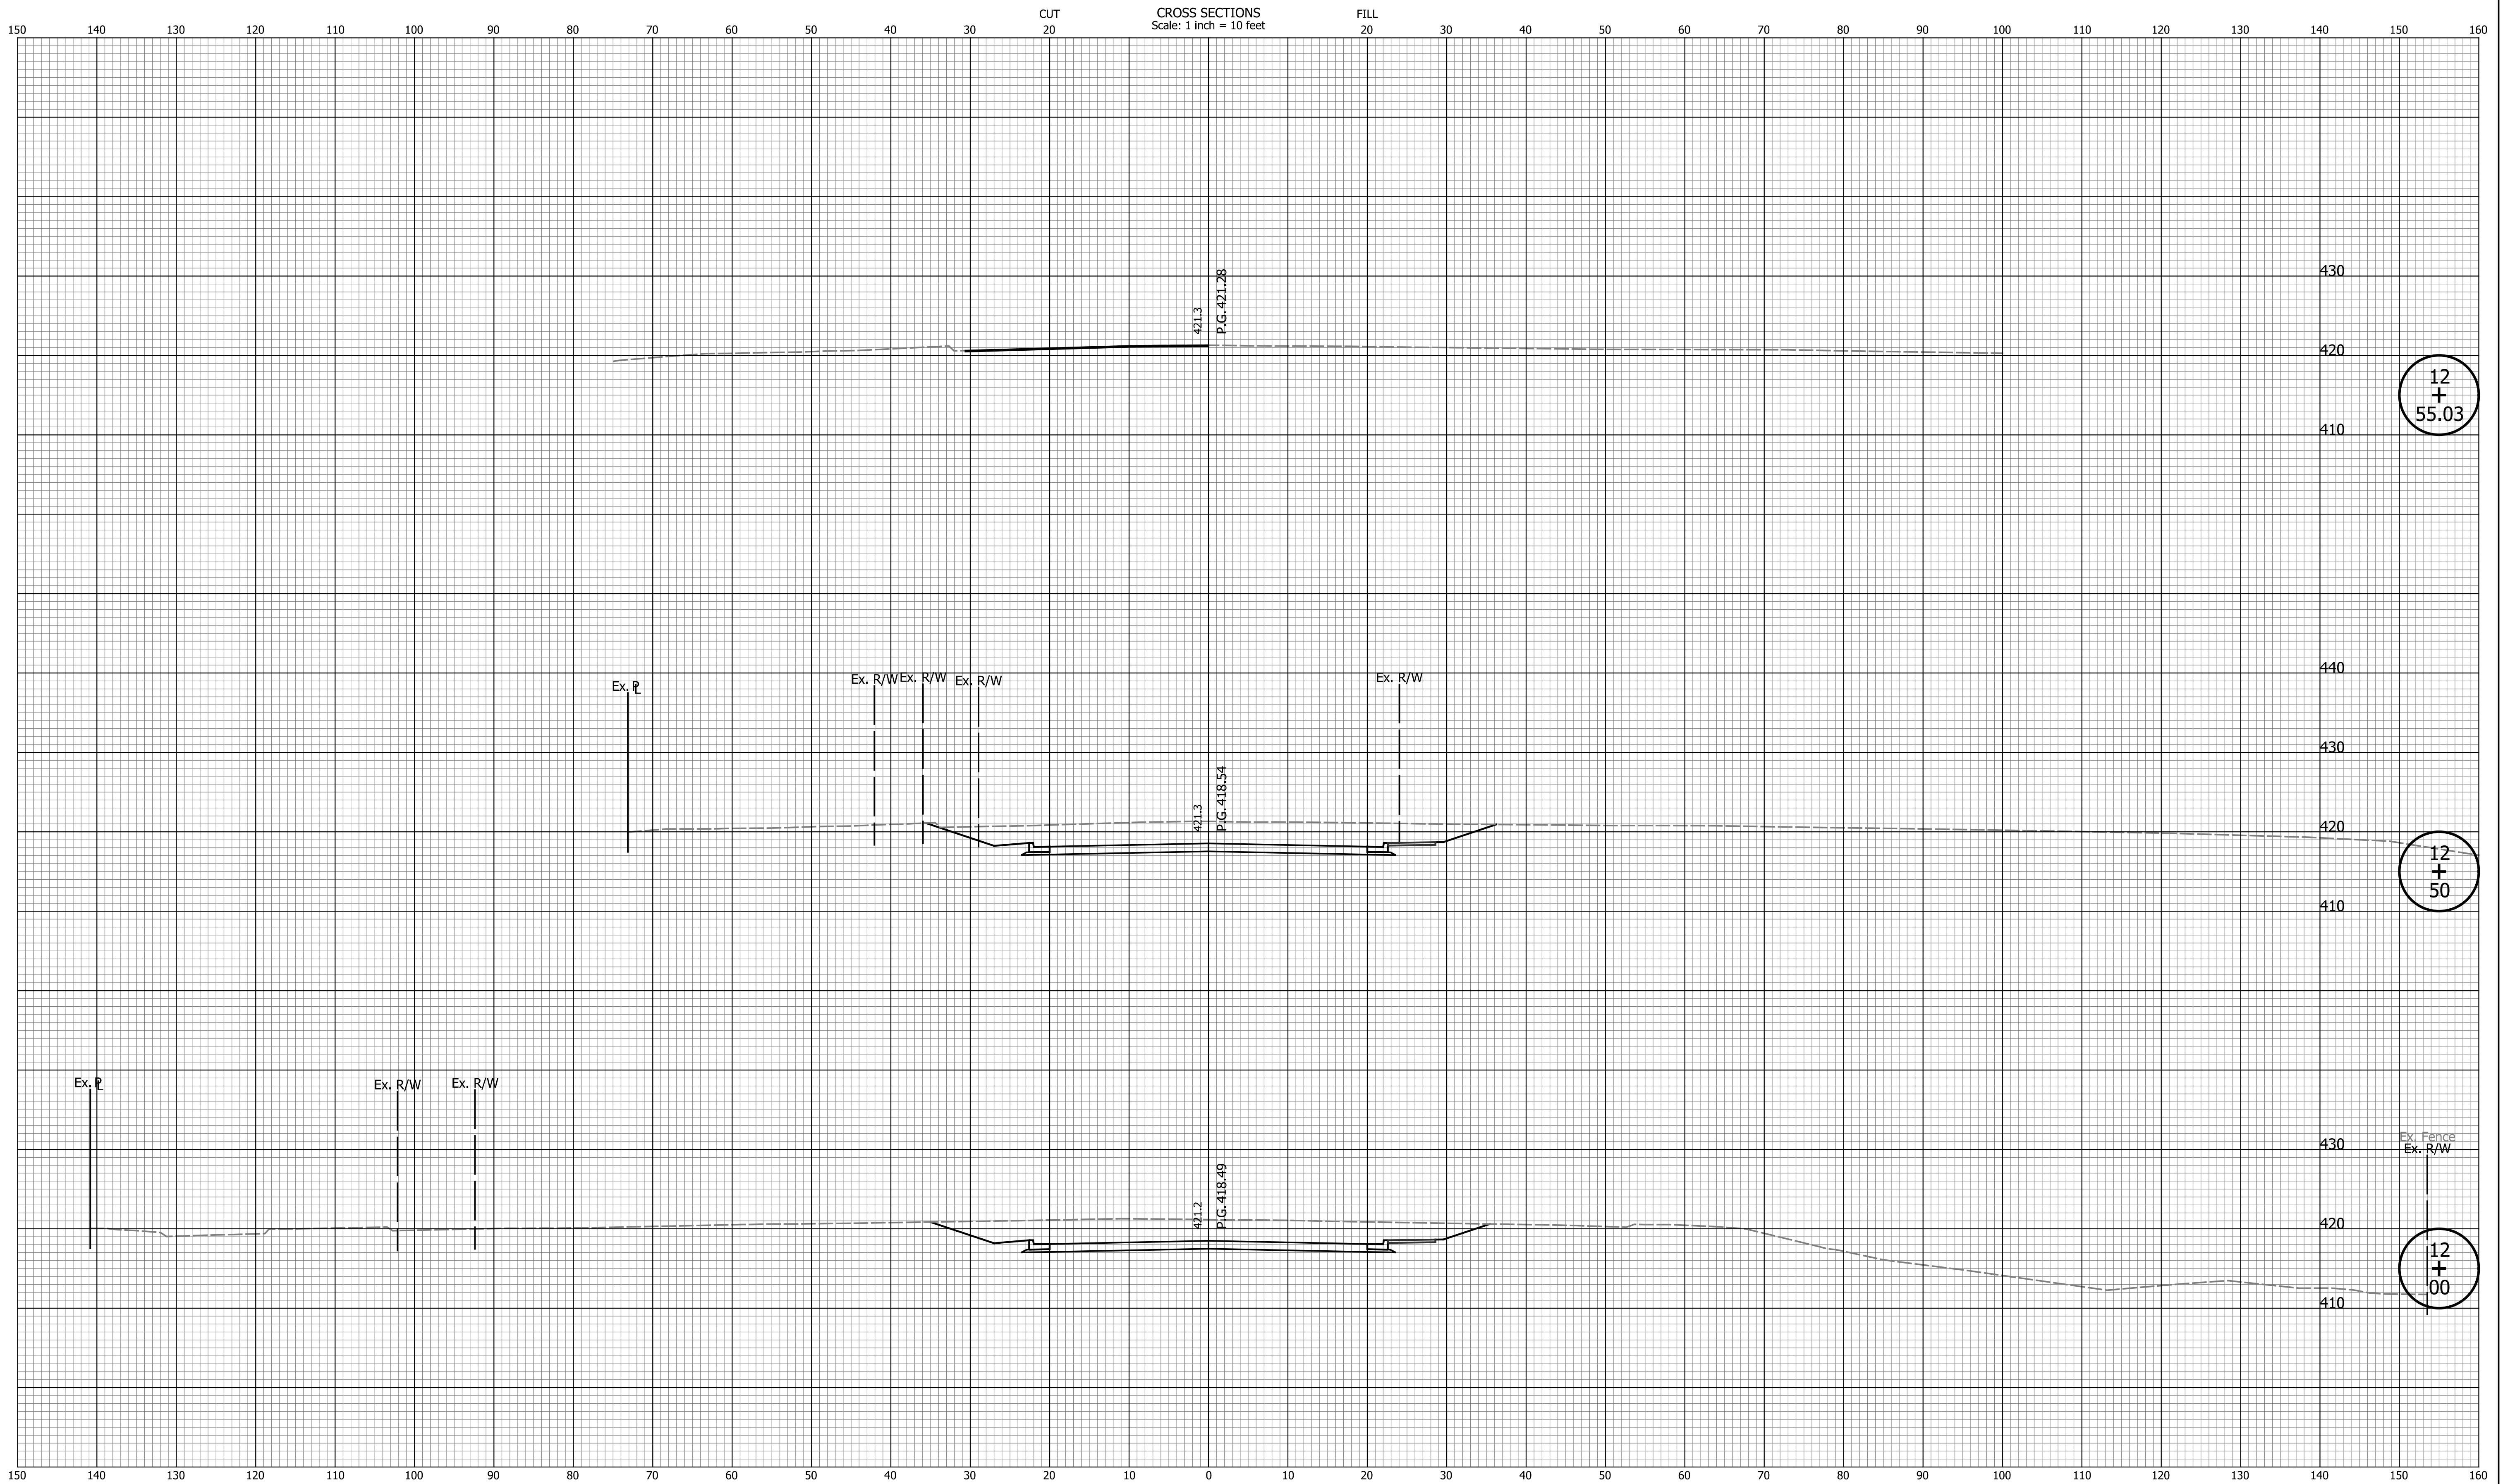

DATE	REVISION


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INDIANA DEPARTMENT OF TRANSPORTATION

CROSS SECTIONS LINE "PR-A"

HORIZONTAL SCALE	BRIDGE FILE
1" = 10'	N/A
VERTICAL SCALE	DESIGNATION
1" = 10'	2002538
SURVEY BOOK	SHEETS
N/A	52 of 117
CONTRACT	PROJECT
R-43470	2002538

Indiana State

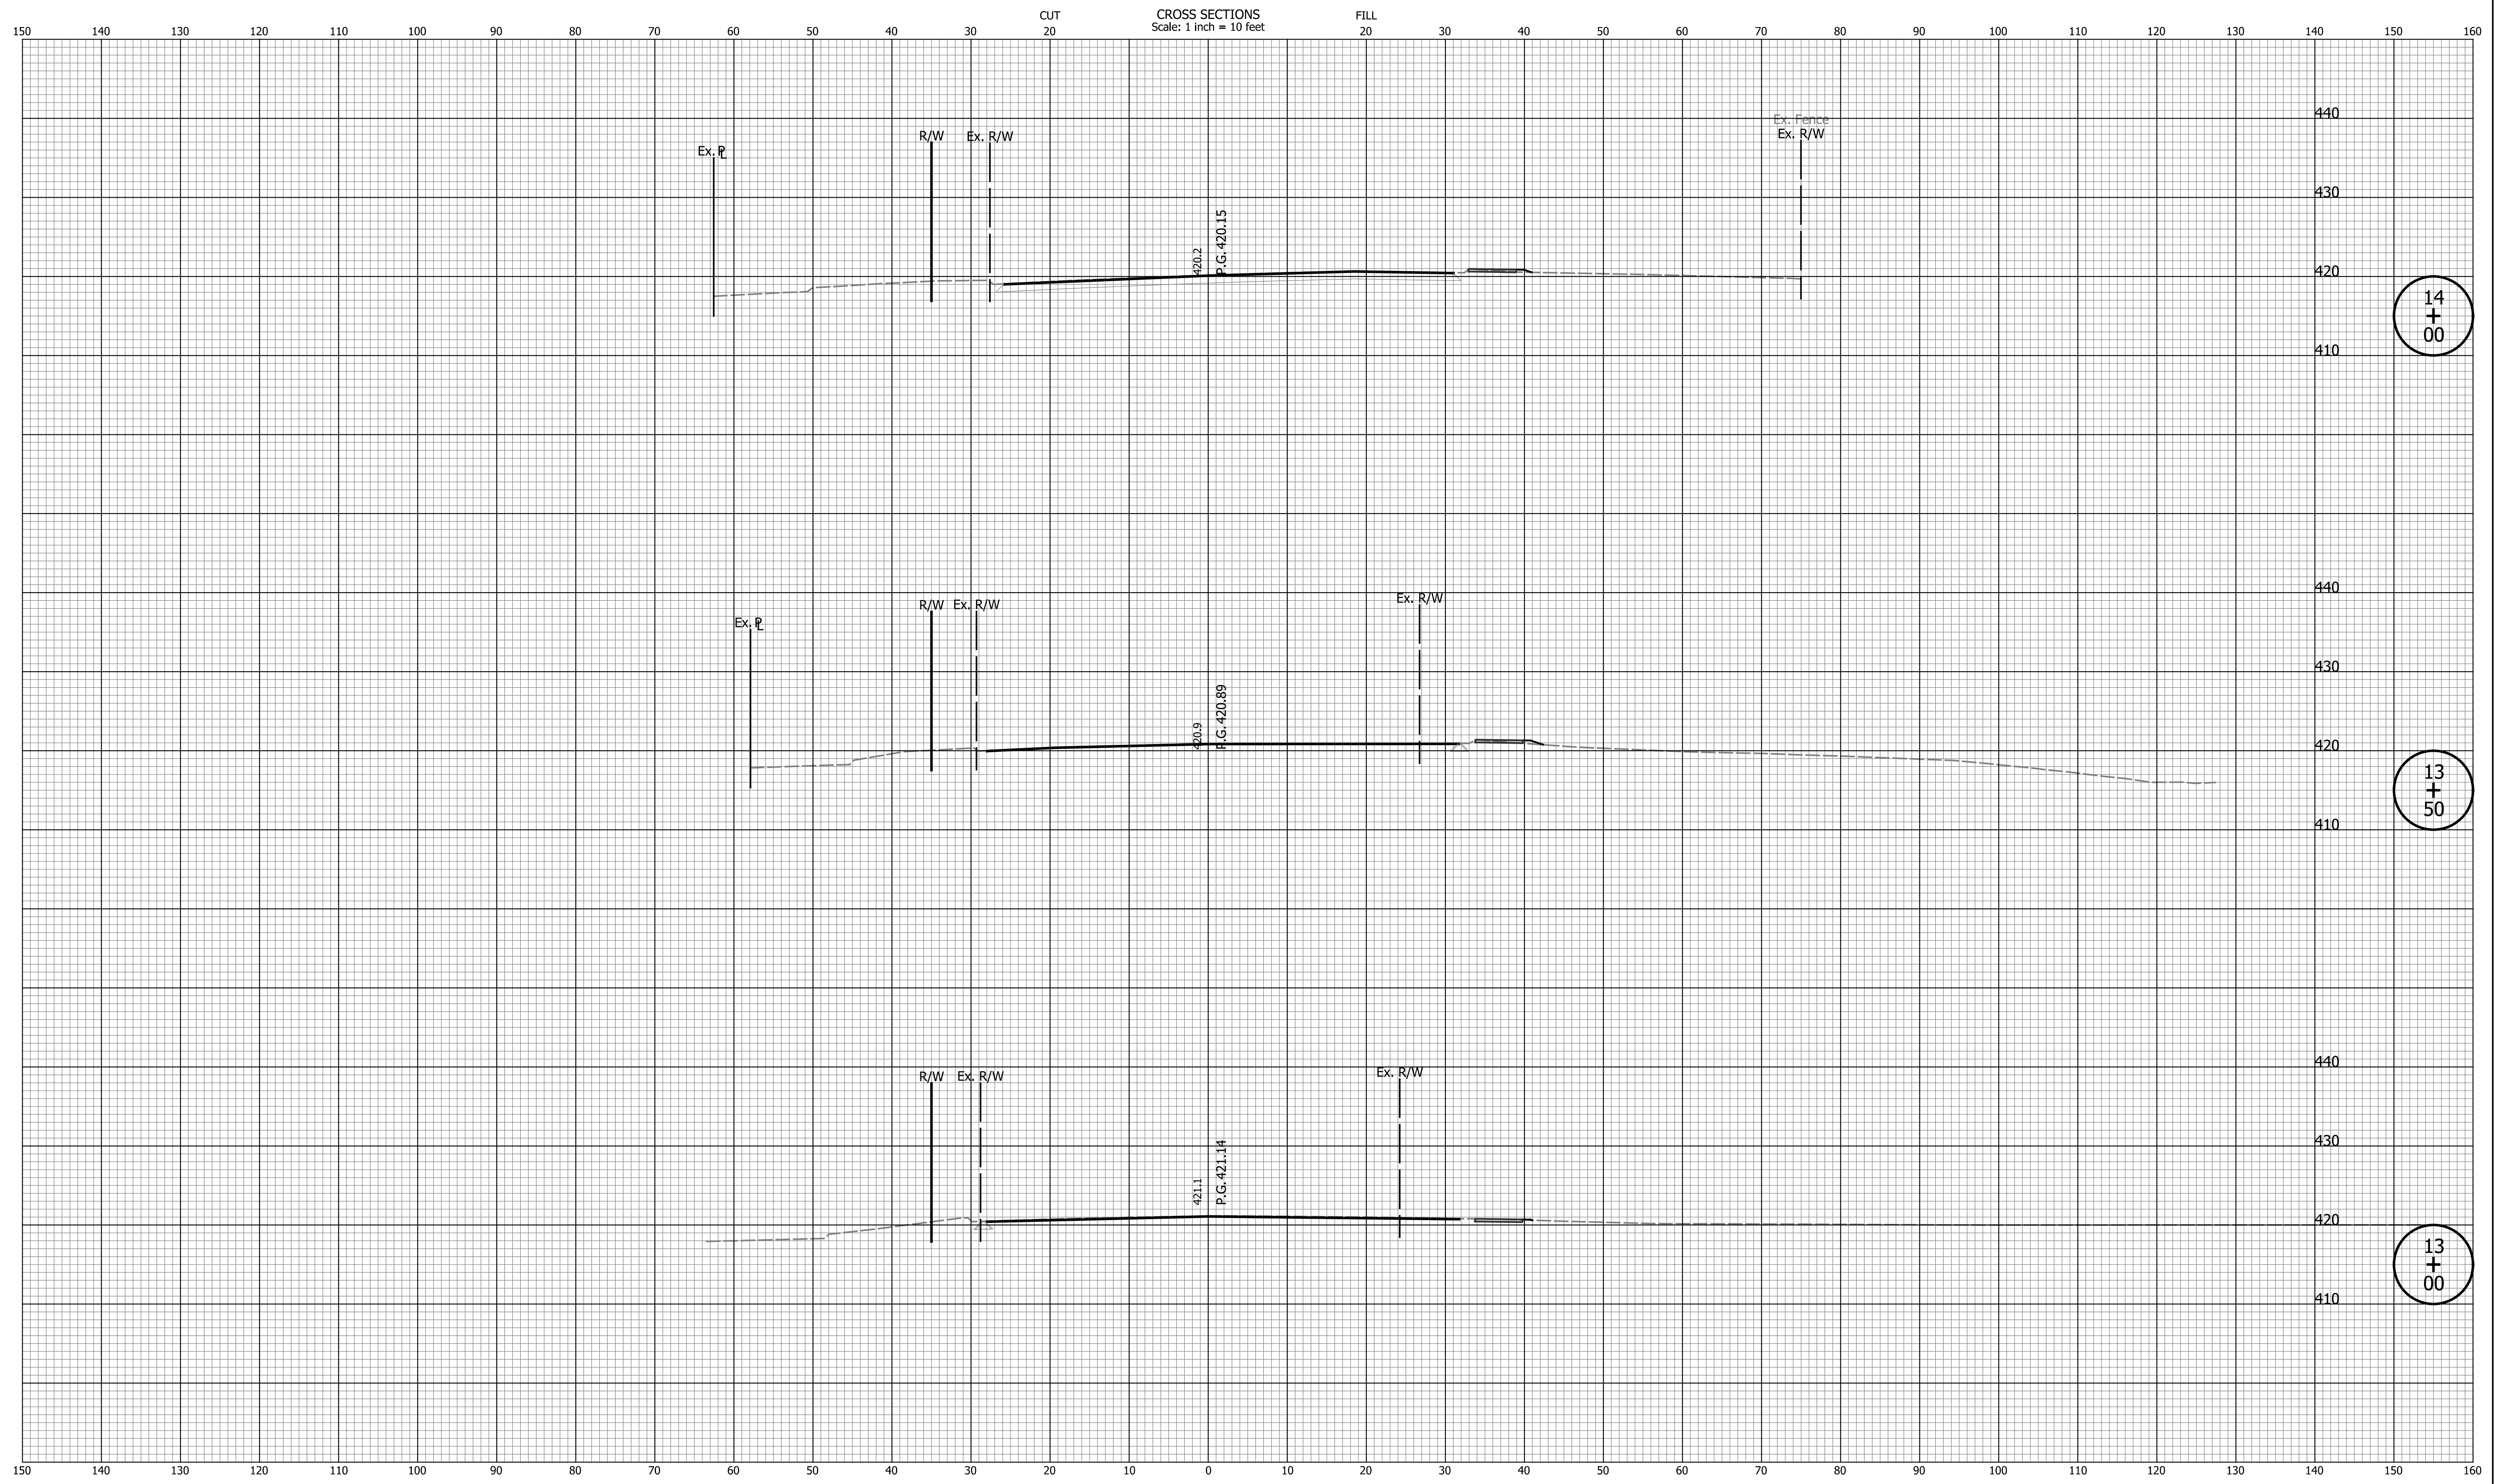


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INDIANA DEPARTMENT OF TRANSPORTATION

CROSS SECTIONS LINE "PR-A"

HORIZONTAL SCALE 1" = 10'	BRIDGE FILE N/A
VERTICAL SCALE 1" = 10'	DESIGNATION 2002538
SURVEY BOOK N/A	SHEETS 53 of 117
CONTRACT R-43470	PROJECT 2002538



16
+
54.86

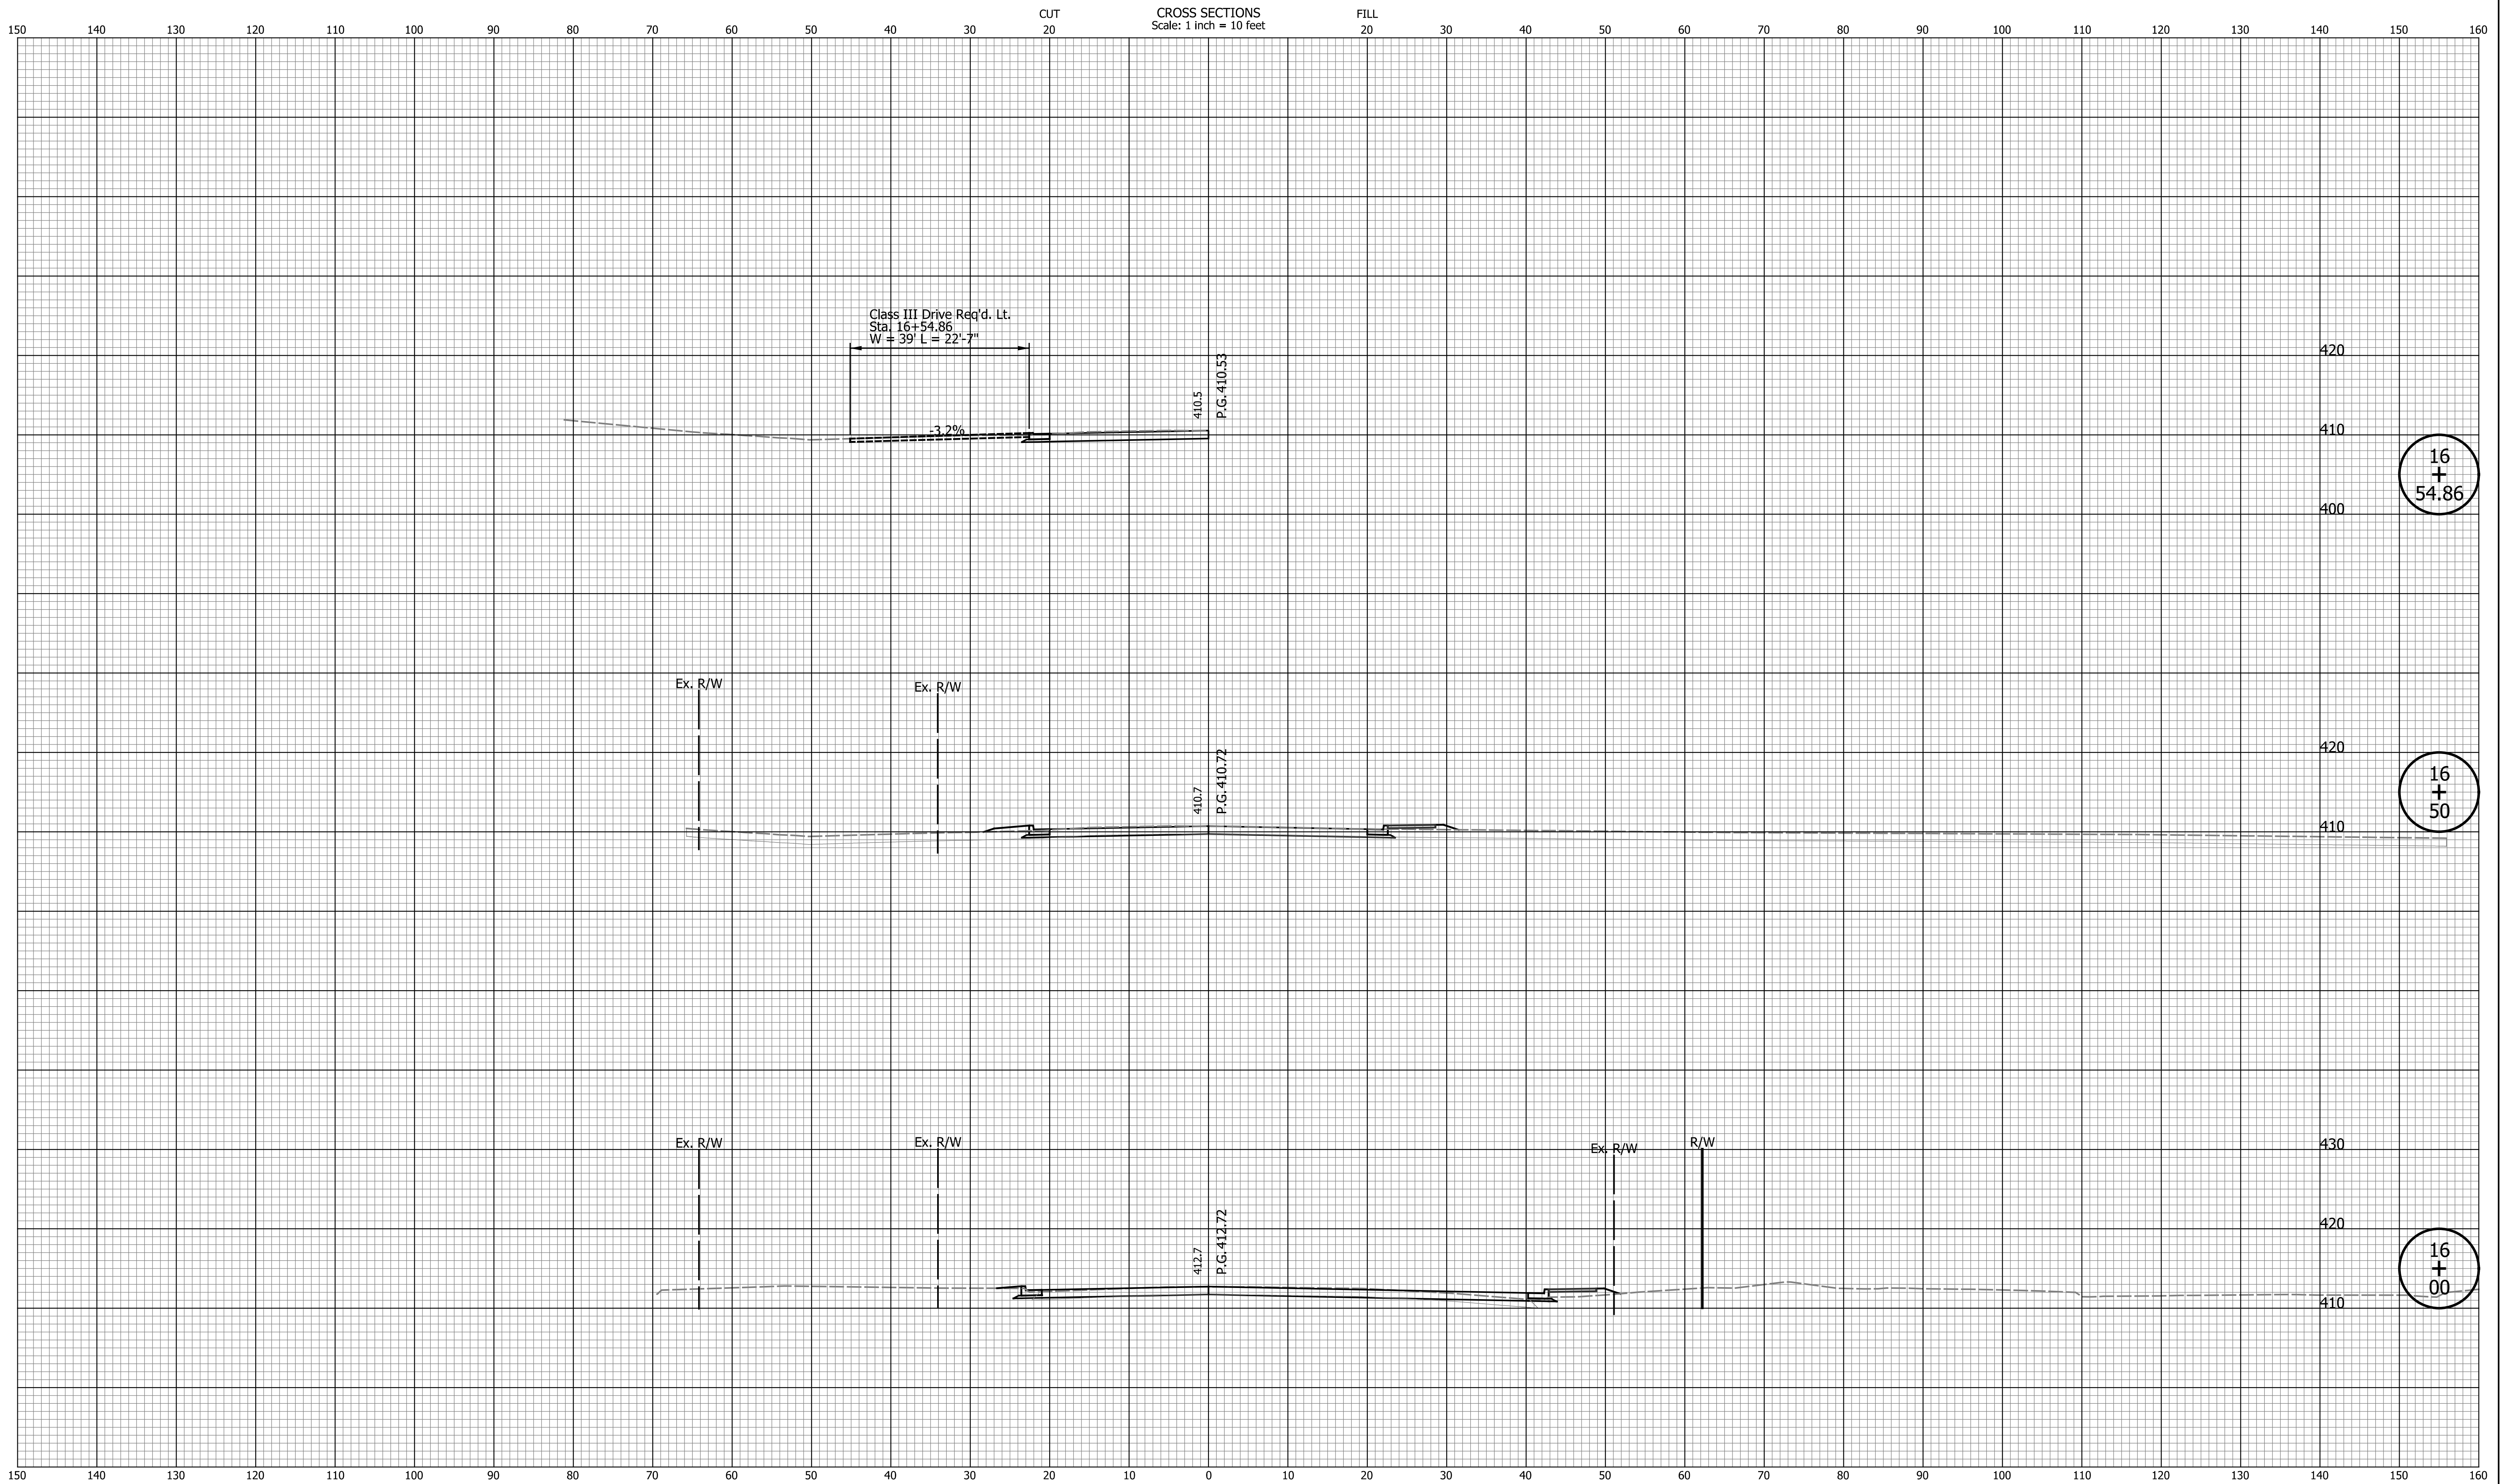16
+
50

16
+
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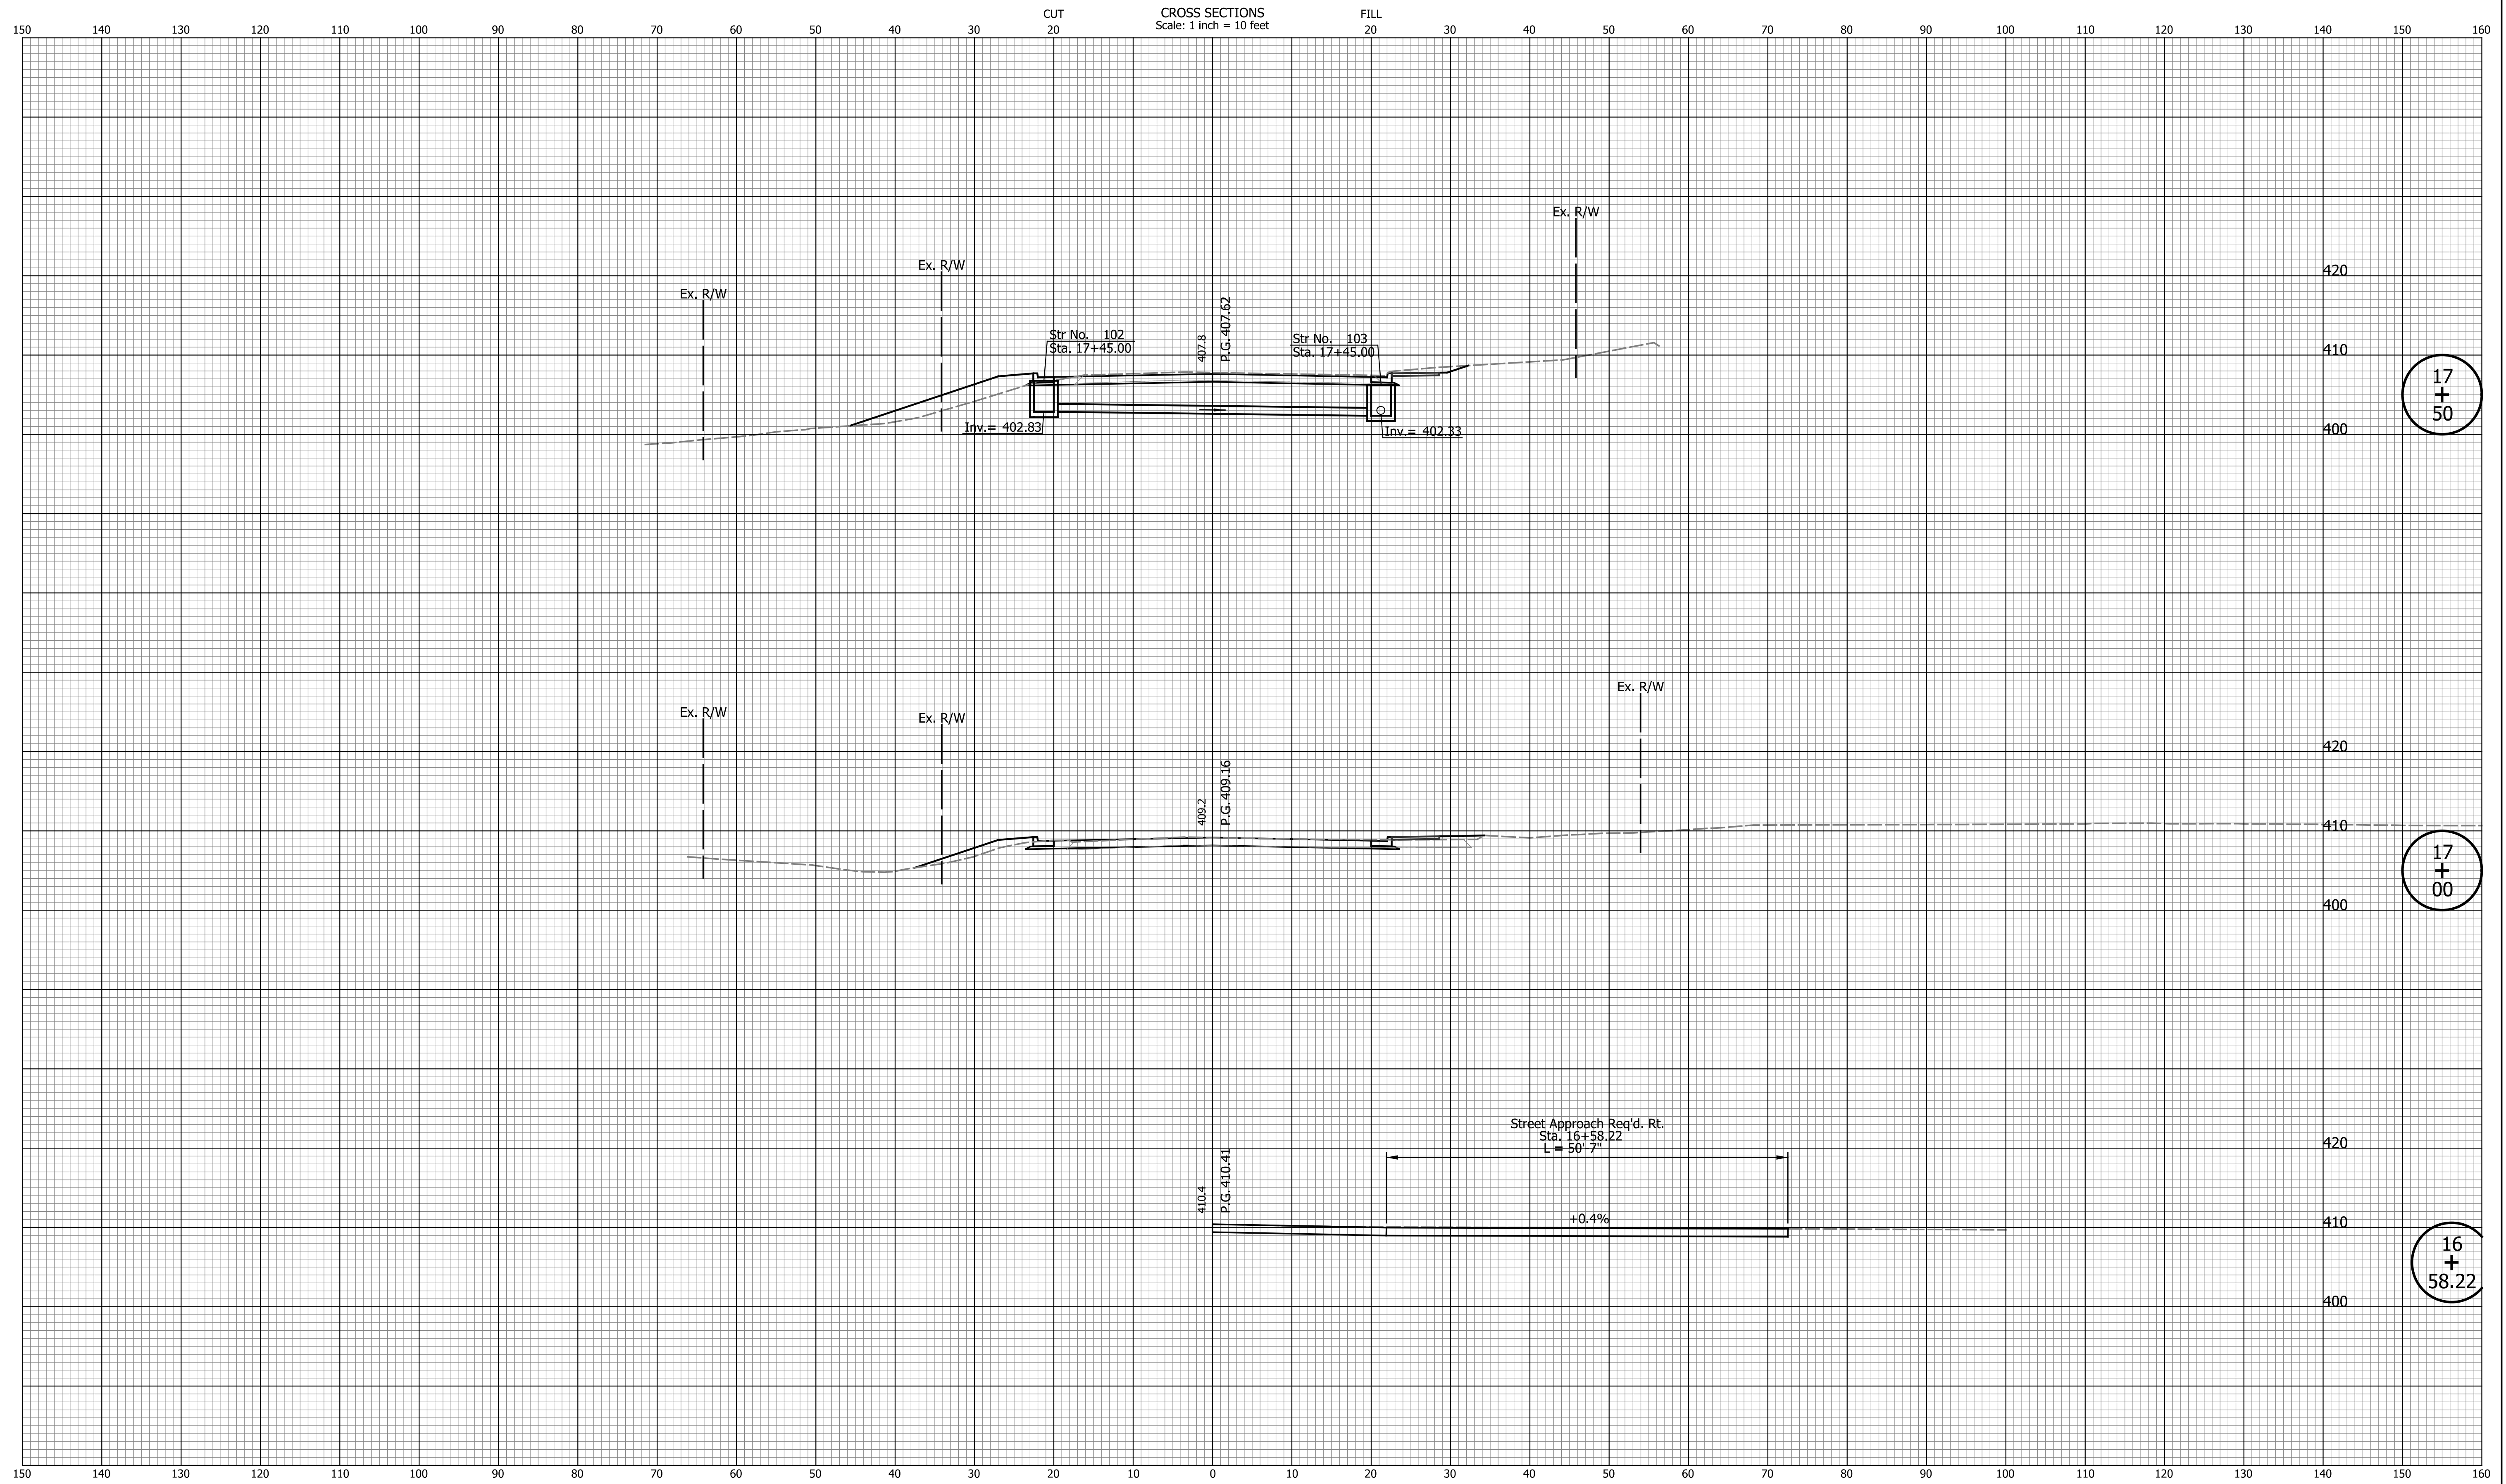
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INDIANA DEPARTMENT OF TRANSPORTATION

CROSS SECTIONS LINE "PR-A"

HORIZONTAL SCALE	BRIDGE FILE
1" = 10'	N/A
VERTICAL SCALE	DESIGNATION
1" = 10'	2002538
SURVEY BOOK	SHEETS
N/A	55 of 117
CONTRACT	PROJECT
R-43470	2002538



17
+
50

17
+
00

16
+
58.22


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INDIANA DEPARTMENT OF TRANSPORTATION

CROSS SECTIONS LINE "PR-A"

HORIZONTAL SCALE	BRIDGE FILE
1" = 10'	N/A
VERTICAL SCALE	DESIGNATION
1" = 10'	2002538
SURVEY BOOK	SHEETS
N/A	56 of 117
CONTRACT	PROJECT
R-43470	2002538



19
+
25.99

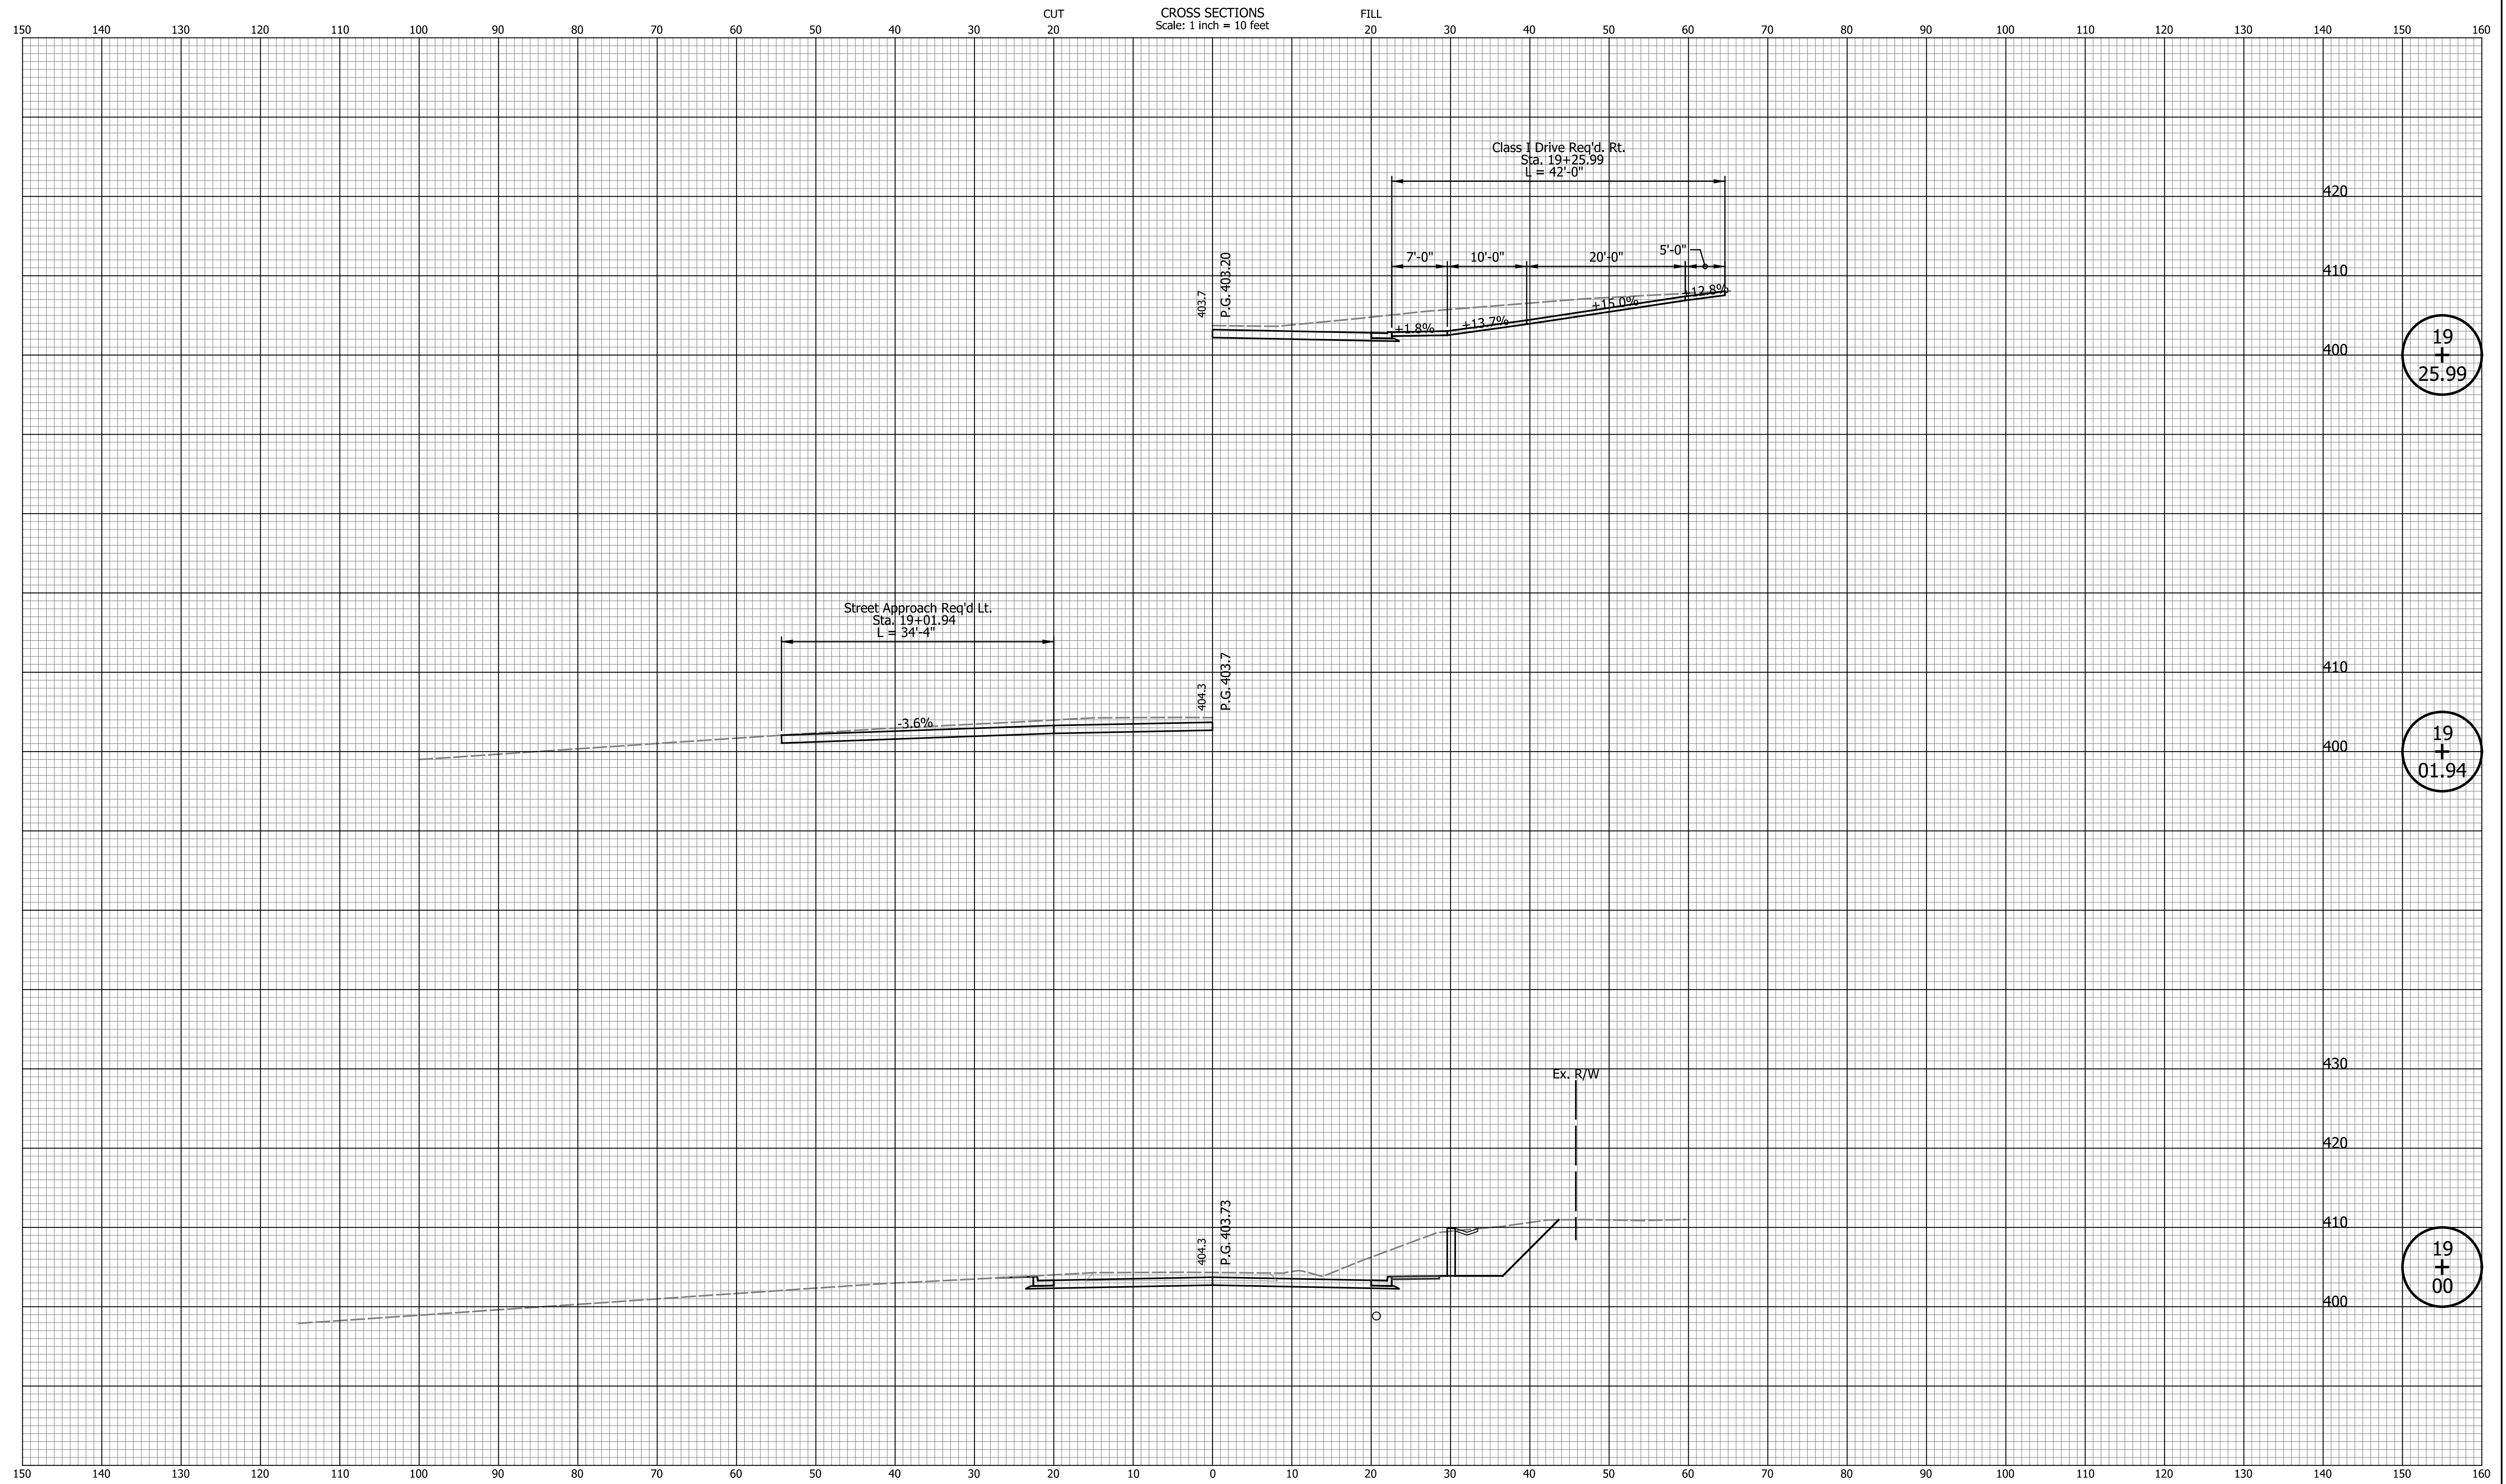19
+
01.94

19
+
00

DATE	REVISION


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INDIANA DEPARTMENT OF TRANSPORTATION

CROSS SECTIONS LINE "PR-A"

HORIZONTAL SCALE	BRIDGE FILE
1" = 10'	N/A
VERTICAL SCALE	DESIGNATION
1" = 10'	2002538
SURVEY BOOK	SHEETS
N/A	58 of 117
CONTRACT	PROJECT
R-43470	2002538

Indiana State

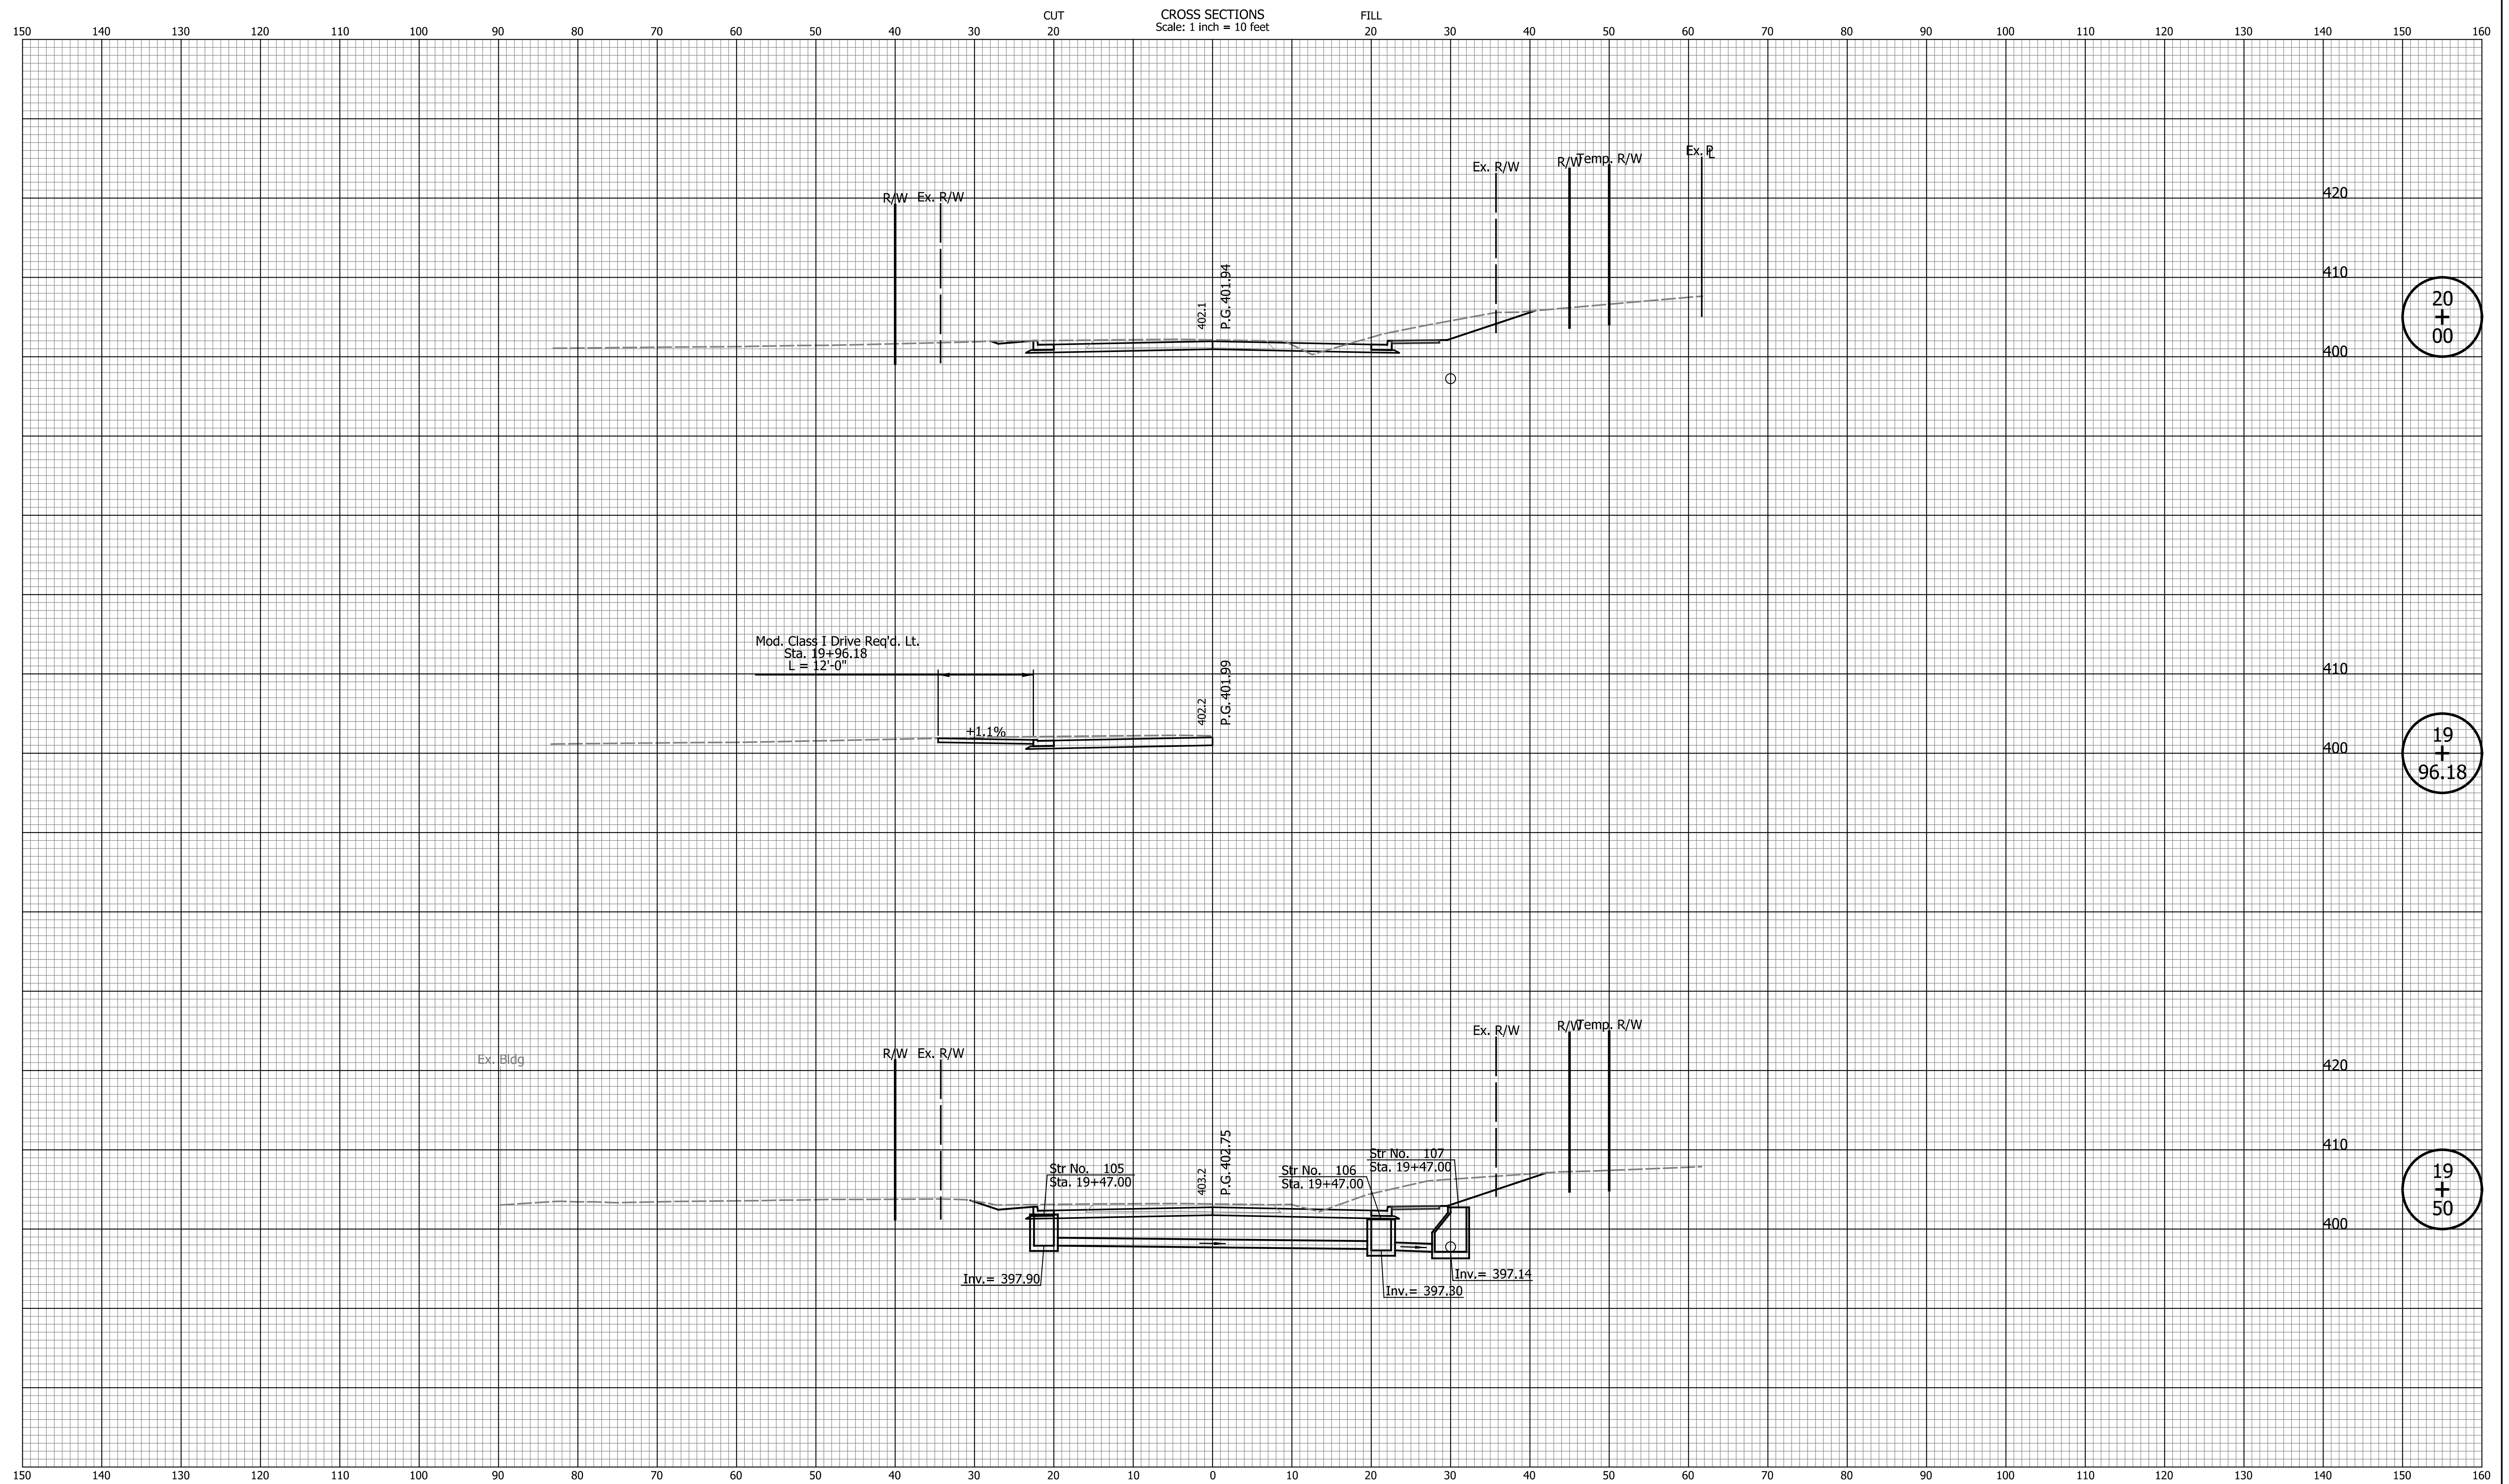

20
+
00

19
+
96.18

19
+
50


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DESIGNED: JAB	DRAWN: EAK	
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INDIANA DEPARTMENT OF TRANSPORTATION

CROSS SECTIONS LINE "PR-A"

HORIZONTAL SCALE	BRIDGE FILE
1" = 10'	N/A
VERTICAL SCALE	DESIGNATION
1" = 10'	2002538
SURVEY BOOK	SHEETS
N/A	59 of 117
CONTRACT	PROJECT
R-43470	2002538



DATE	REVISION
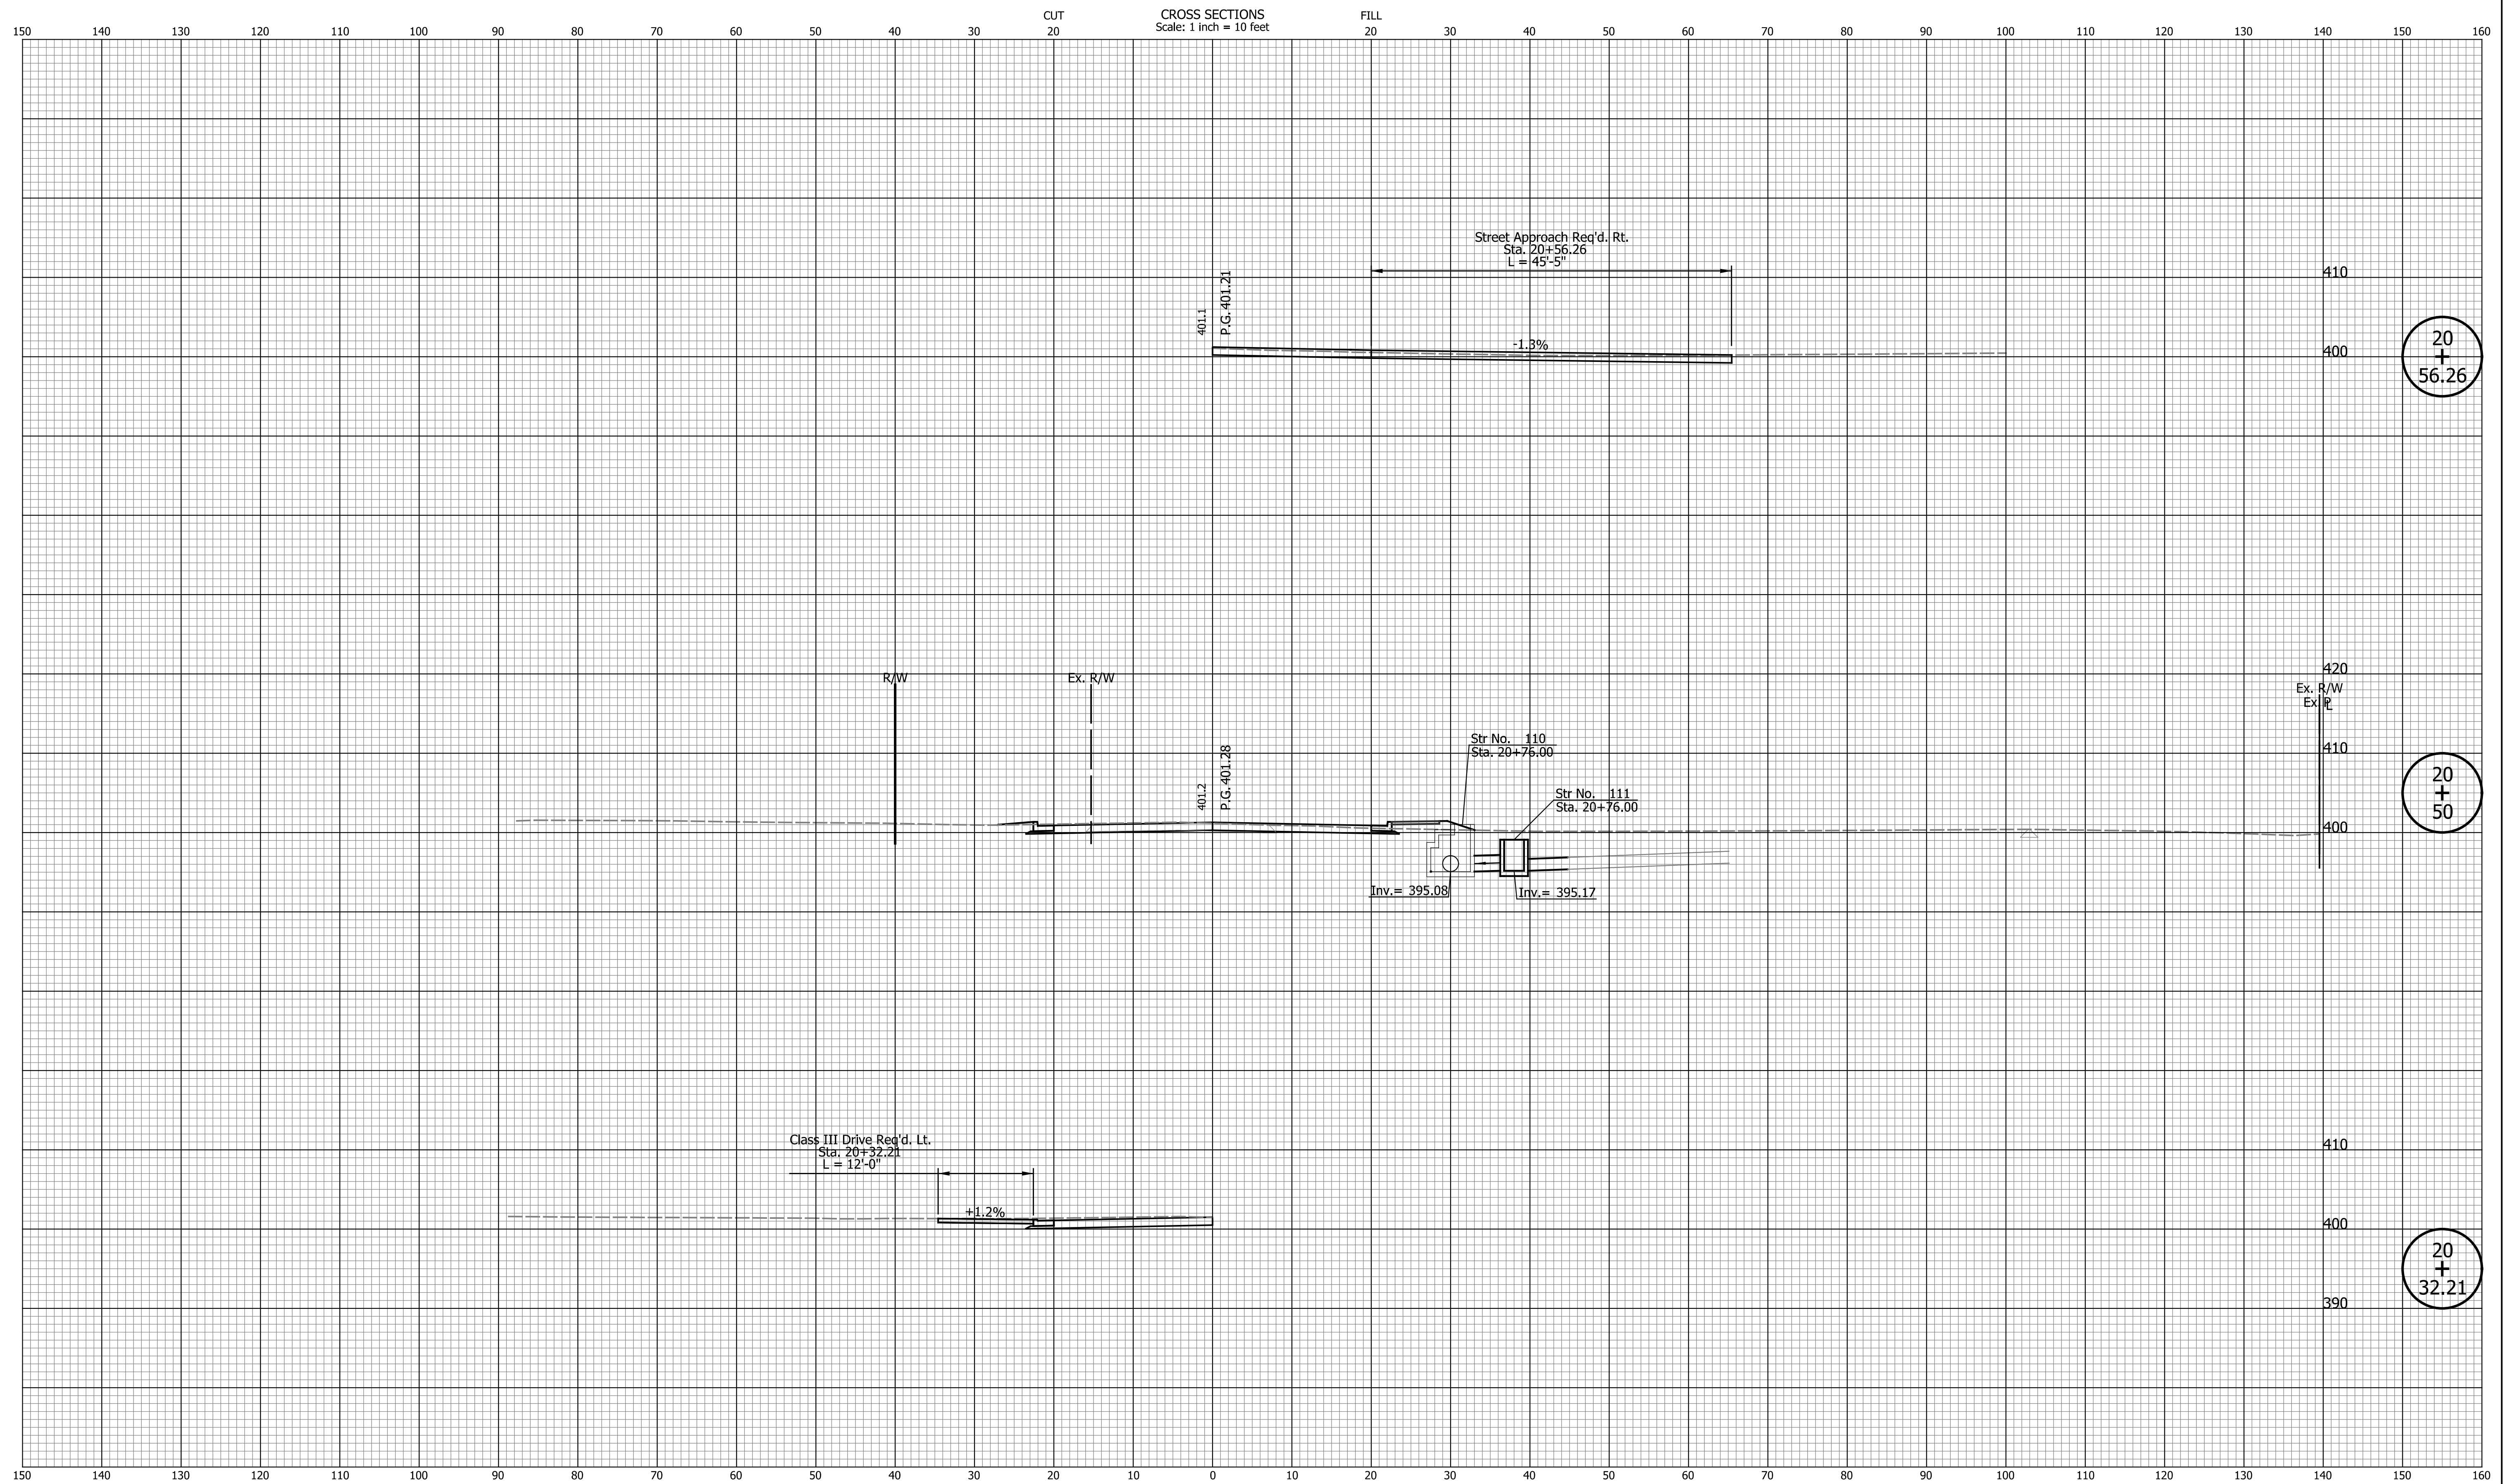
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DESIGN ENGINEER DATE _____

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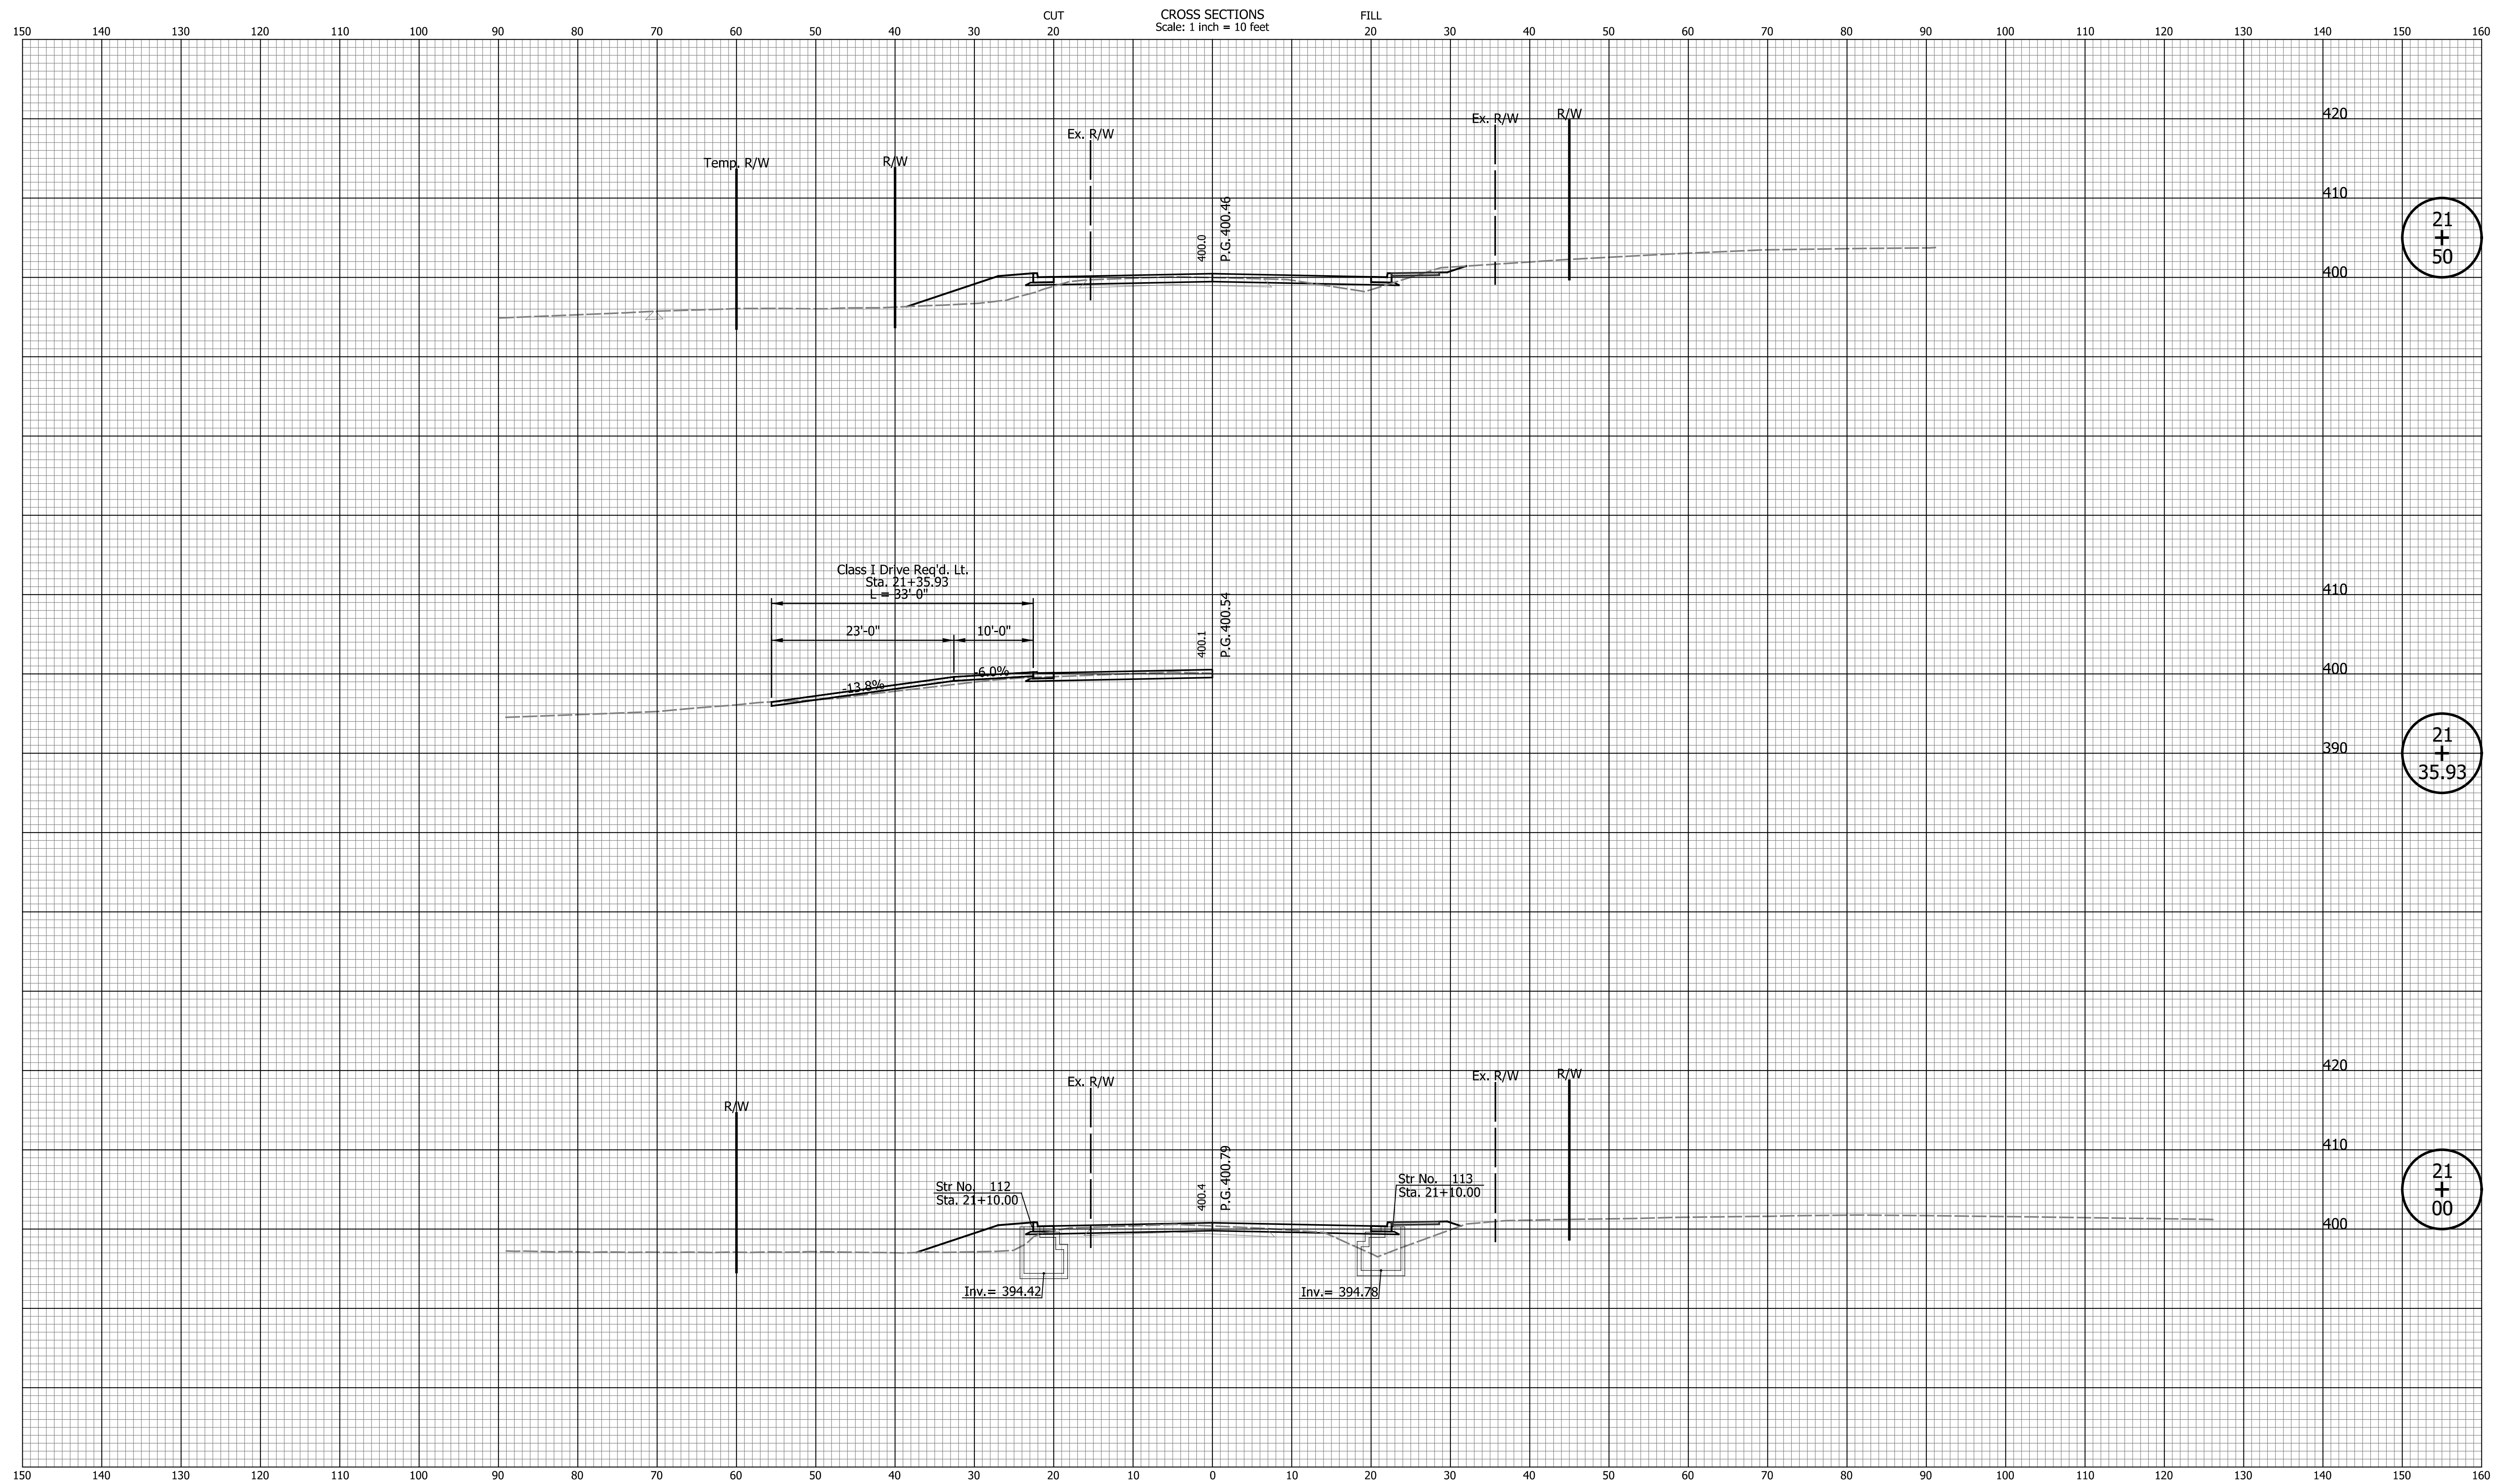
INDIANA DEPARTMENT OF TRANSPORTATION

CROSS SECTIONS LINE "PR-A"

HORIZONTAL SCALE 1" = 10'	BRIDGE FILE N/A
VERTICAL SCALE 1" = 10'	DESIGNATION 2002538
SURVEY BOOK N/A	SHEETS 60 of 117
CONTRACT R-43470	PROJECT 2002538

DATE	

Indiana State



DATE	REVISION


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INDIANA DEPARTMENT OF TRANSPORTATION

CROSS SECTIONS LINE "PR-A"

HORIZONTAL SCALE	BRIDGE FILE
1" = 10'	N/A
VERTICAL SCALE	DESIGNATION
1" = 10'	2002538
SURVEY BOOK	SHEETS
N/A	61 of 117
CONTRACT	PROJECT
R-43470	2002538

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DATE	REVISION


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INDIANA DEPARTMENT OF TRANSPORTATION

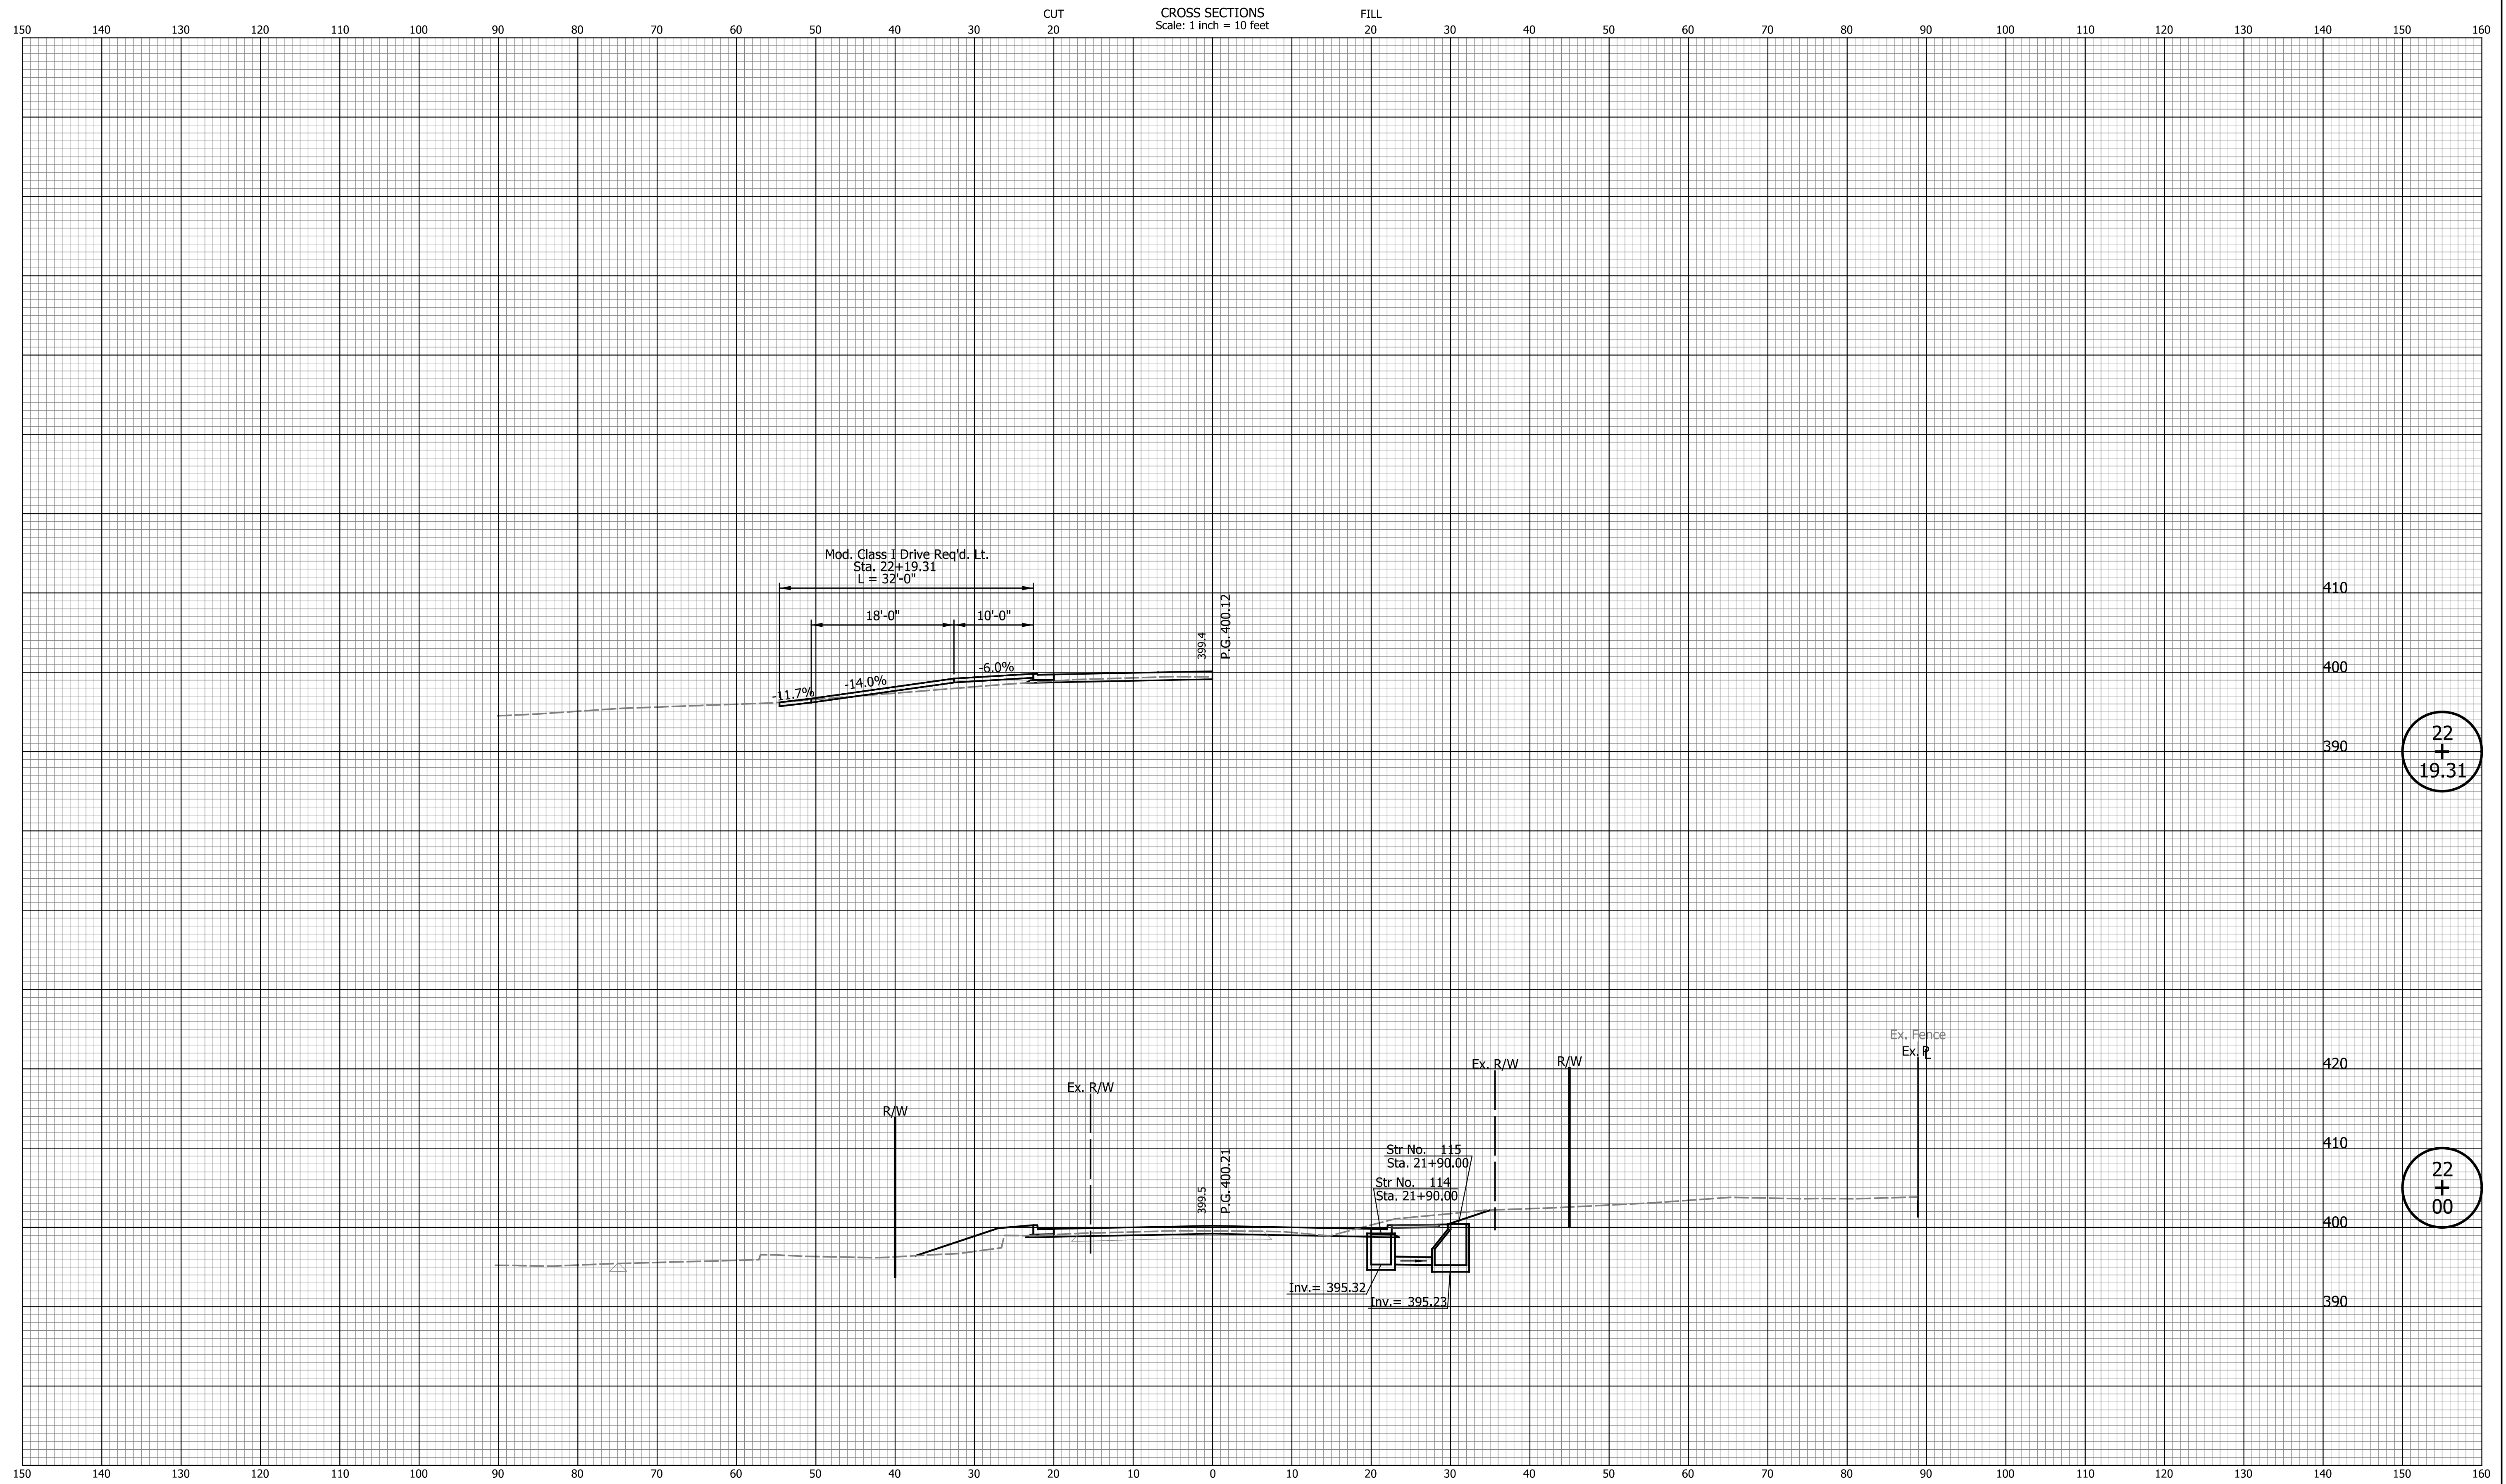CROSS SECTIONS LINE "PR-A"

HORIZONTAL SCALE	BRIDGE FILE
1" = 10'	N/A
VERTICAL SCALE	DESIGNATION
1" = 10'	2002538
SURVEY BOOK	SHEETS
N/A	62 of 117
CONTRACT	PROJECT
R-43470	2002538

Indiana State Dept. of Transportation

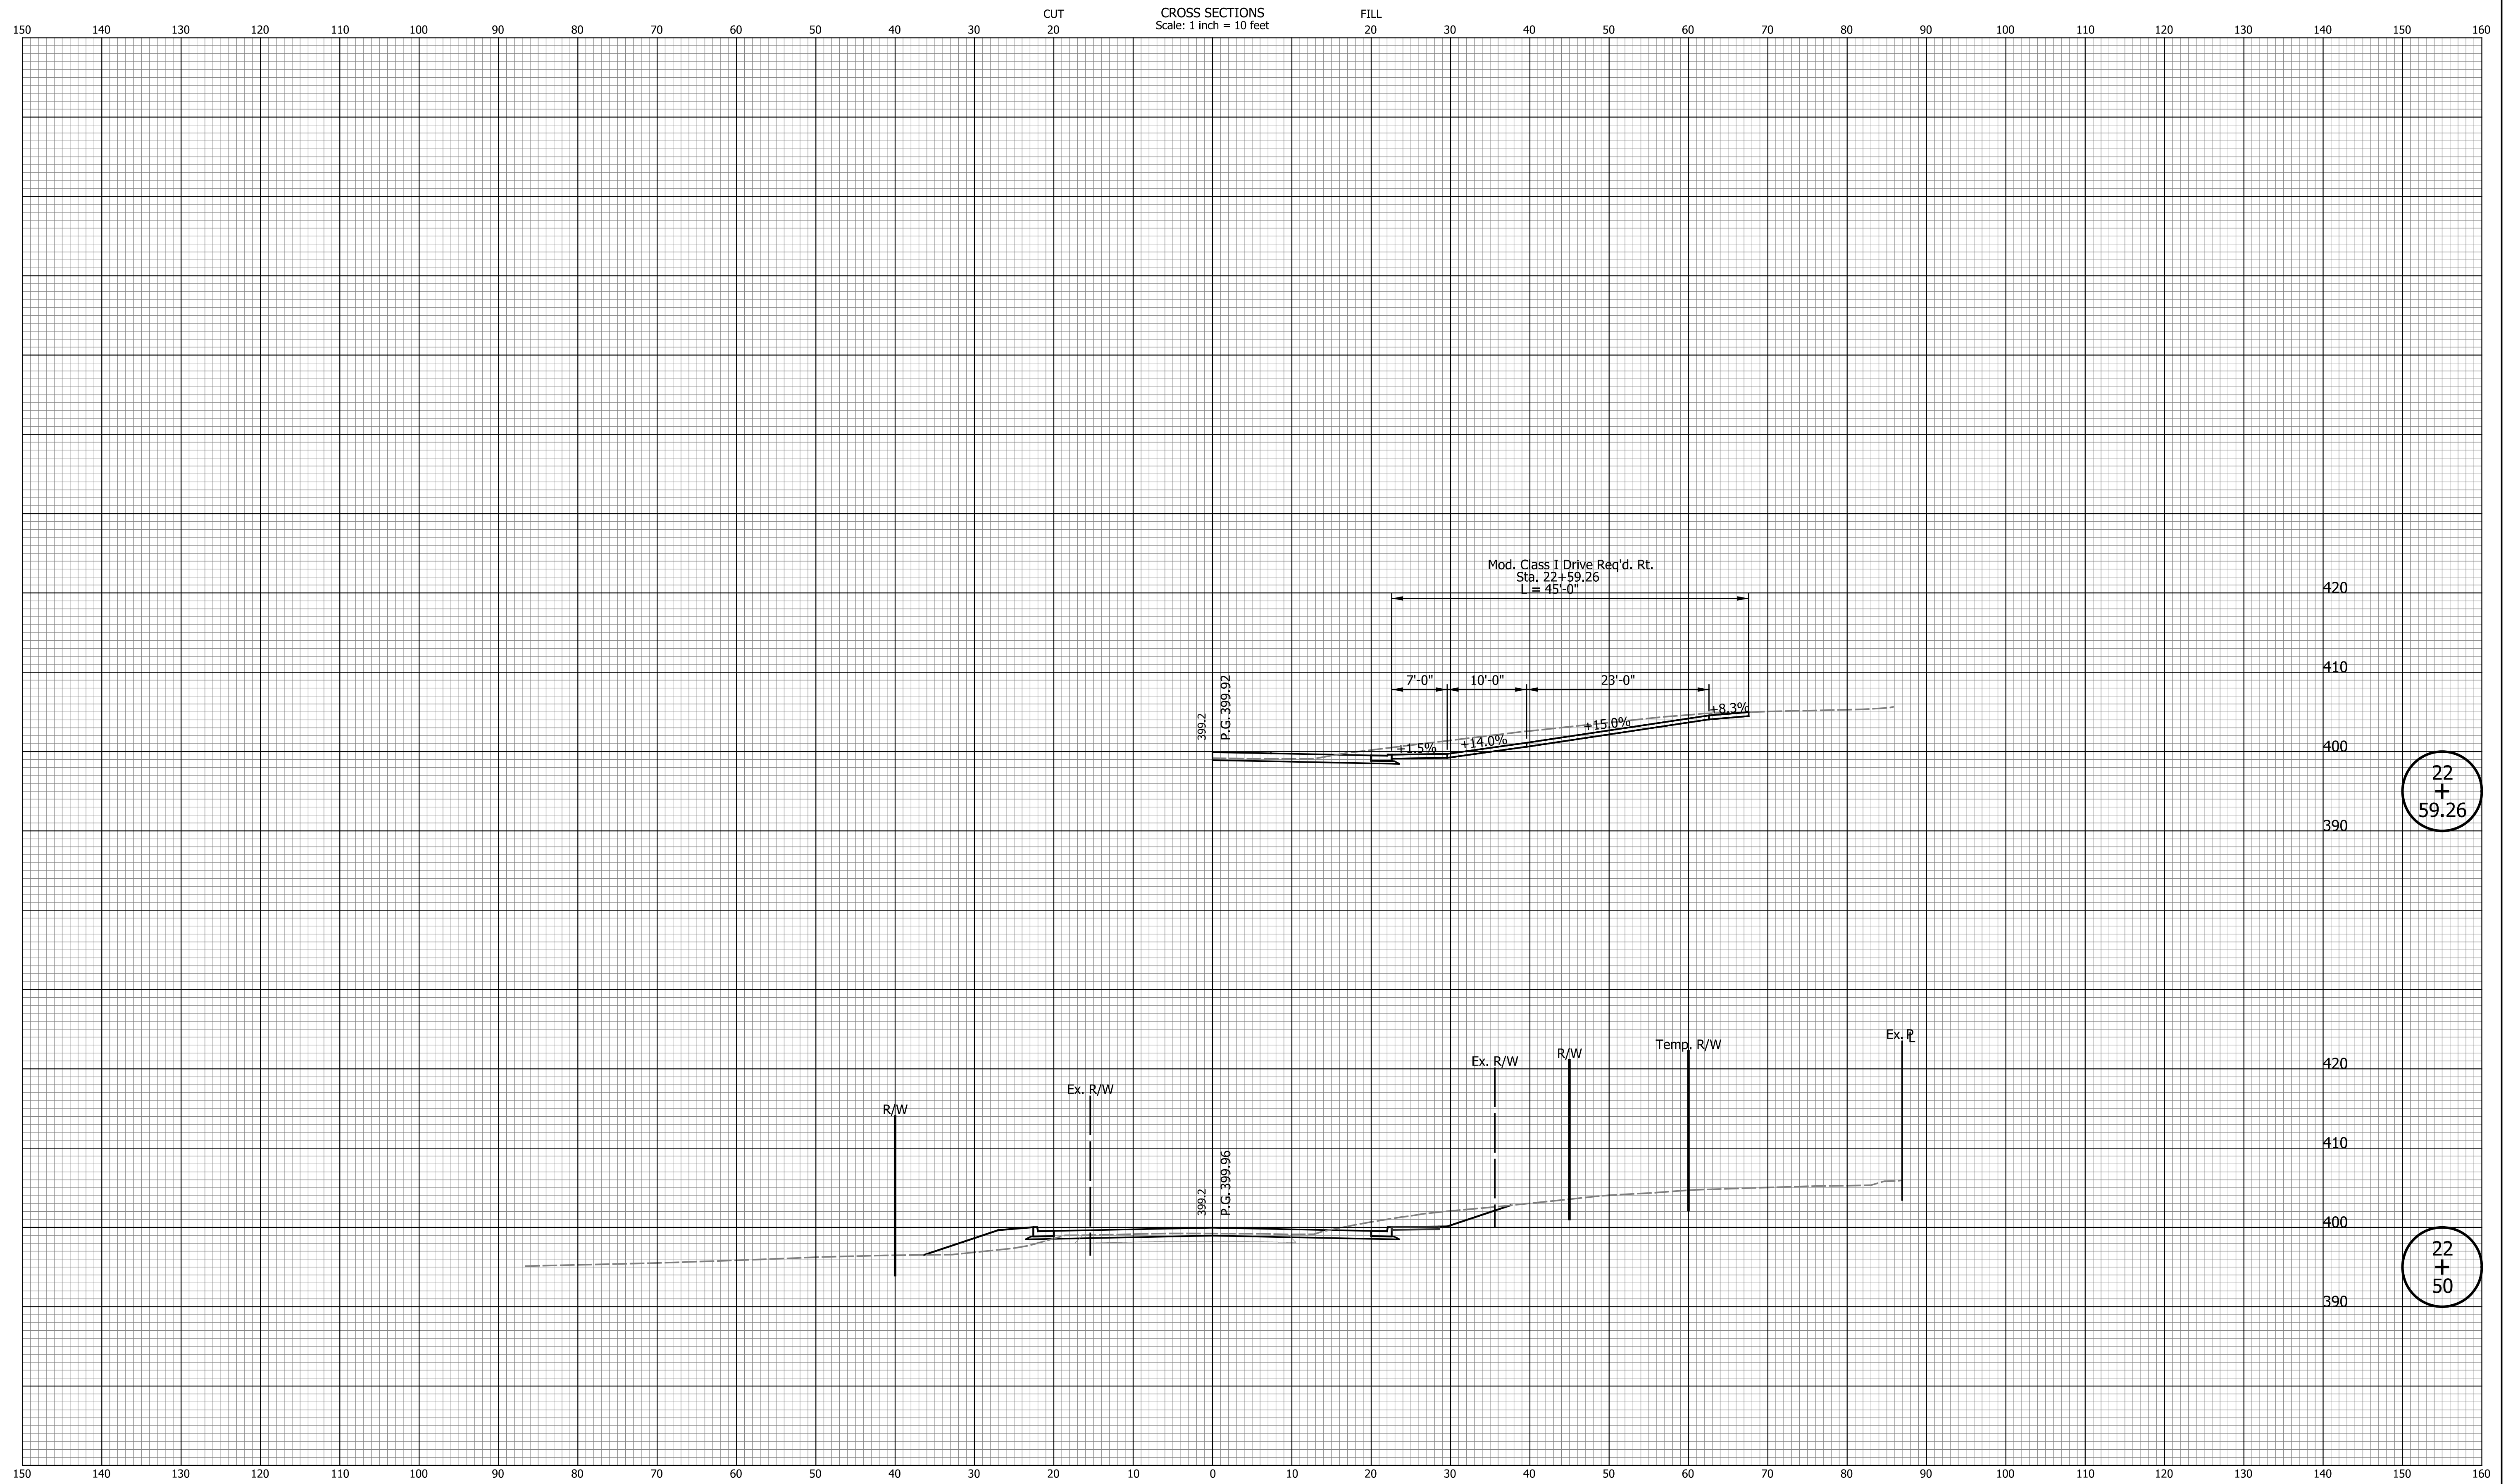

22
+
59.26

22
+
50


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INDIANA DEPARTMENT OF TRANSPORTATION	
CROSS SECTIONS LINE "PR-A"	

HORIZONTAL SCALE 1" = 10'	BRIDGE FILE N/A
VERTICAL SCALE 1" = 10'	DESIGNATION 2002538
SURVEY BOOK N/A	SHEETS 63 of 117
CONTRACT R-43470	PROJECT 2002538

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23
+
50

23
+
28.14

23
+
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DATE	REVISION

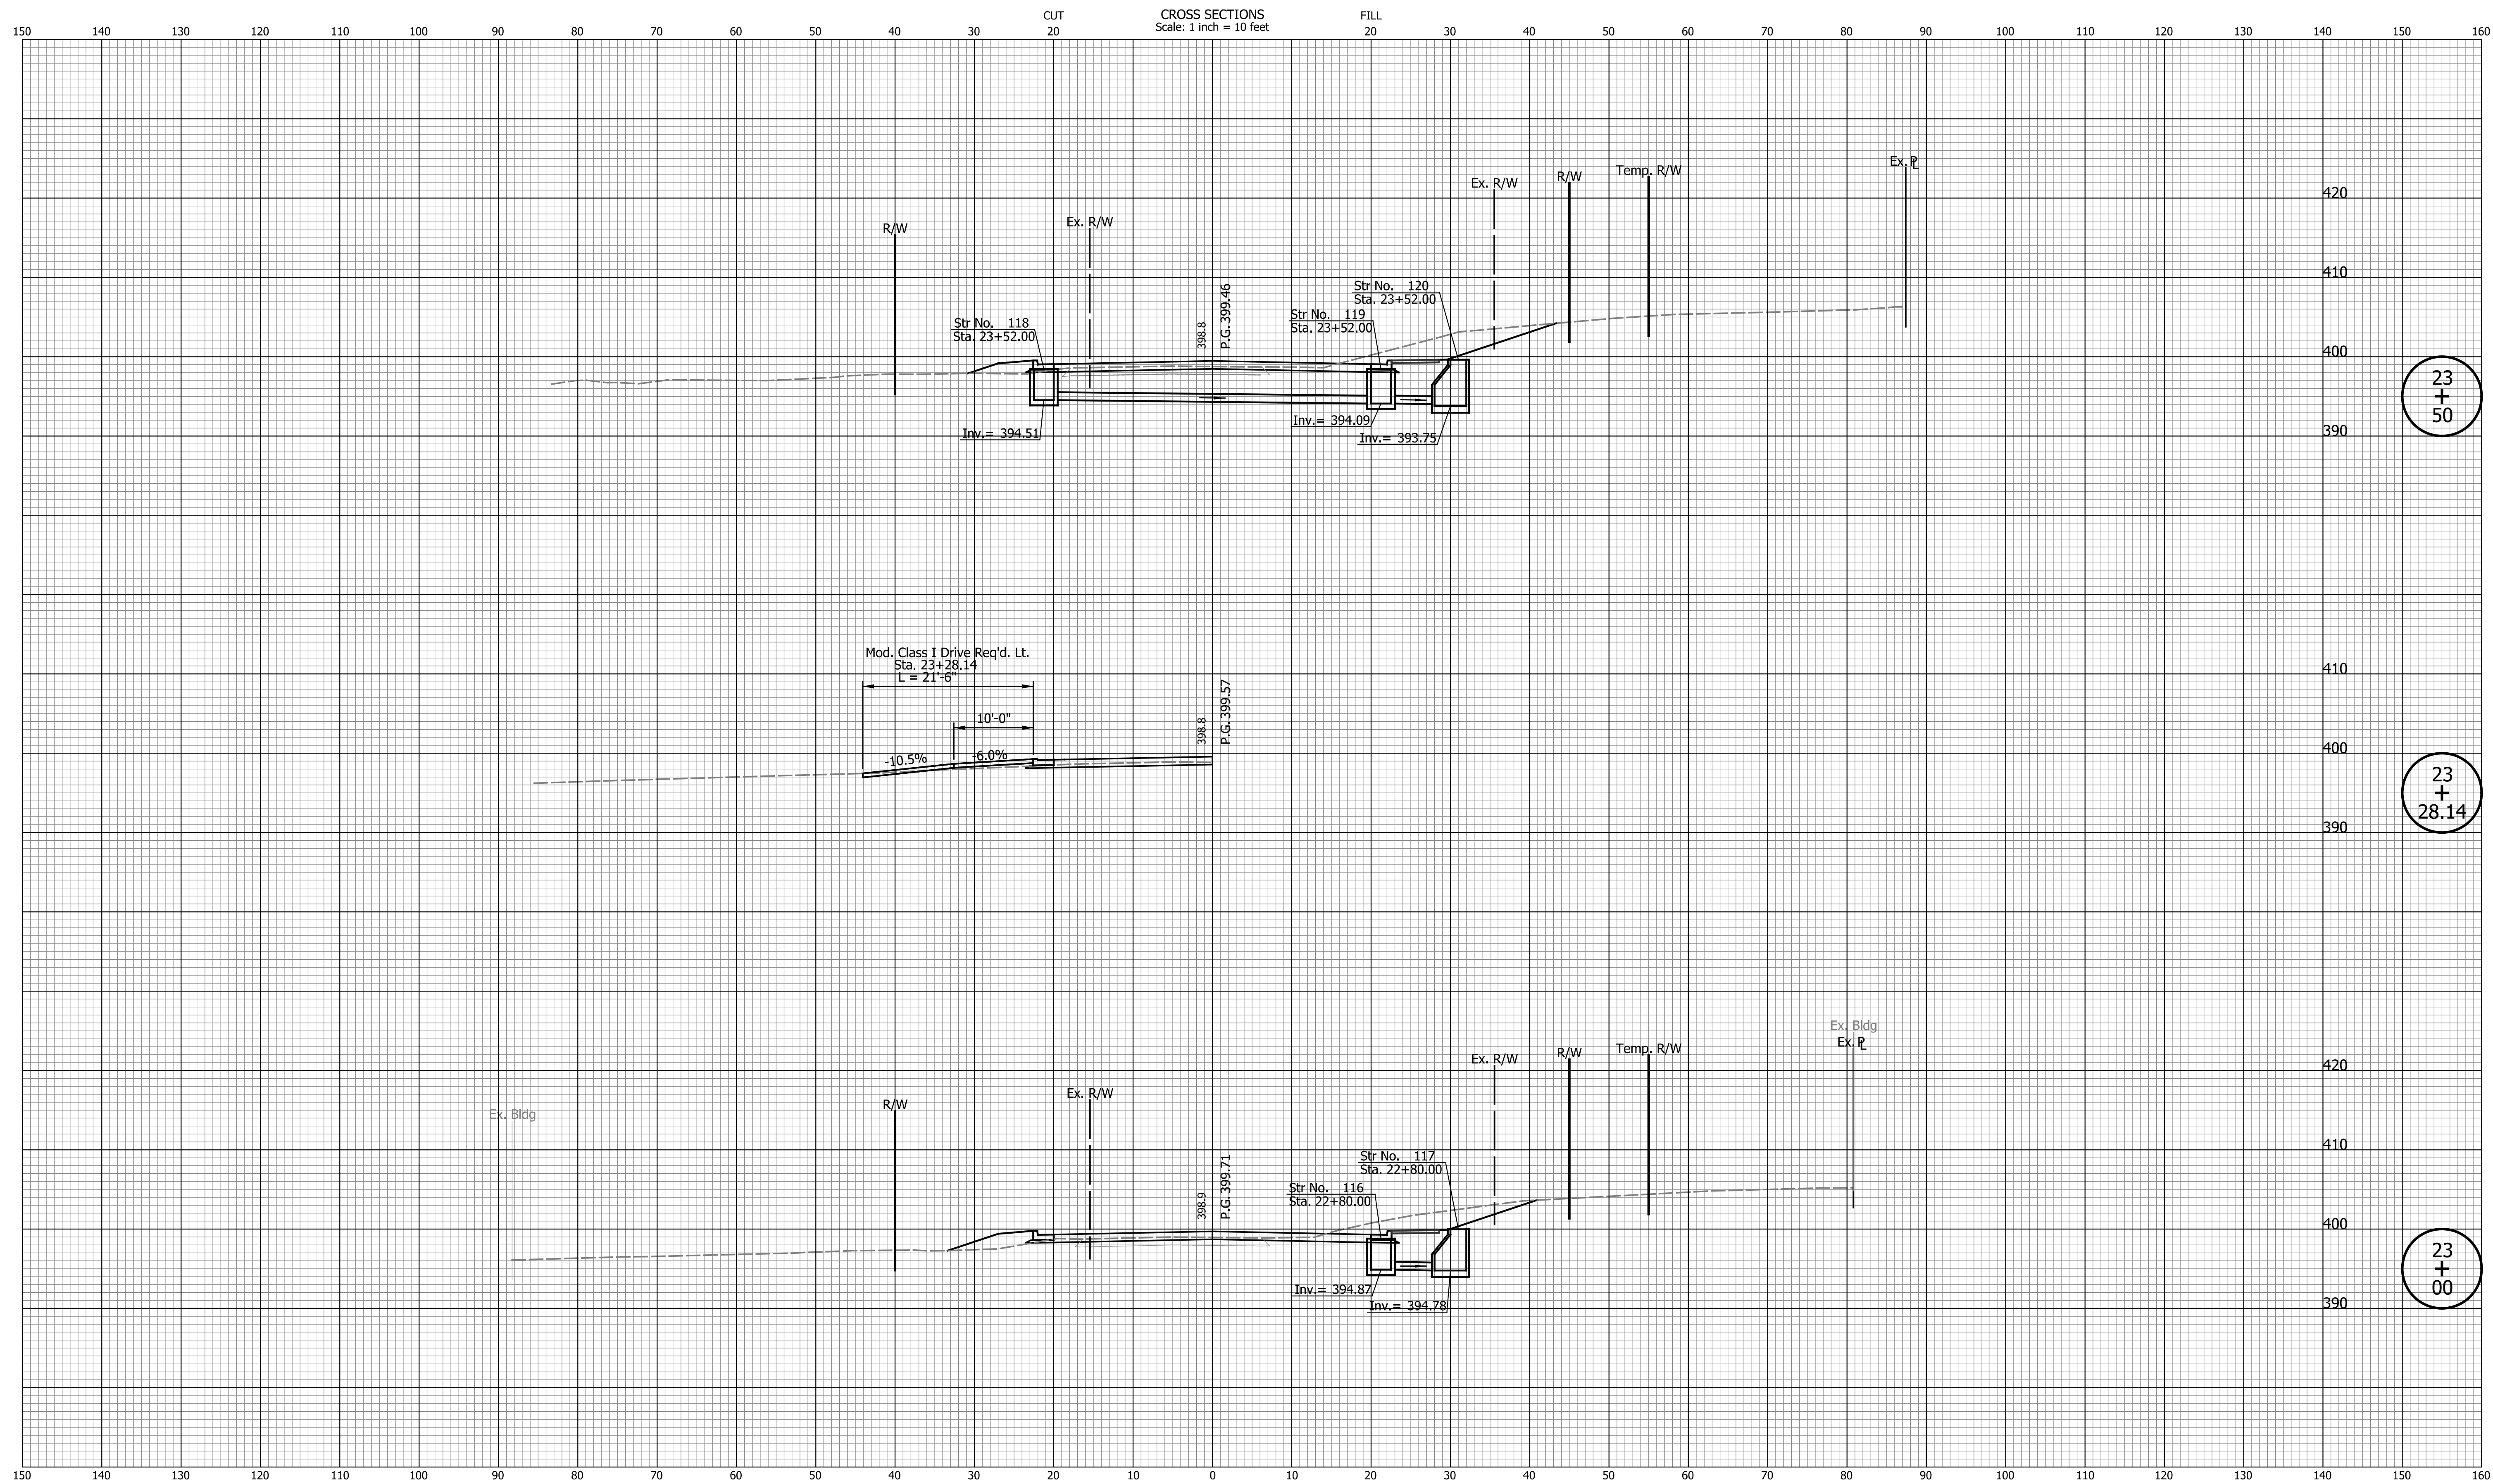
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INDIANA DEPARTMENT OF TRANSPORTATION

CROSS SECTIONS LINE "PR-A"

HORIZONTAL SCALE	BRIDGE FILE
1" = 10'	N/A
VERTICAL SCALE	DESIGNATION
1" = 10'	2002538
SURVEY BOOK	SHEETS
N/A	64 of 117
CONTRACT	PROJECT
R-43470	2002538

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24
+
18.79

24
+
15.14

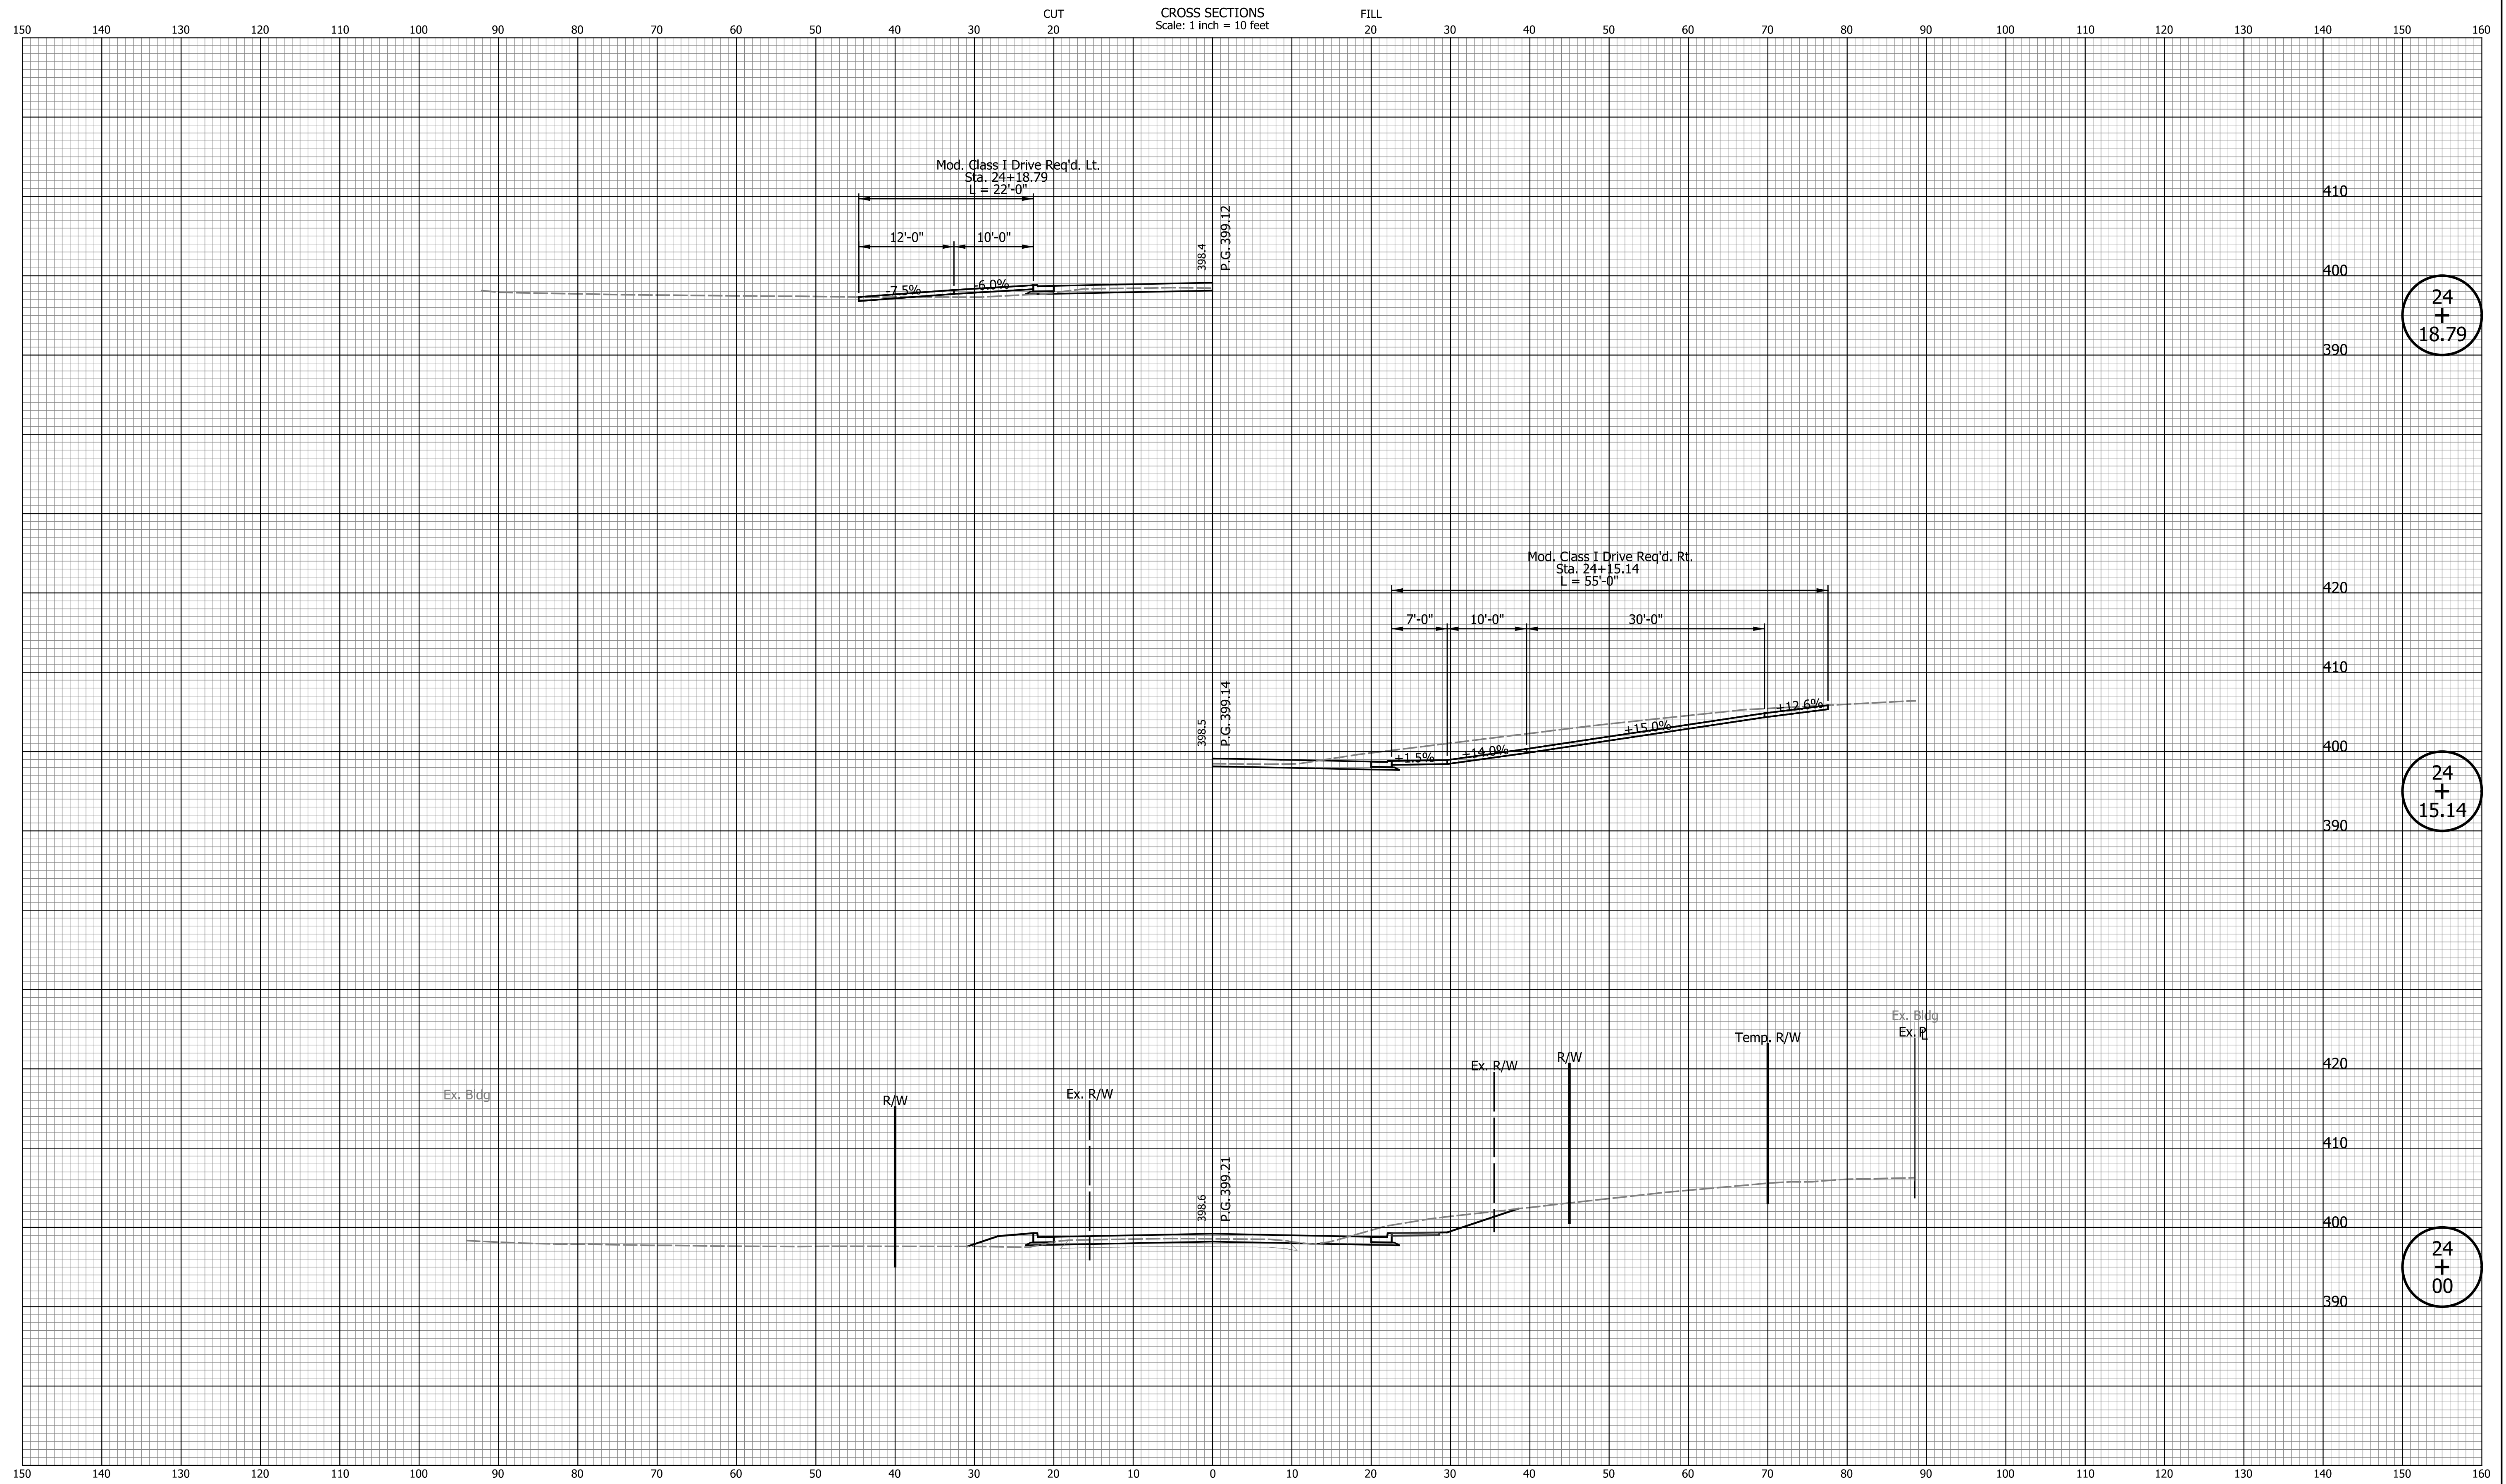24
+
00


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INDIANA DEPARTMENT OF TRANSPORTATION

CROSS SECTIONS LINE "PR-A"

HORIZONTAL SCALE 1" = 10'	BRIDGE FILE N/A
VERTICAL SCALE 1" = 10'	DESIGNATION 2002538
SURVEY BOOK N/A	SHEETS 65 of 117
CONTRACT R-43470	PROJECT 2002538



24
+
62.09

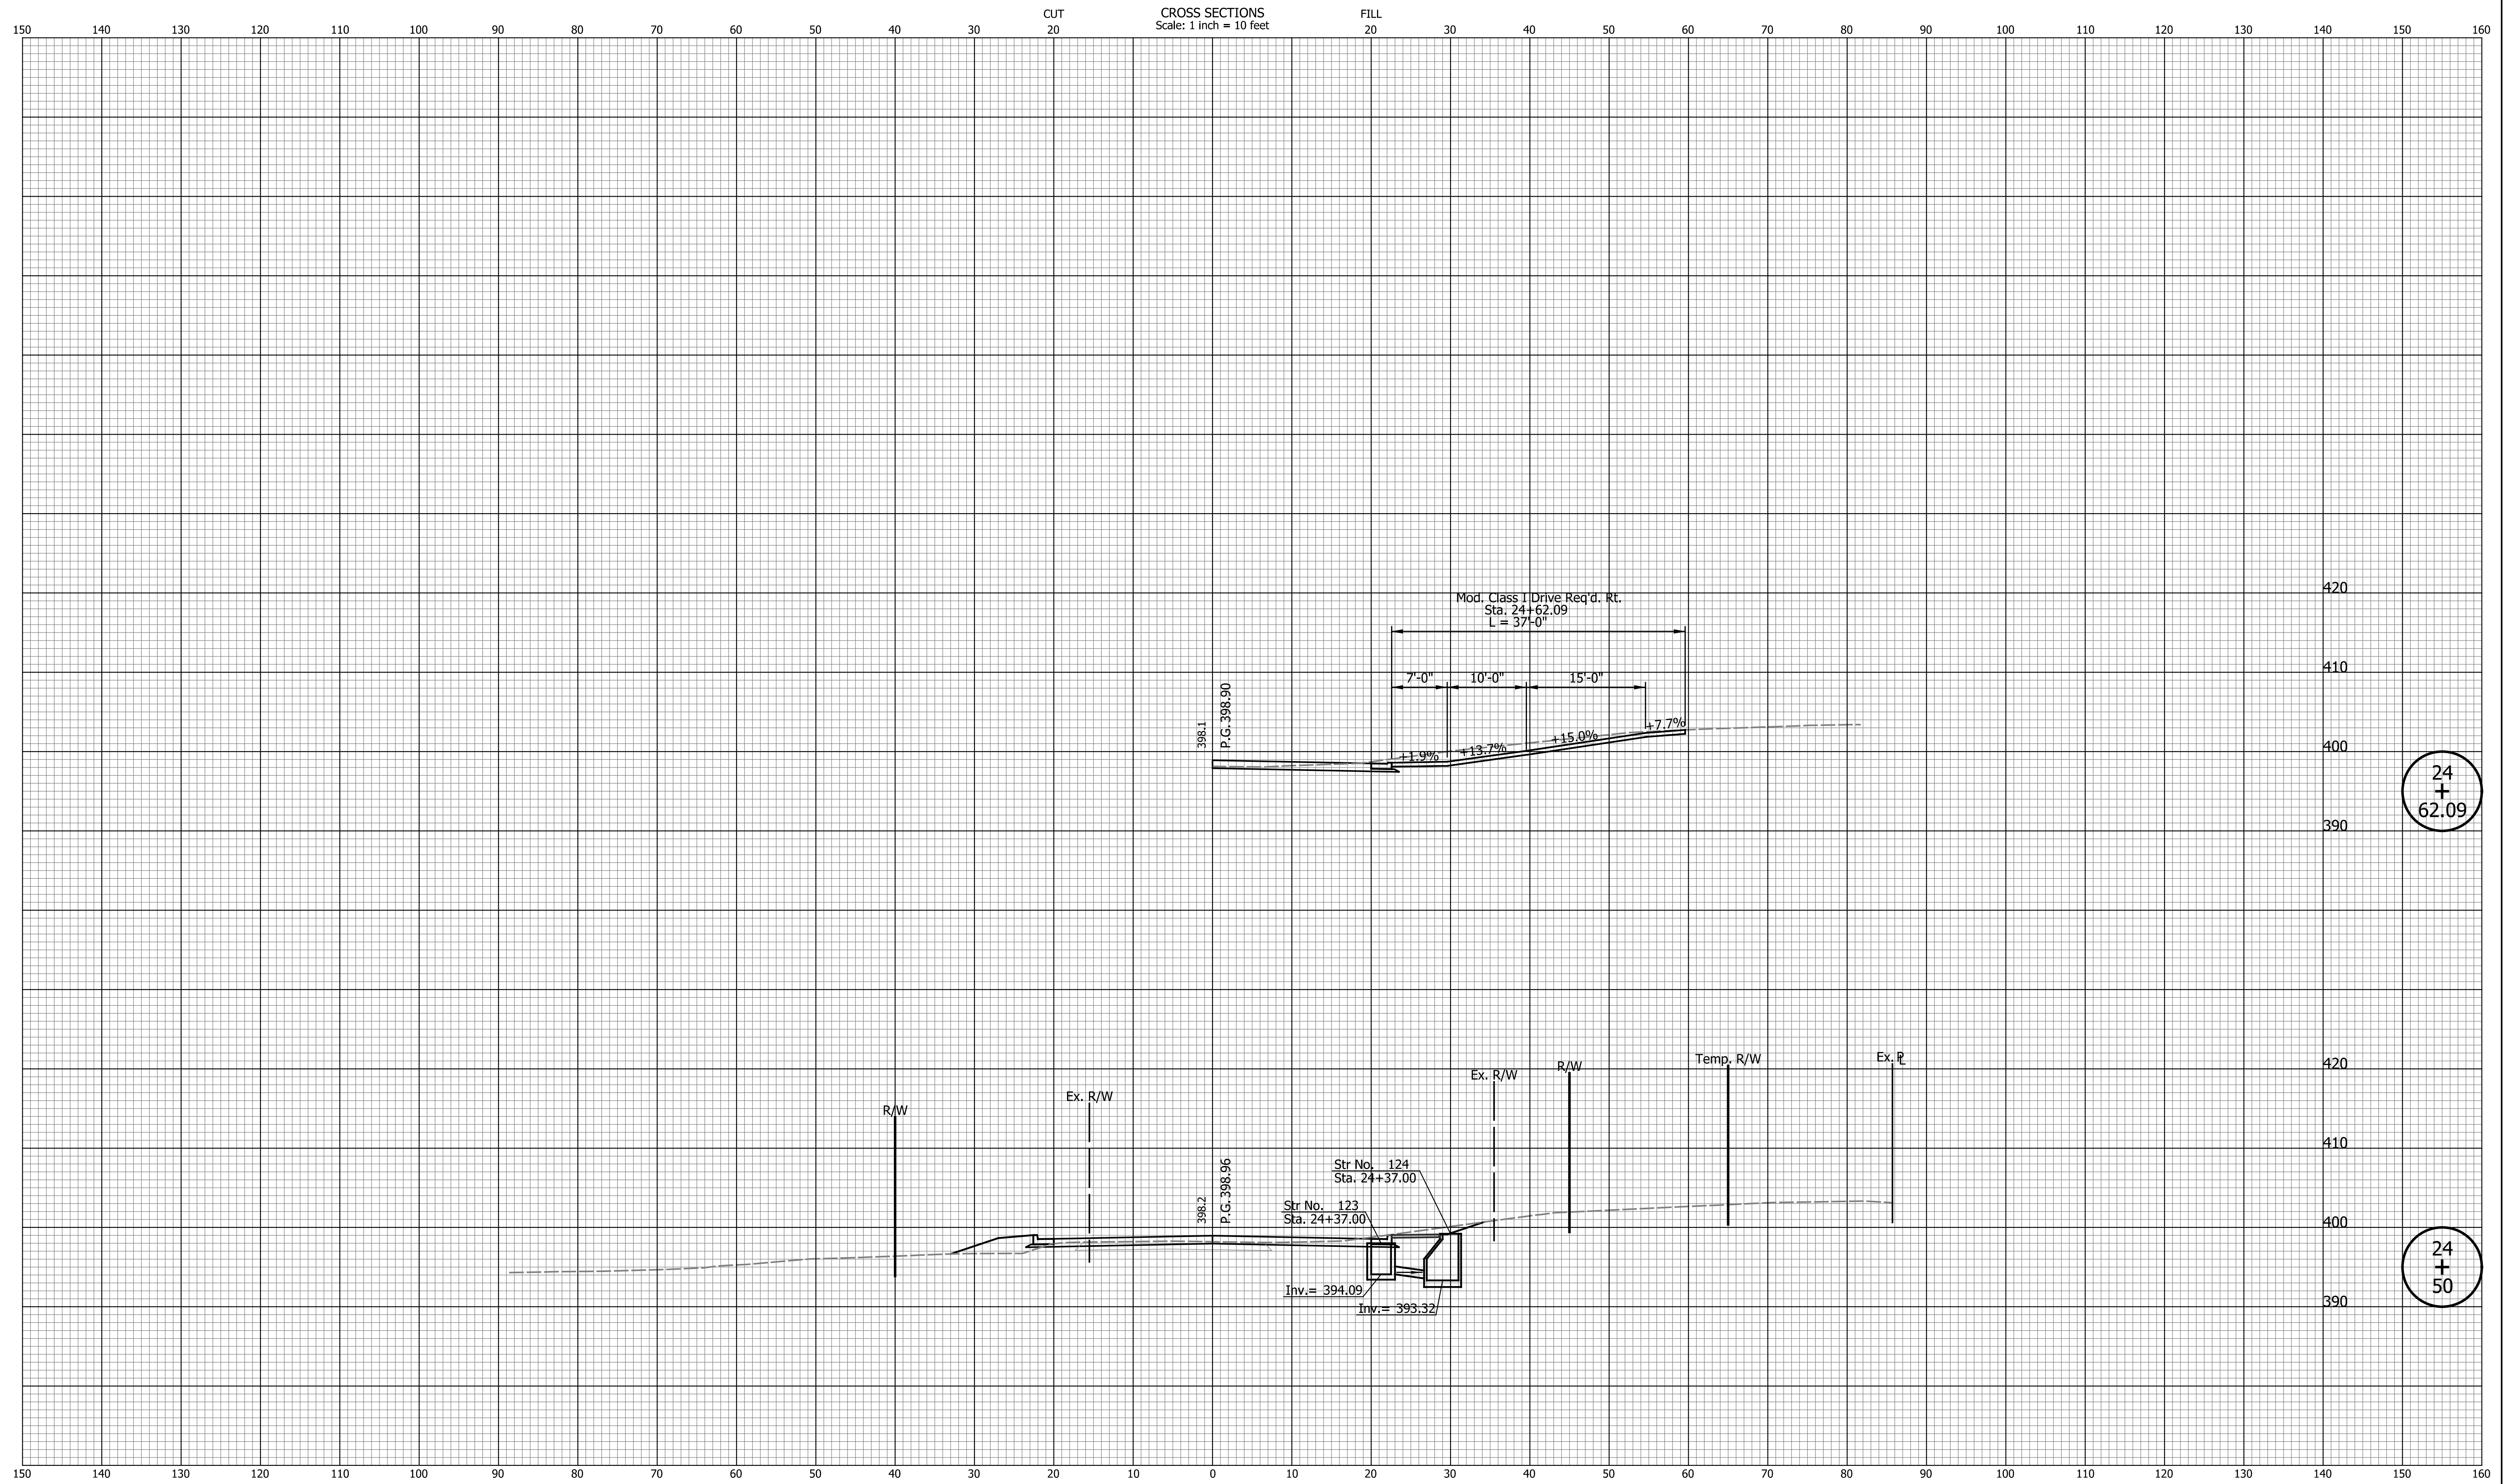24
+
50


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INDIANA DEPARTMENT OF TRANSPORTATION

CROSS SECTIONS LINE "PR-A"

HORIZONTAL SCALE	BRIDGE FILE
1" = 10'	N/A
VERTICAL SCALE	DESIGNATION
1" = 10'	2002538
SURVEY BOOK	SHEETS
N/A	66 of 117
CONTRACT	PROJECT
R-43470	2002538



DATE	REVISION

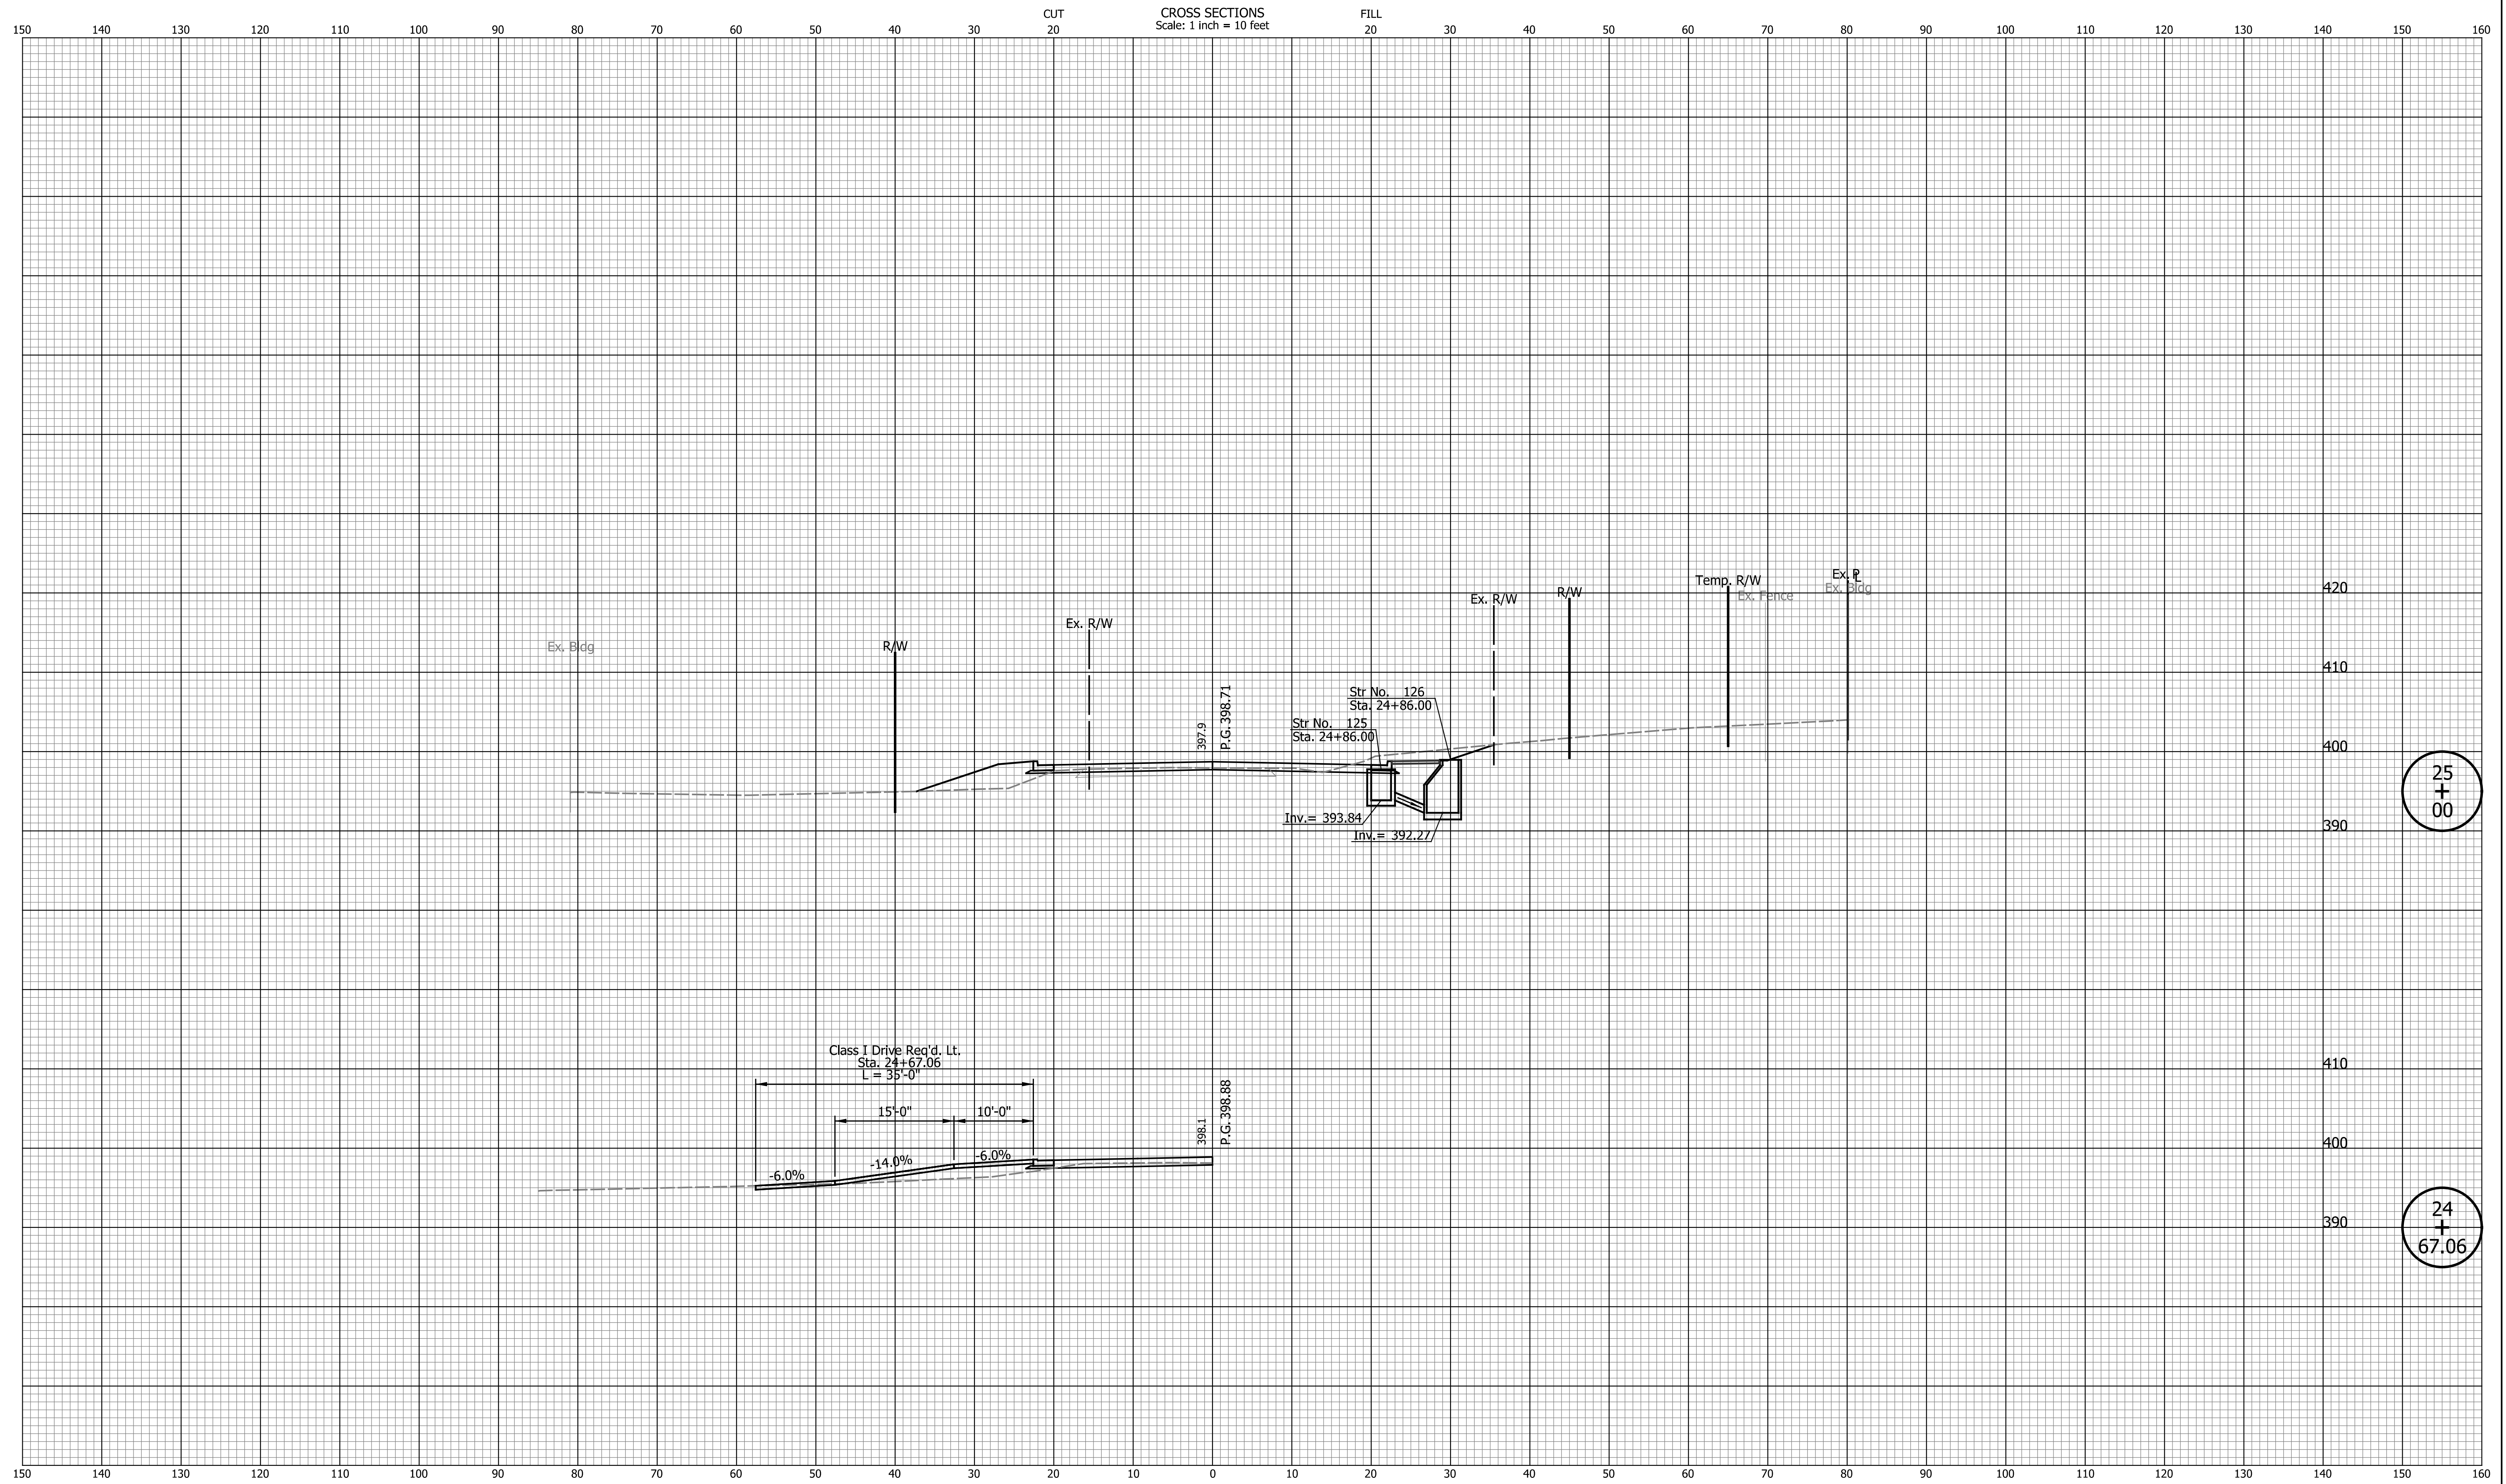
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INDIANA DEPARTMENT OF TRANSPORTATION

CROSS SECTIONS LINE "PR-A"

HORIZONTAL SCALE	BRIDGE FILE
1" = 10'	N/A
VERTICAL SCALE	DESIGNATION
1" = 10'	2002538
SURVEY BOOK	SHEETS
N/A	67 of 117
CONTRACT	PROJECT
R-43470	2002538

Indiana State

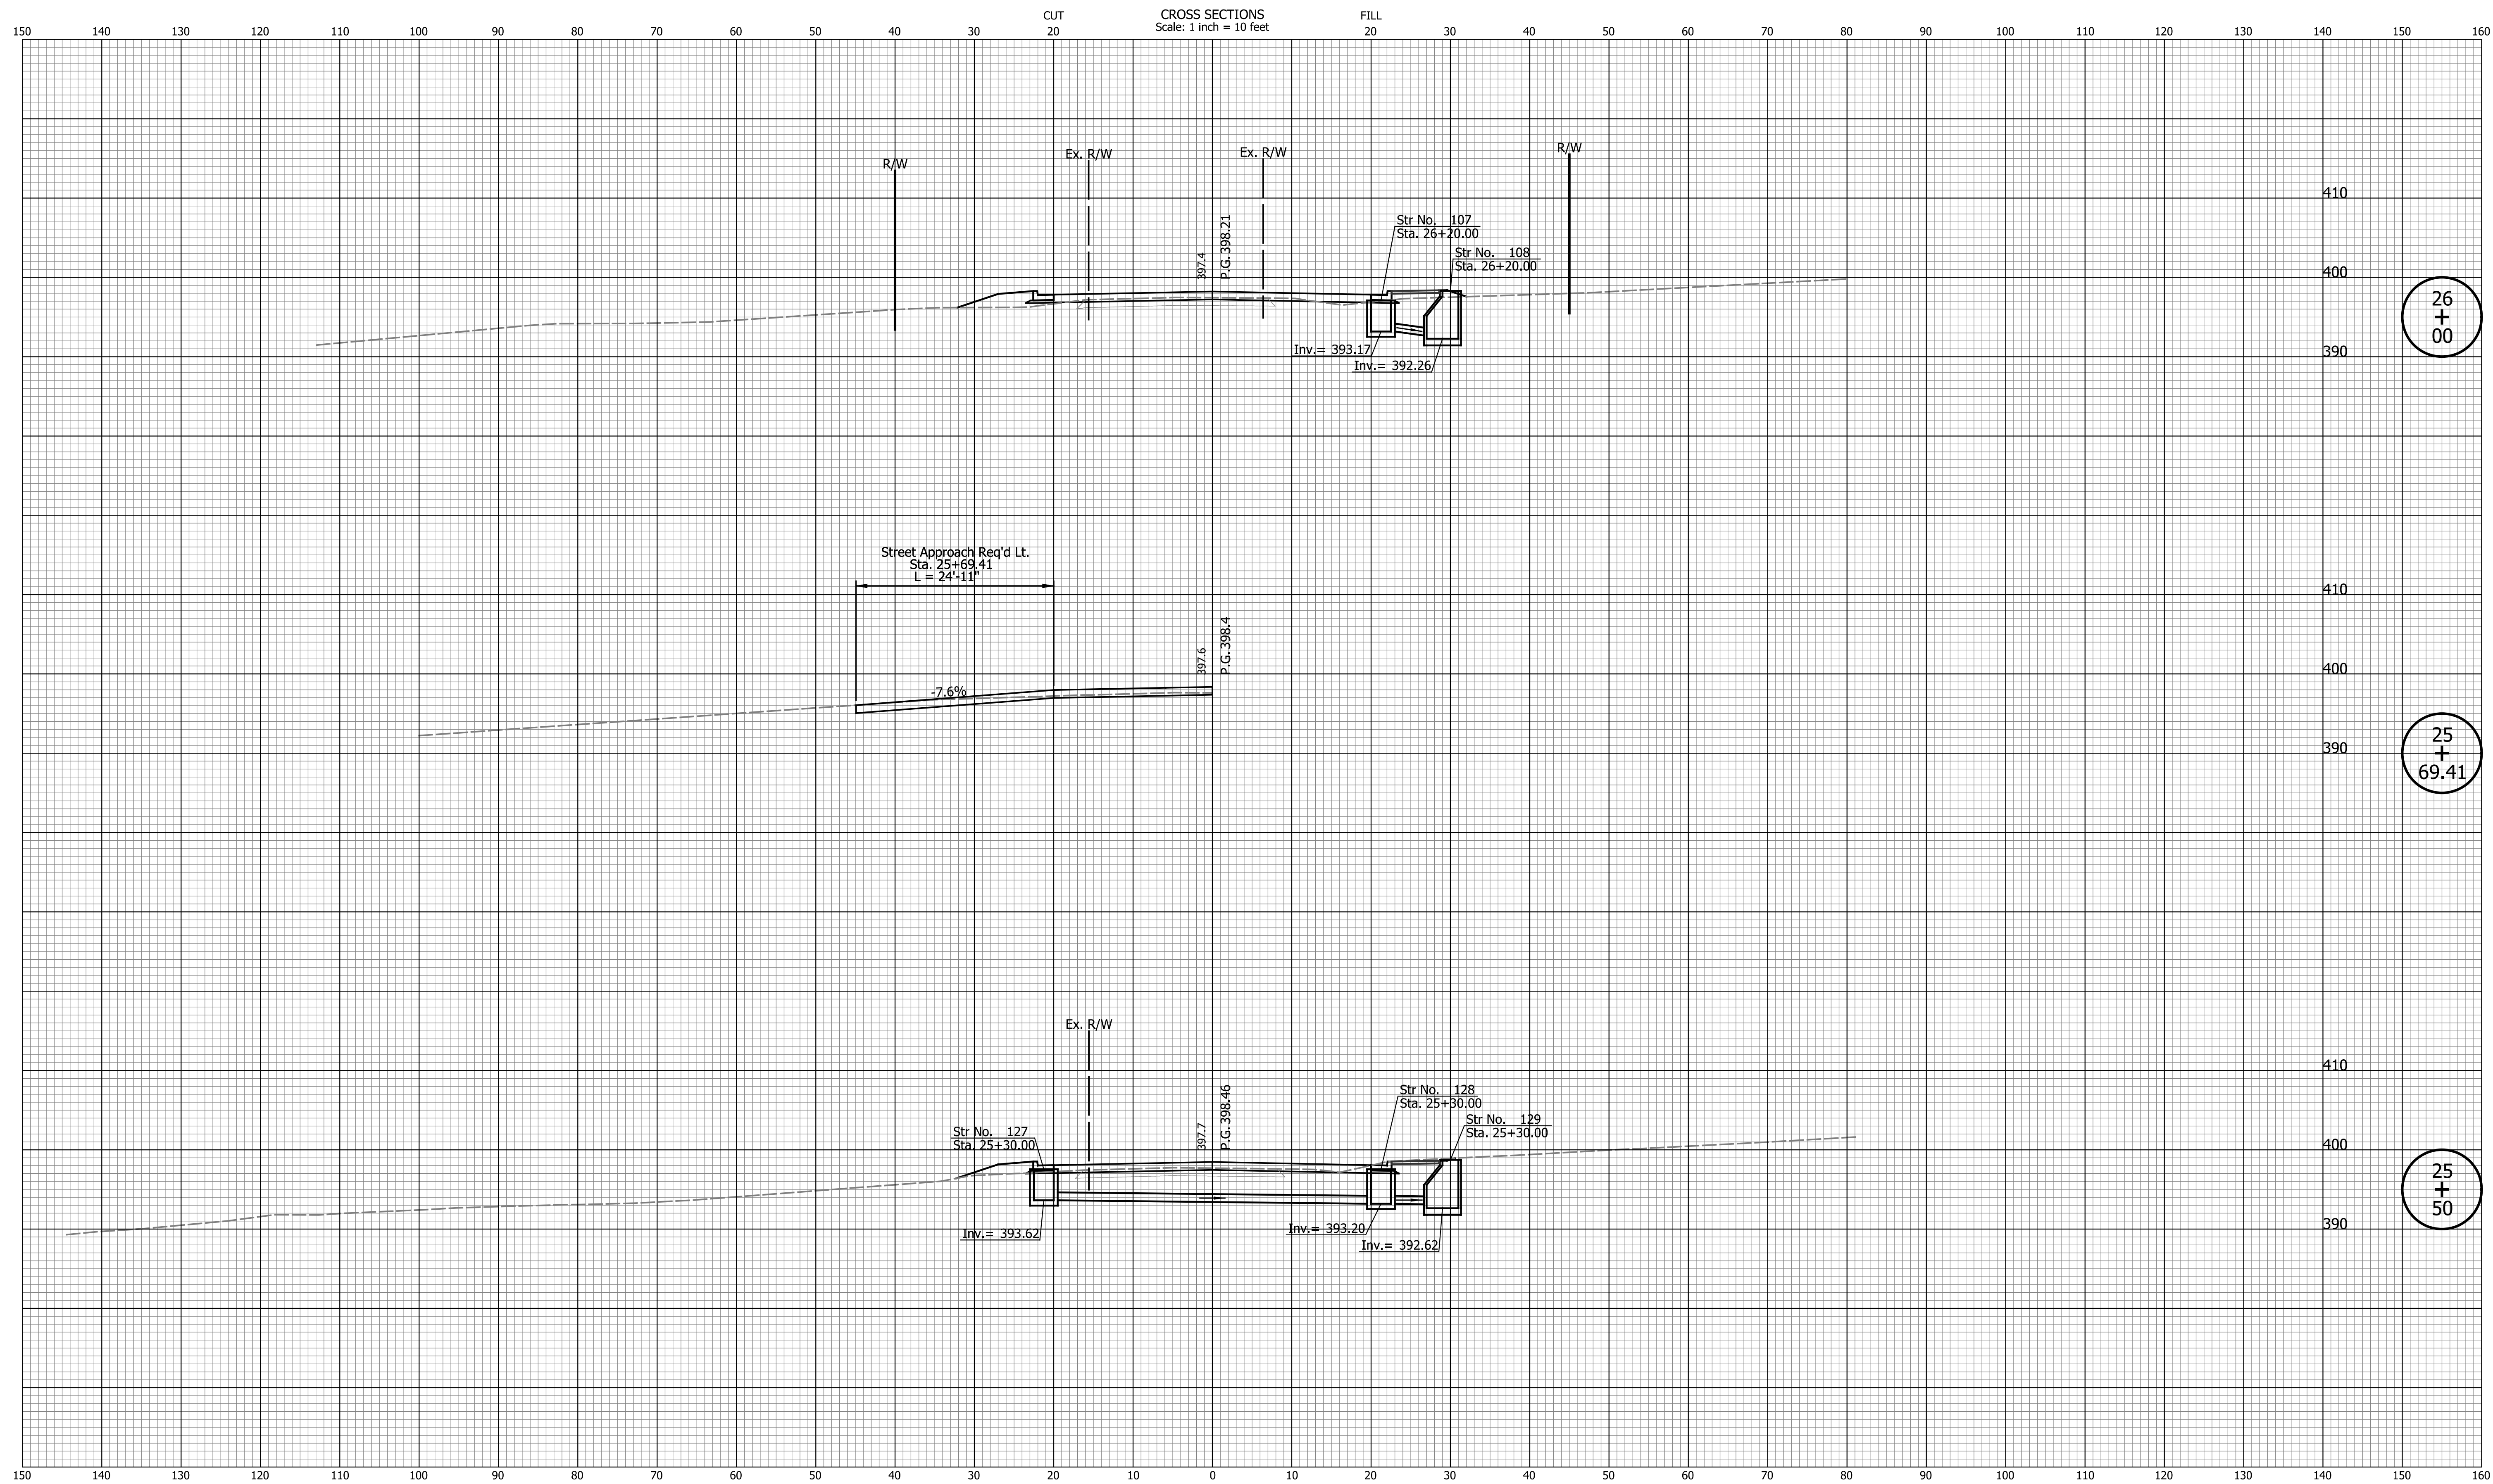

26
+
00

25
+
69.41

25
+
30

DATE	REVISION


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INDIANA DEPARTMENT OF TRANSPORTATION

CROSS SECTIONS LINE "PR-A"

HORIZONTAL SCALE	BRIDGE FILE
1" = 10'	N/A
VERTICAL SCALE	DESIGNATION
1" = 10'	2002538
SURVEY BOOK	SHEETS
N/A	68 of 117
CONTRACT	PROJECT
R-43470	2002538

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27
+
00

26
+
67.62

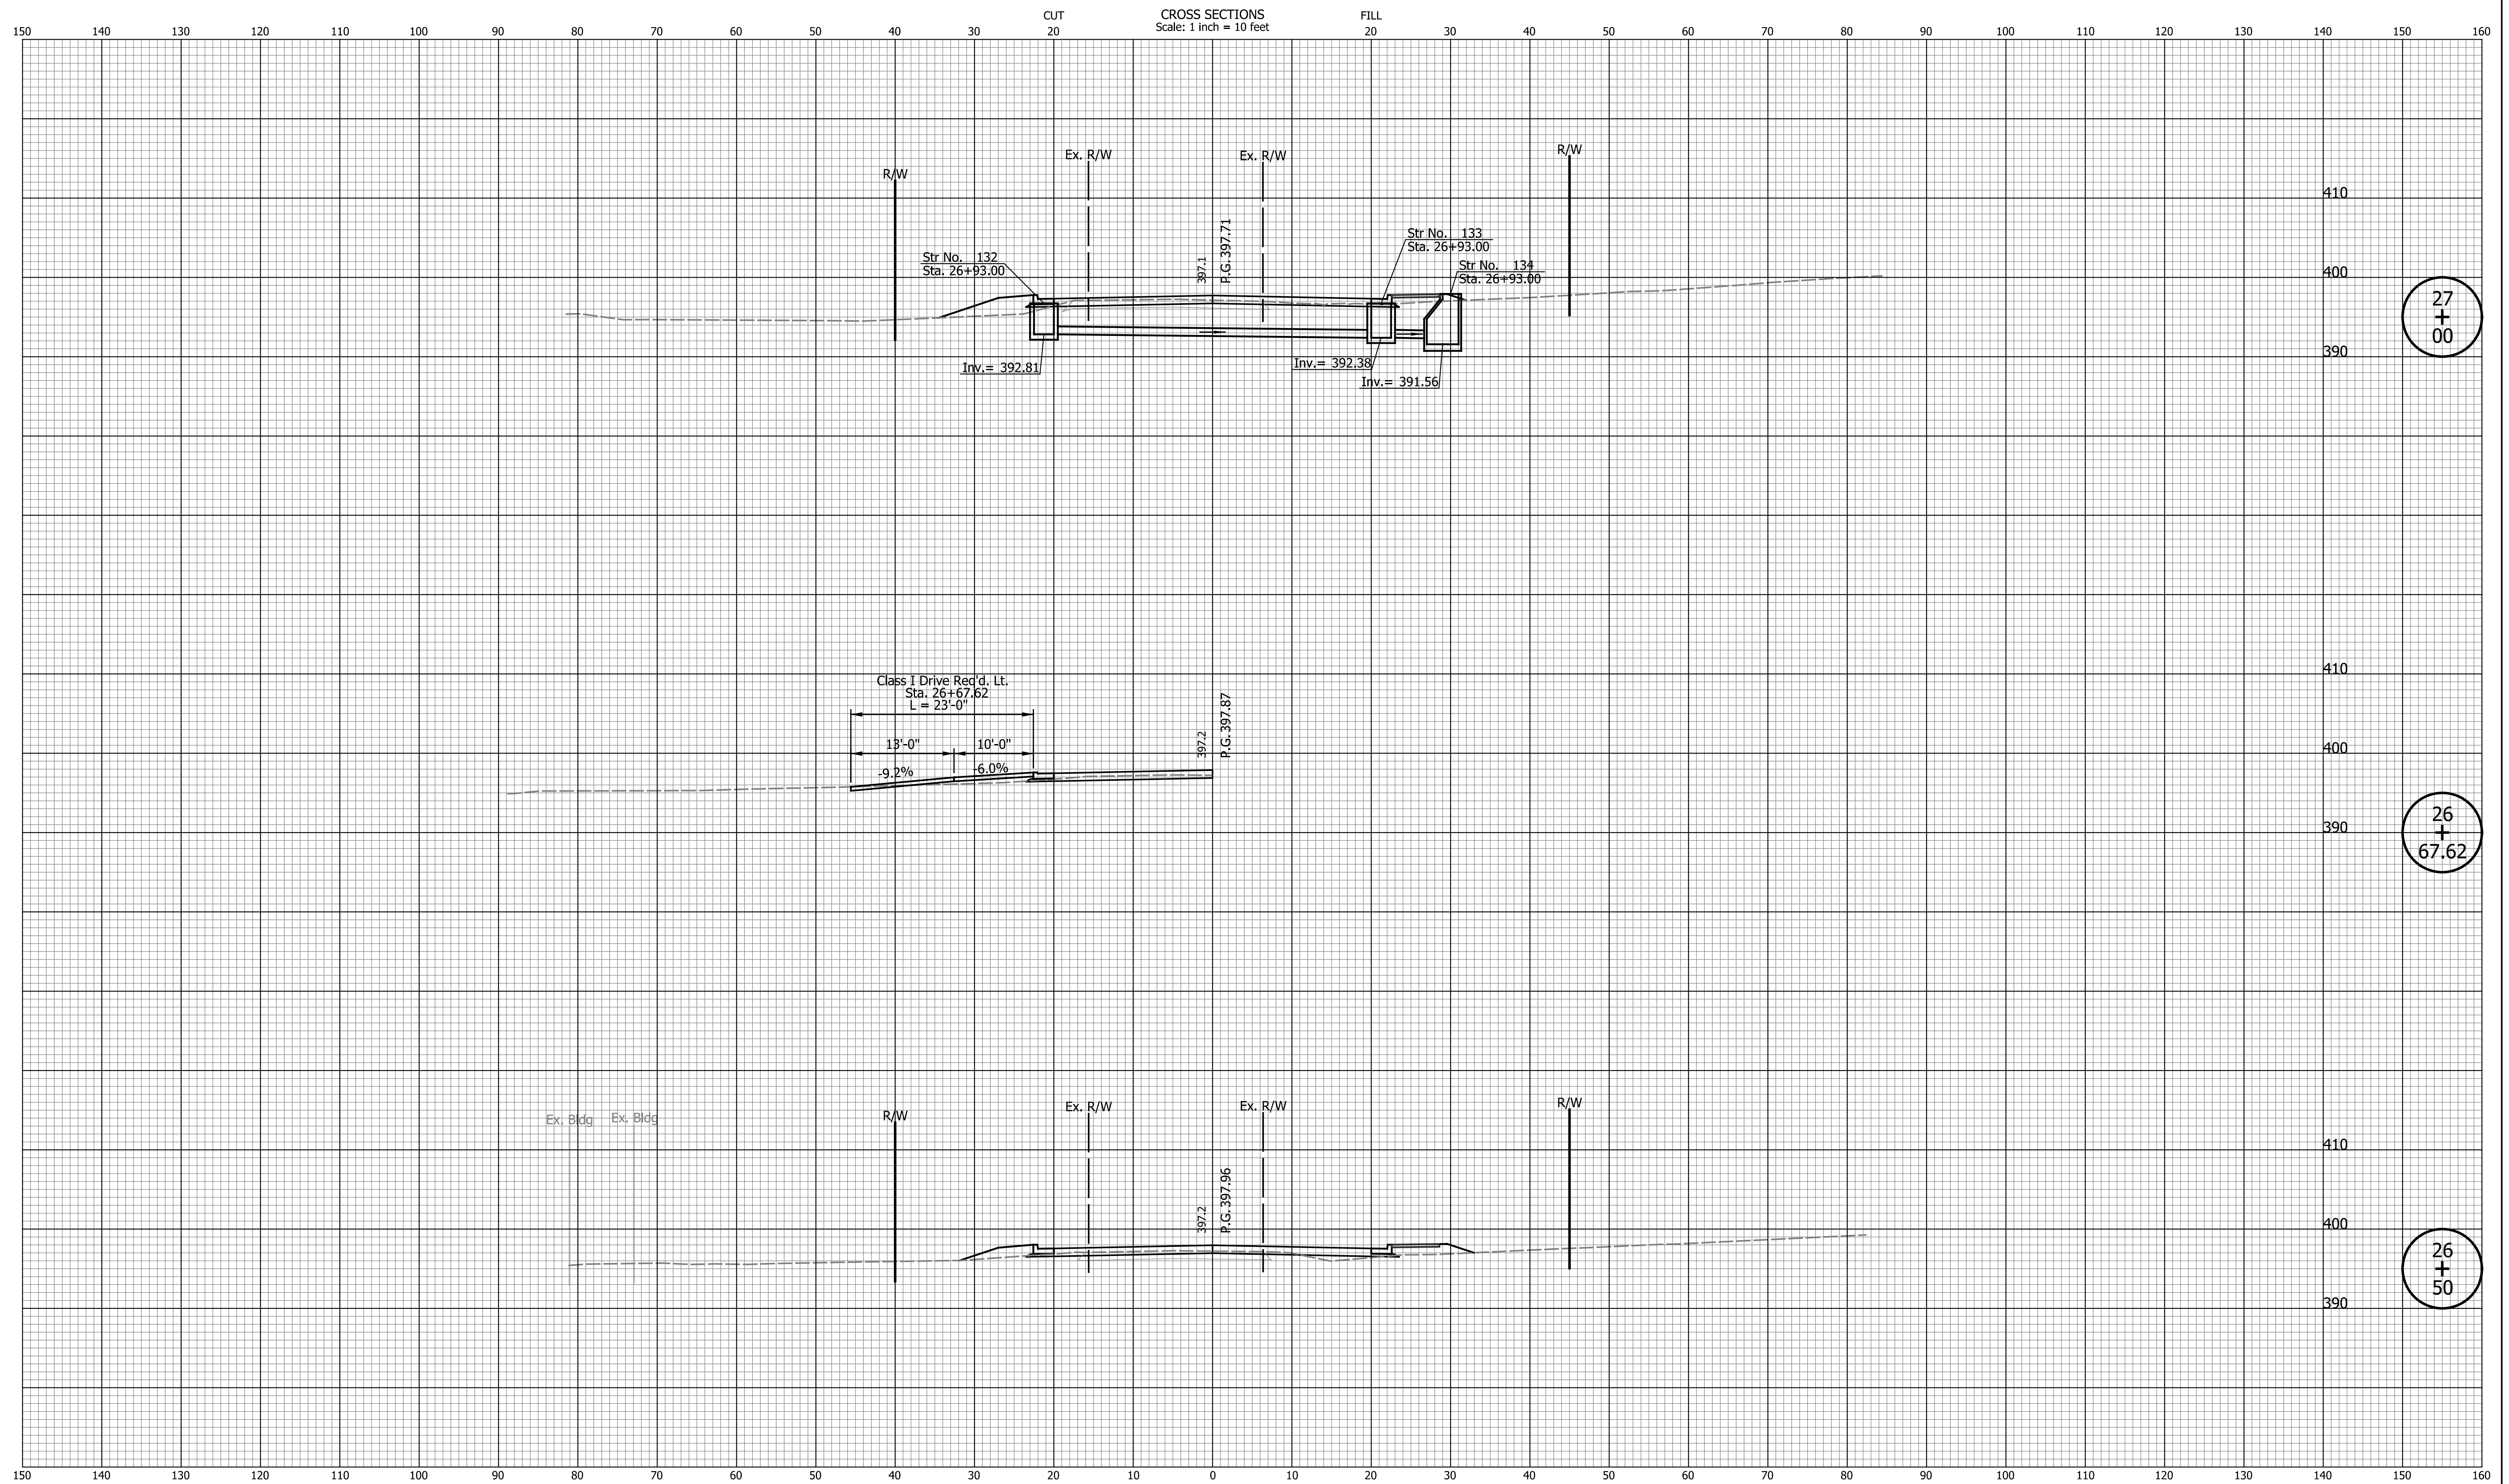26
+
50

DATE	REVISION


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INDIANA DEPARTMENT OF TRANSPORTATION

CROSS SECTIONS LINE "PR-A"

HORIZONTAL SCALE	BRIDGE FILE
1" = 10'	N/A
VERTICAL SCALE	DESIGNATION
1" = 10'	2002538
SURVEY BOOK	SHEETS
N/A	69 of 117
CONTRACT	PROJECT
R-43470	2002538

Indiana State

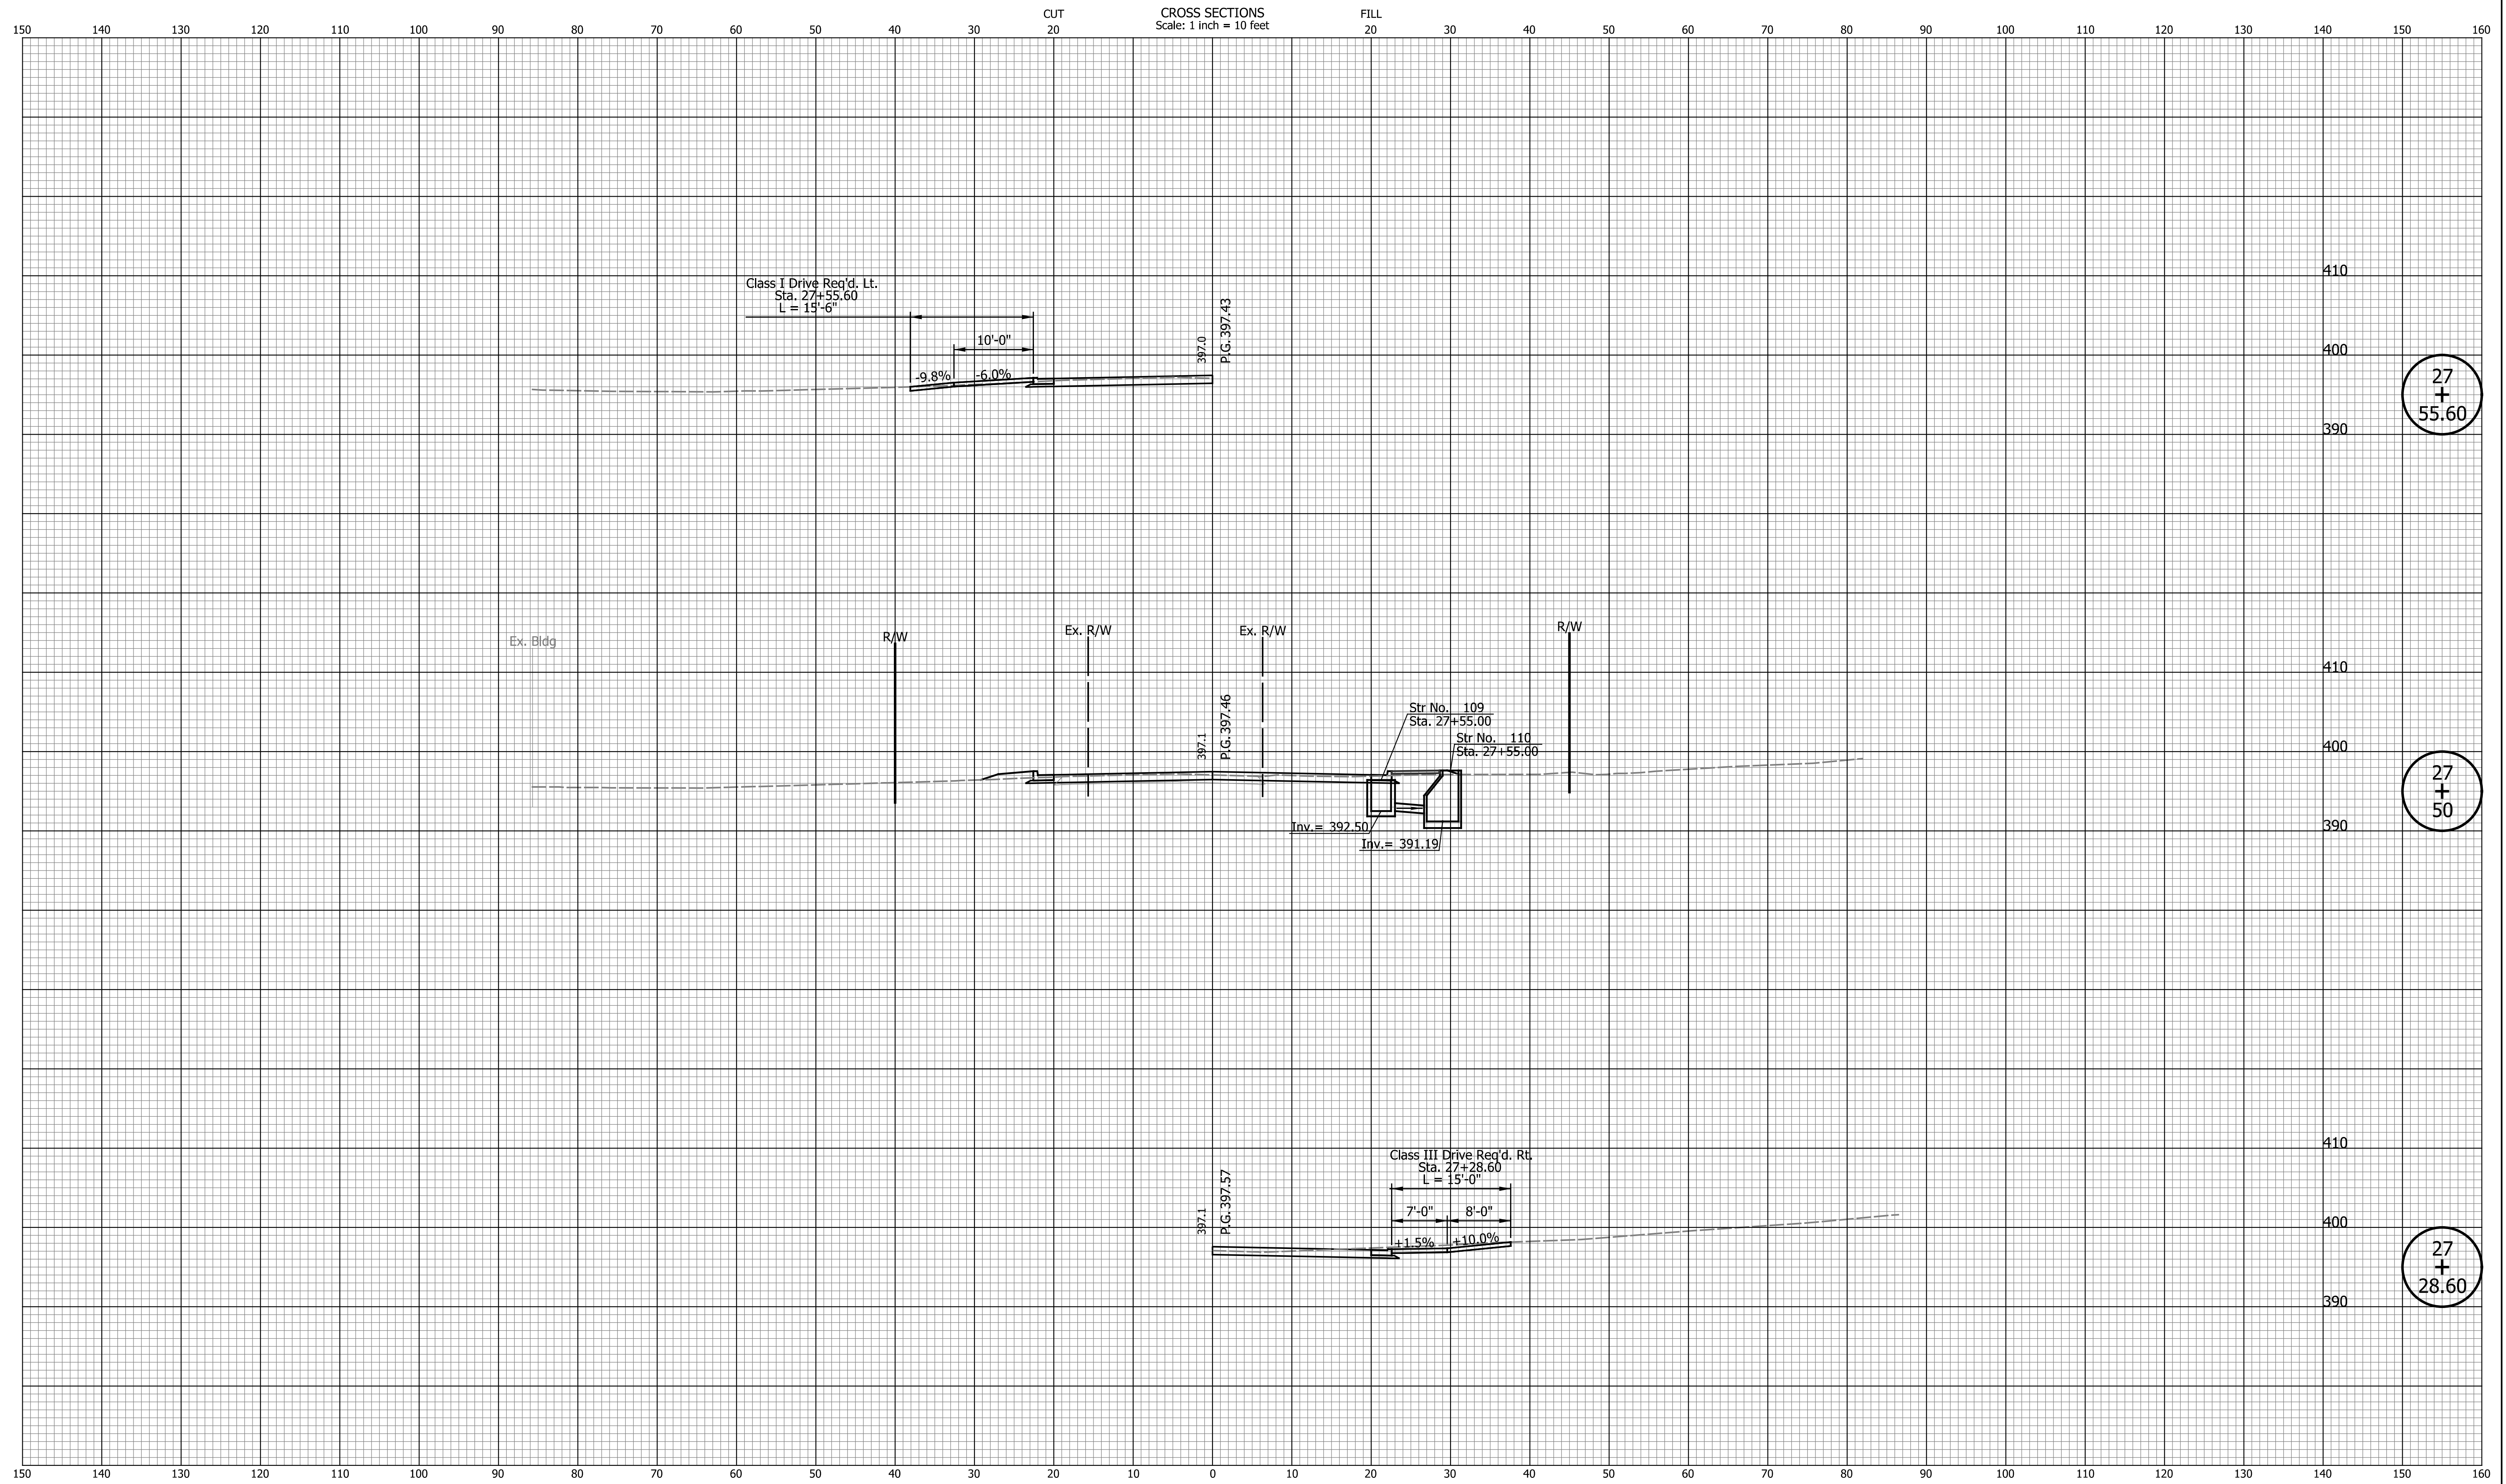

27
+
55.60

27
+
50

27
+
28.60


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INDIANA DEPARTMENT OF TRANSPORTATION

CROSS SECTIONS LINE "PR-A"

HORIZONTAL SCALE	BRIDGE FILE
1" = 10'	N/A
VERTICAL SCALE	DESIGNATION
1" = 10'	2002538
SURVEY BOOK	SHEETS
N/A	70 of 117
CONTRACT	PROJECT
R-43470	2002538



28
+
50

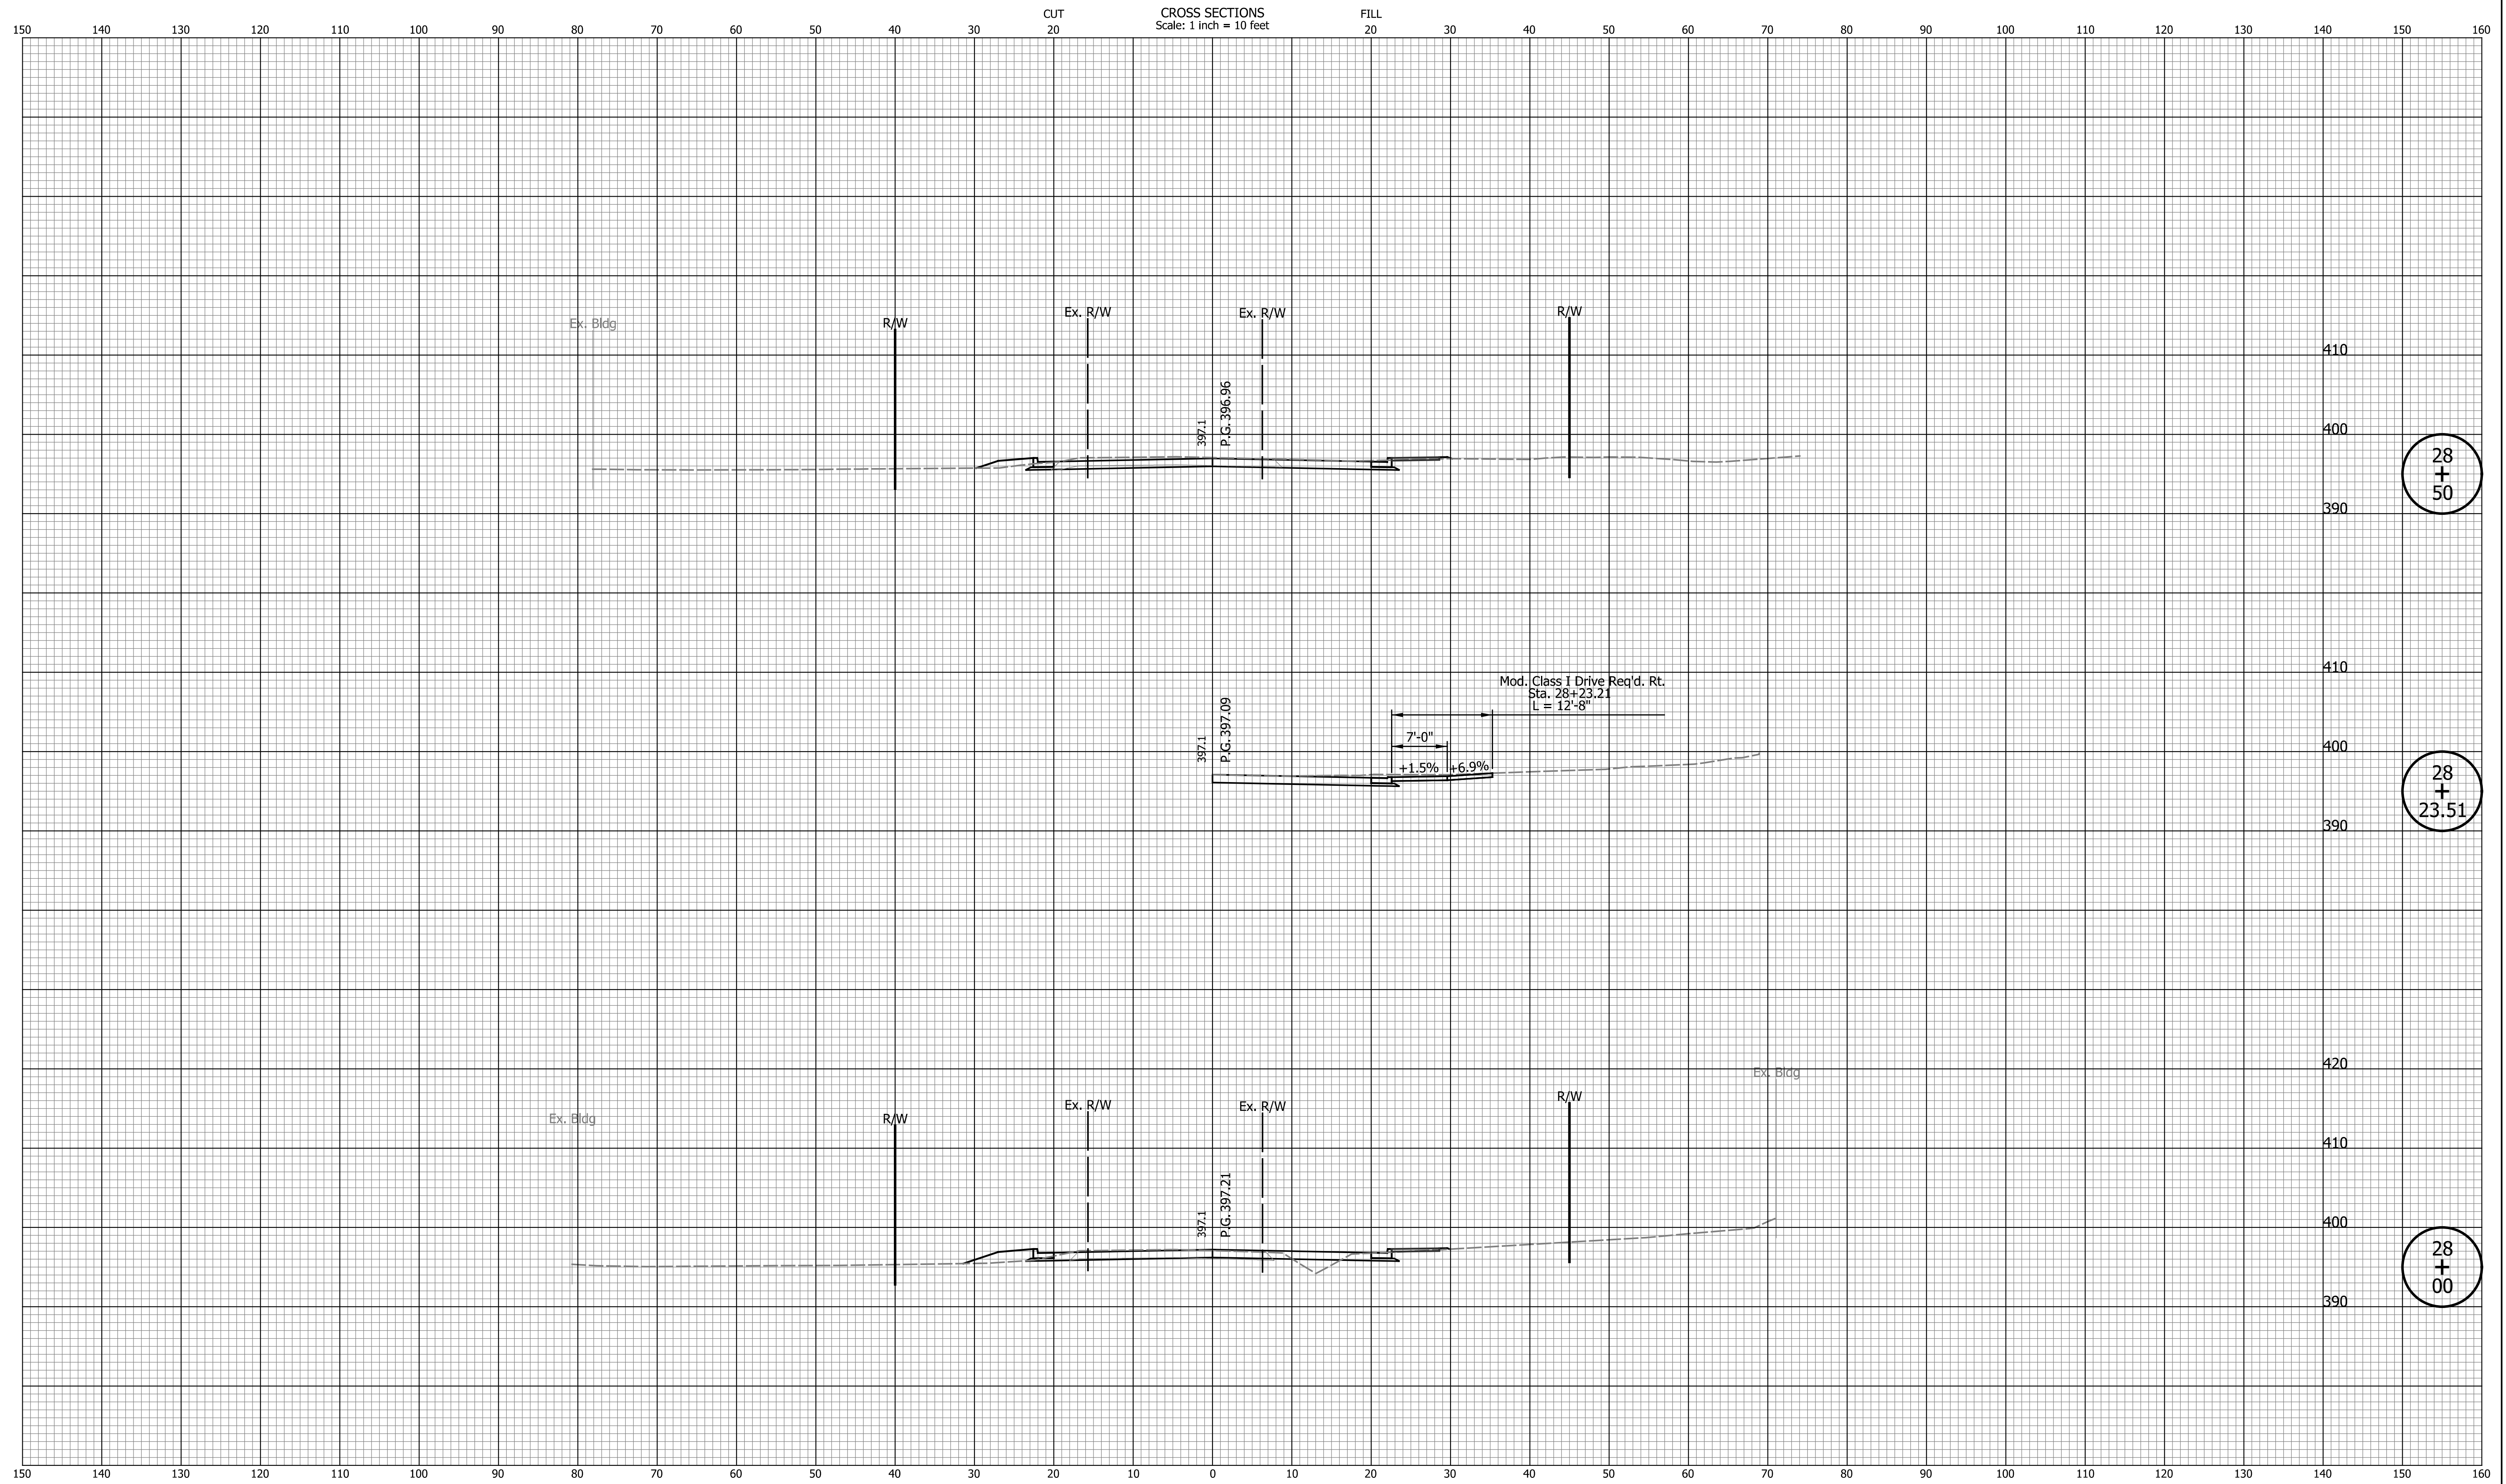28
+
23.51

28
+
00


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INDIANA DEPARTMENT OF TRANSPORTATION

CROSS SECTIONS LINE "PR-A"

HORIZONTAL SCALE 1" = 10'	BRIDGE FILE N/A
VERTICAL SCALE 1" = 10'	DESIGNATION 2002538
SURVEY BOOK N/A	SHEETS 71 of 117
CONTRACT R-43470	PROJECT 2002538



DATE	REVISION

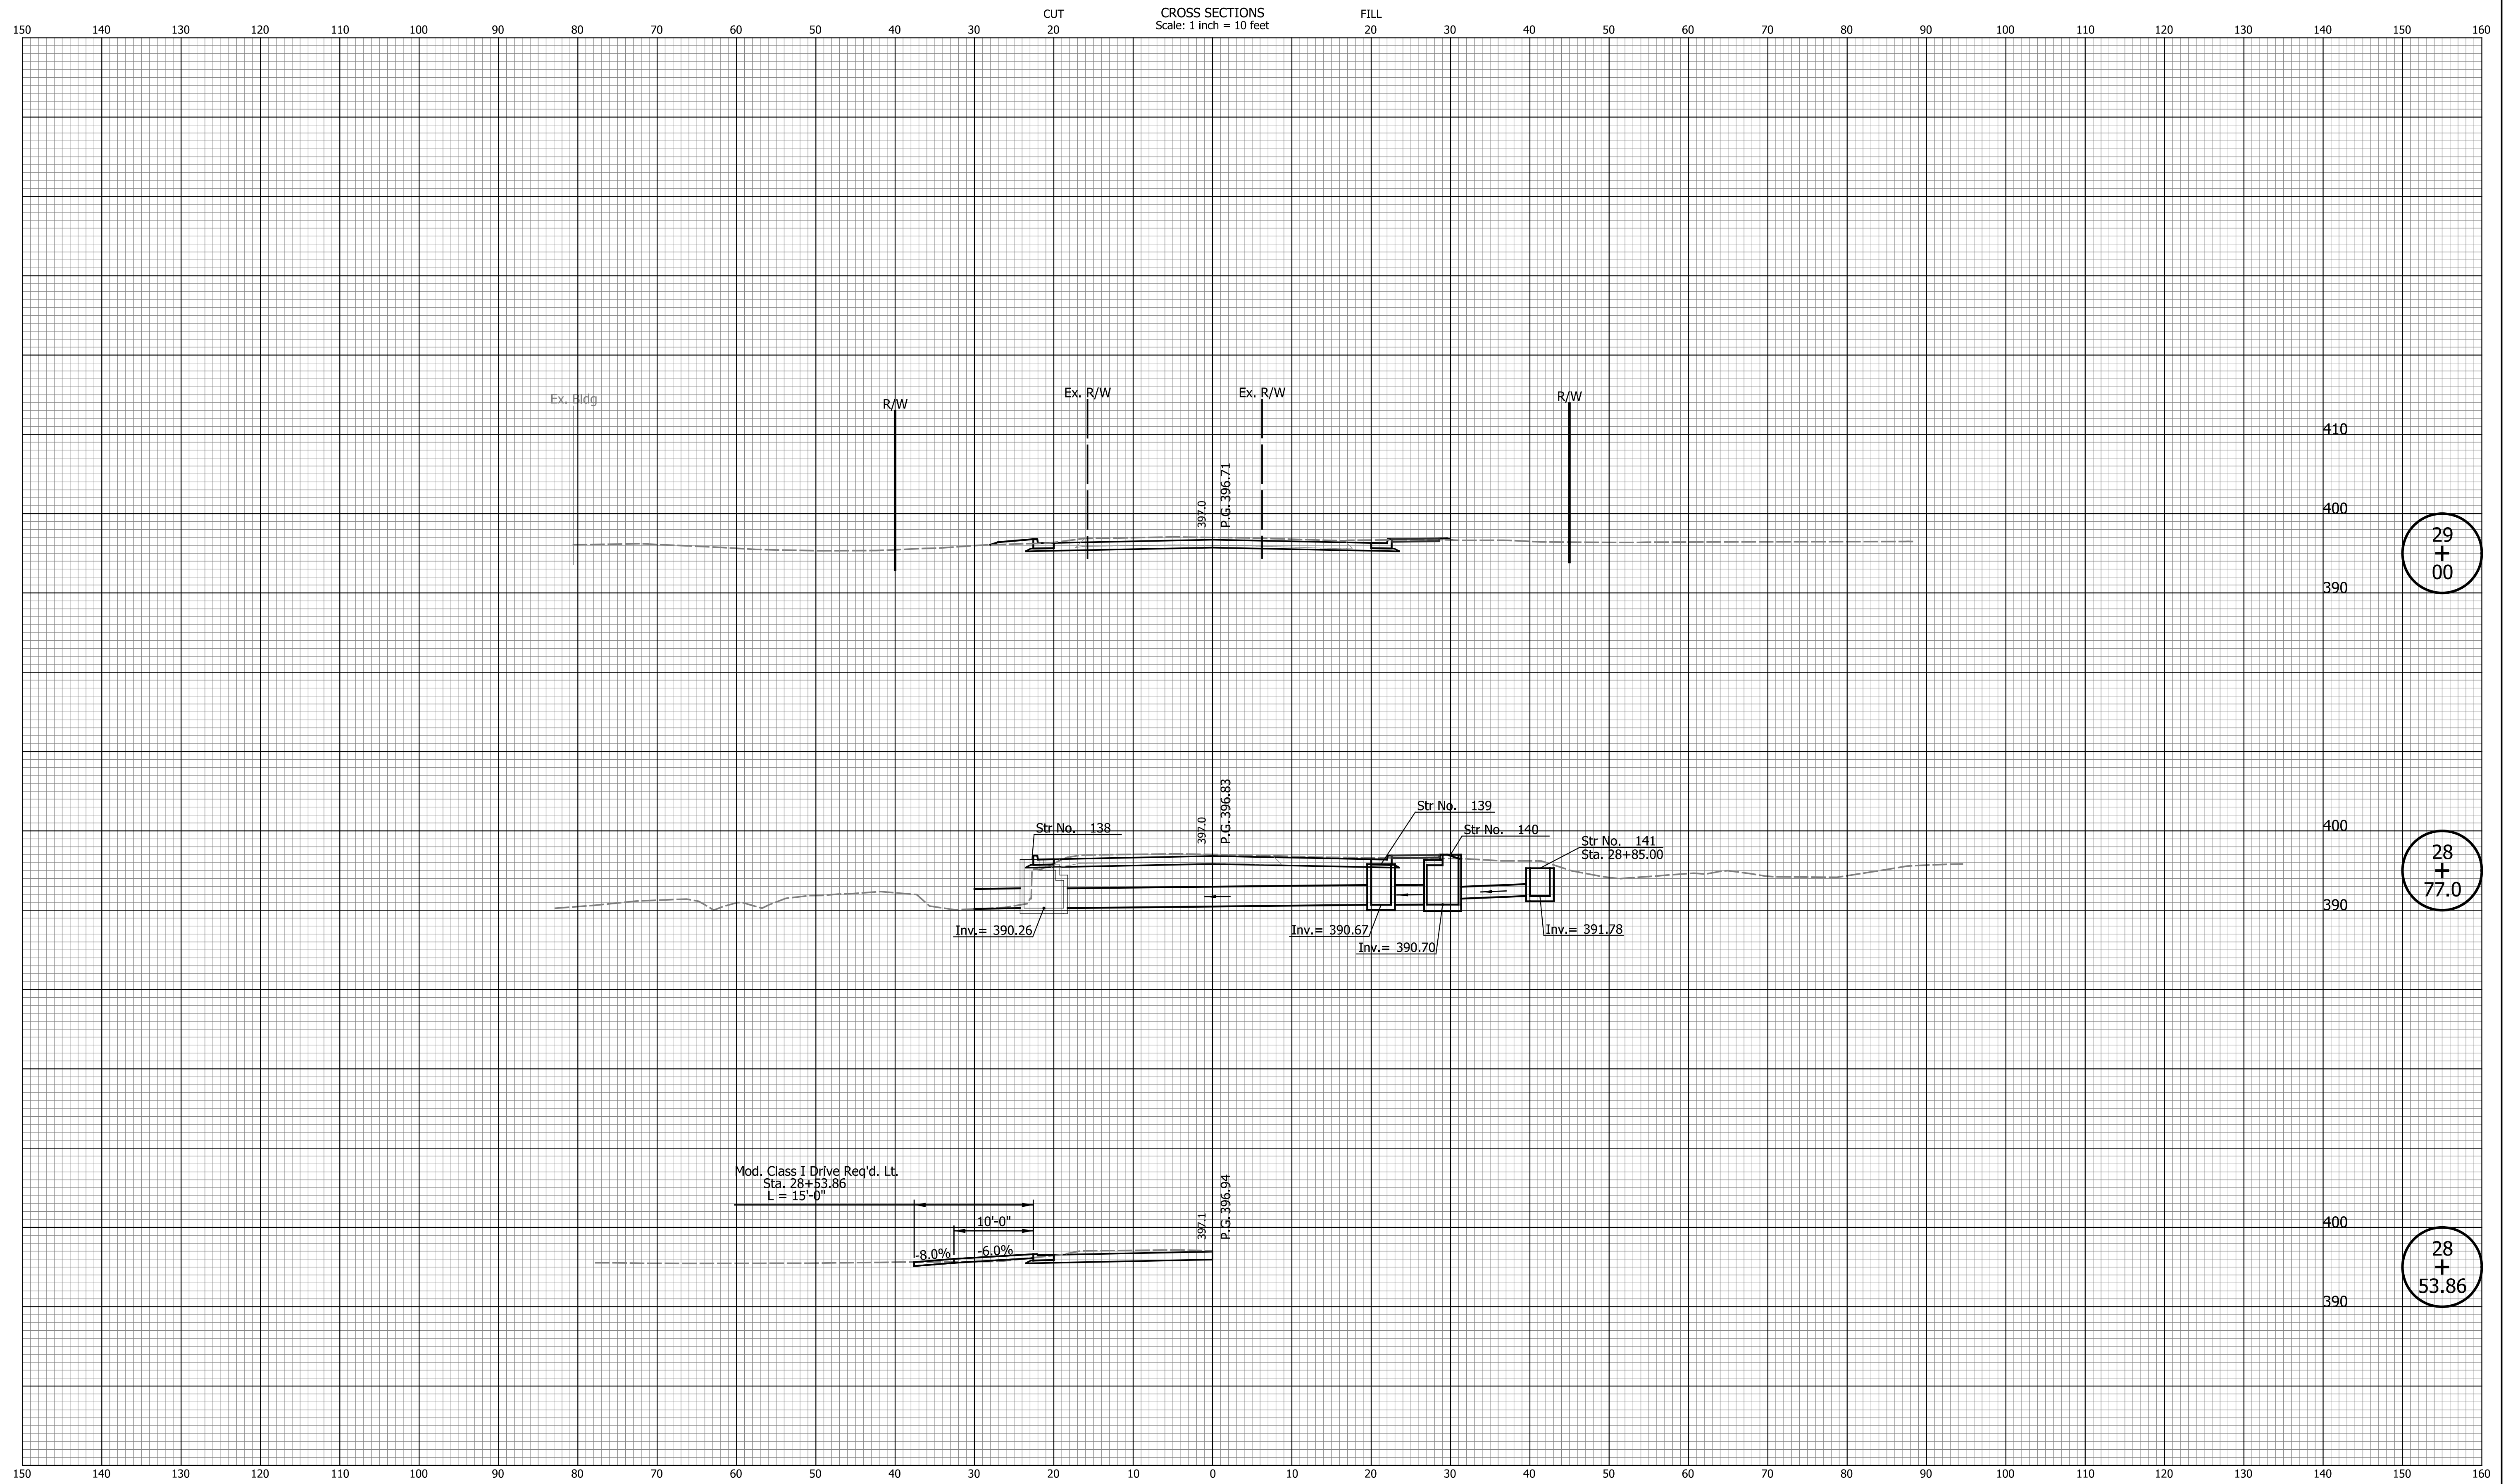
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INDIANA DEPARTMENT OF TRANSPORTATION

CROSS SECTIONS LINE "PR-A"

HORIZONTAL SCALE	BRIDGE FILE
1" = 10'	N/A
VERTICAL SCALE	DESIGNATION
1" = 10'	2002538
SURVEY BOOK	SHEETS
N/A	72 of 117
CONTRACT	PROJECT
R-43470	2002538

Indiana State

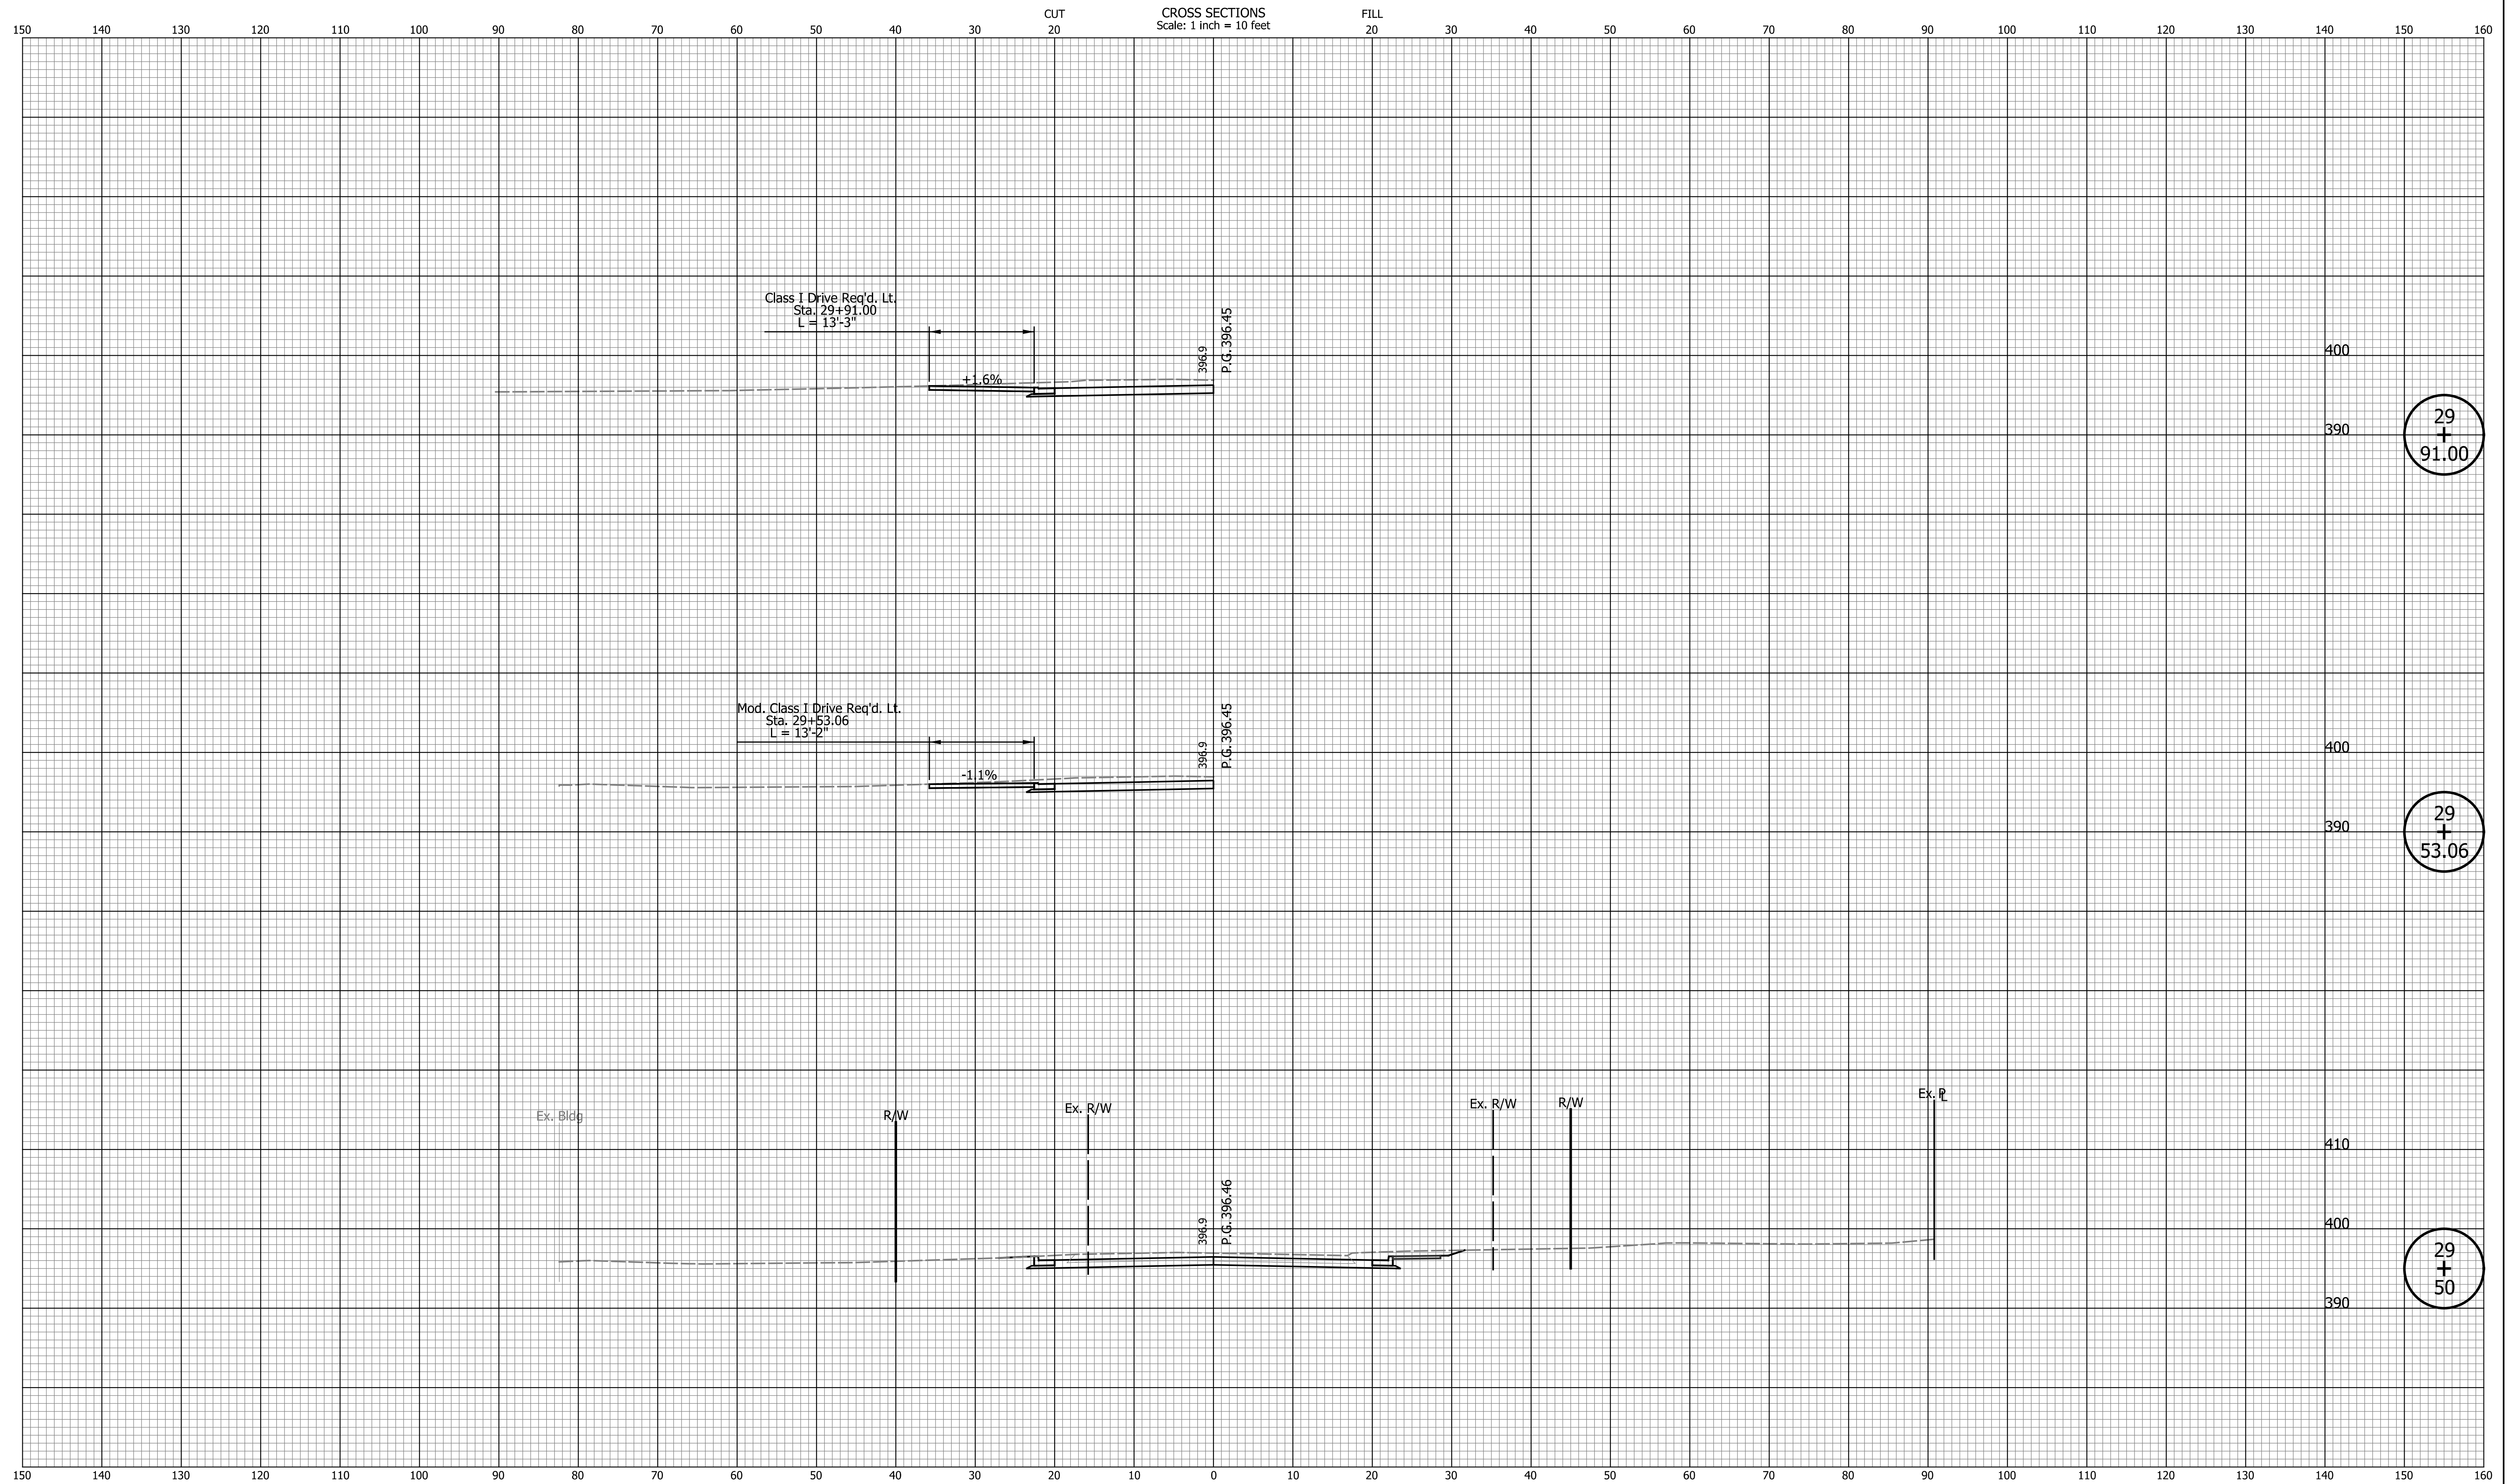

29
+
91.00

29
+
53.06

29
+
50


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INDIANA DEPARTMENT OF TRANSPORTATION

CROSS SECTIONS LINE "PR-A"

HORIZONTAL SCALE	BRIDGE FILE
1" = 10'	N/A
VERTICAL SCALE	DESIGNATION
1" = 10'	2002538
SURVEY BOOK	SHEETS
N/A	73 of 117
CONTRACT	PROJECT
R-43470	2002538



30
+
50

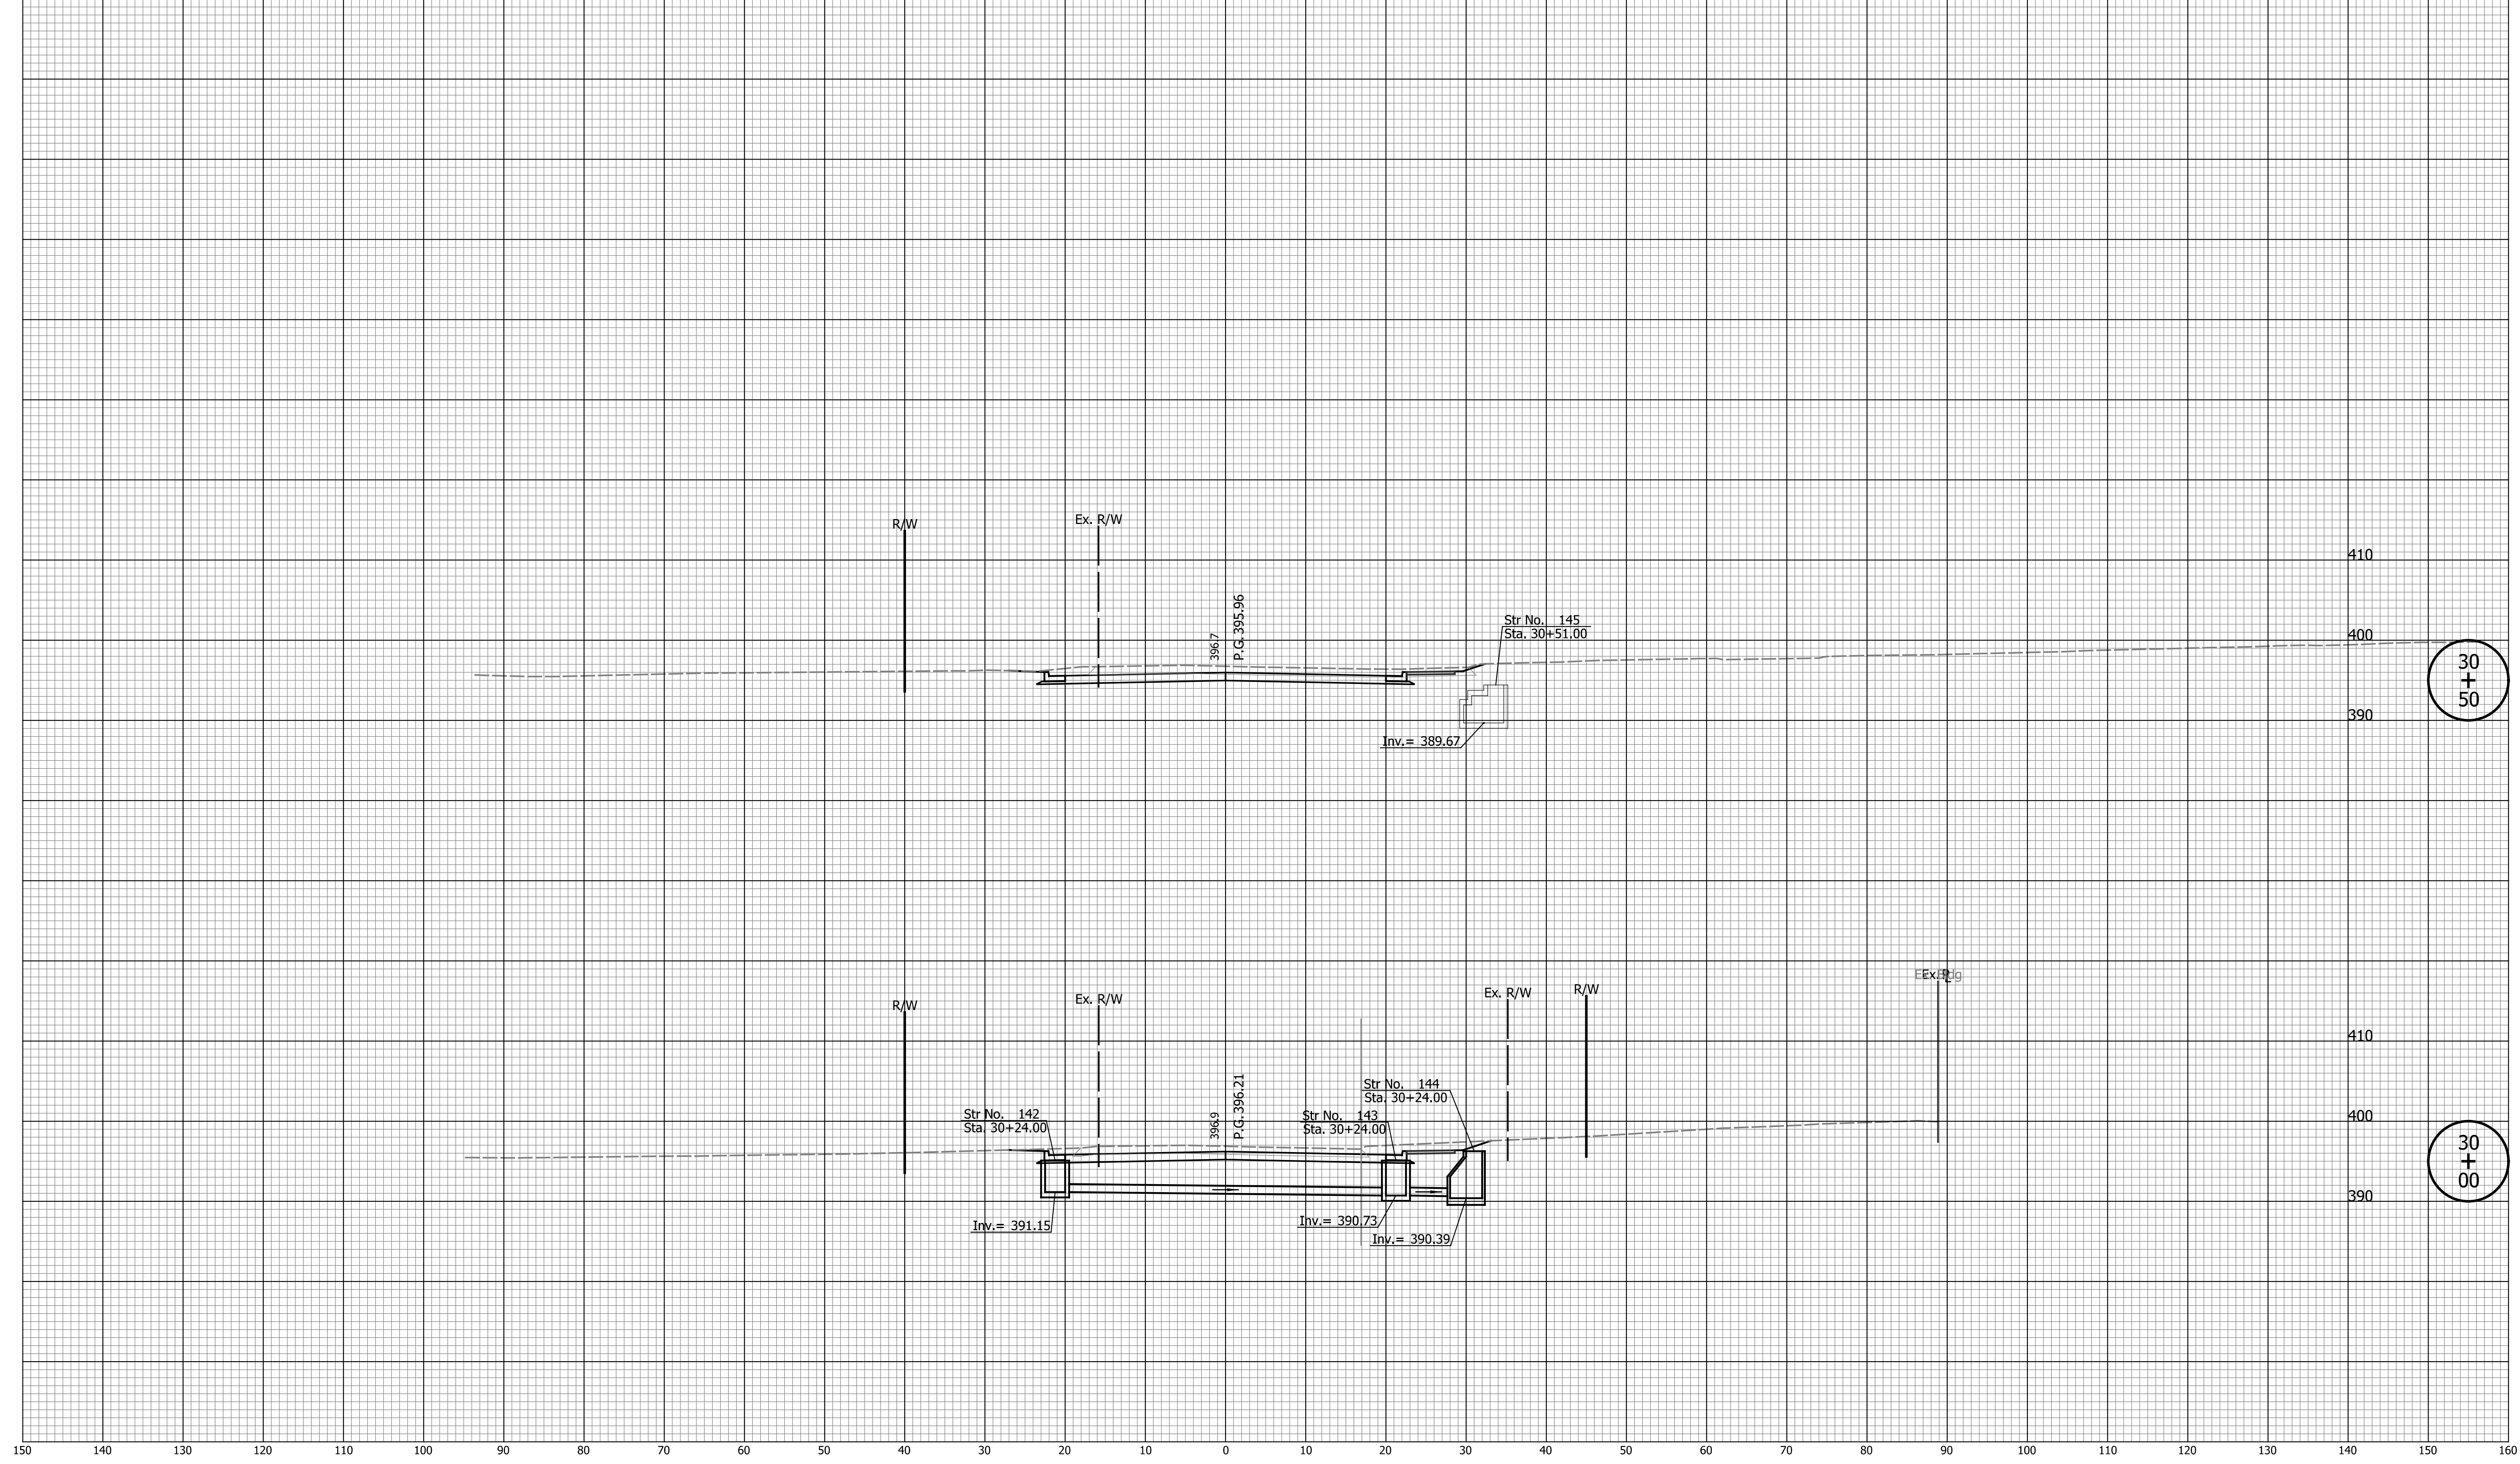30
+
00

DATE	REVISION


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DATE	DATE
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INDIANA DEPARTMENT OF TRANSPORTATION

CROSS SECTIONS LINE "PR-A"

HORIZONTAL SCALE 1" = 10'	BRIDGE FILE N/A
VERTICAL SCALE 1" = 10'	DESIGNATION 2002538
SURVEY BOOK N/A	SHEETS 74 of 117
CONTRACT R-43470	PROJECT 2002538



CROSS SECTIONS
Scale: 1 inch = 10 feet

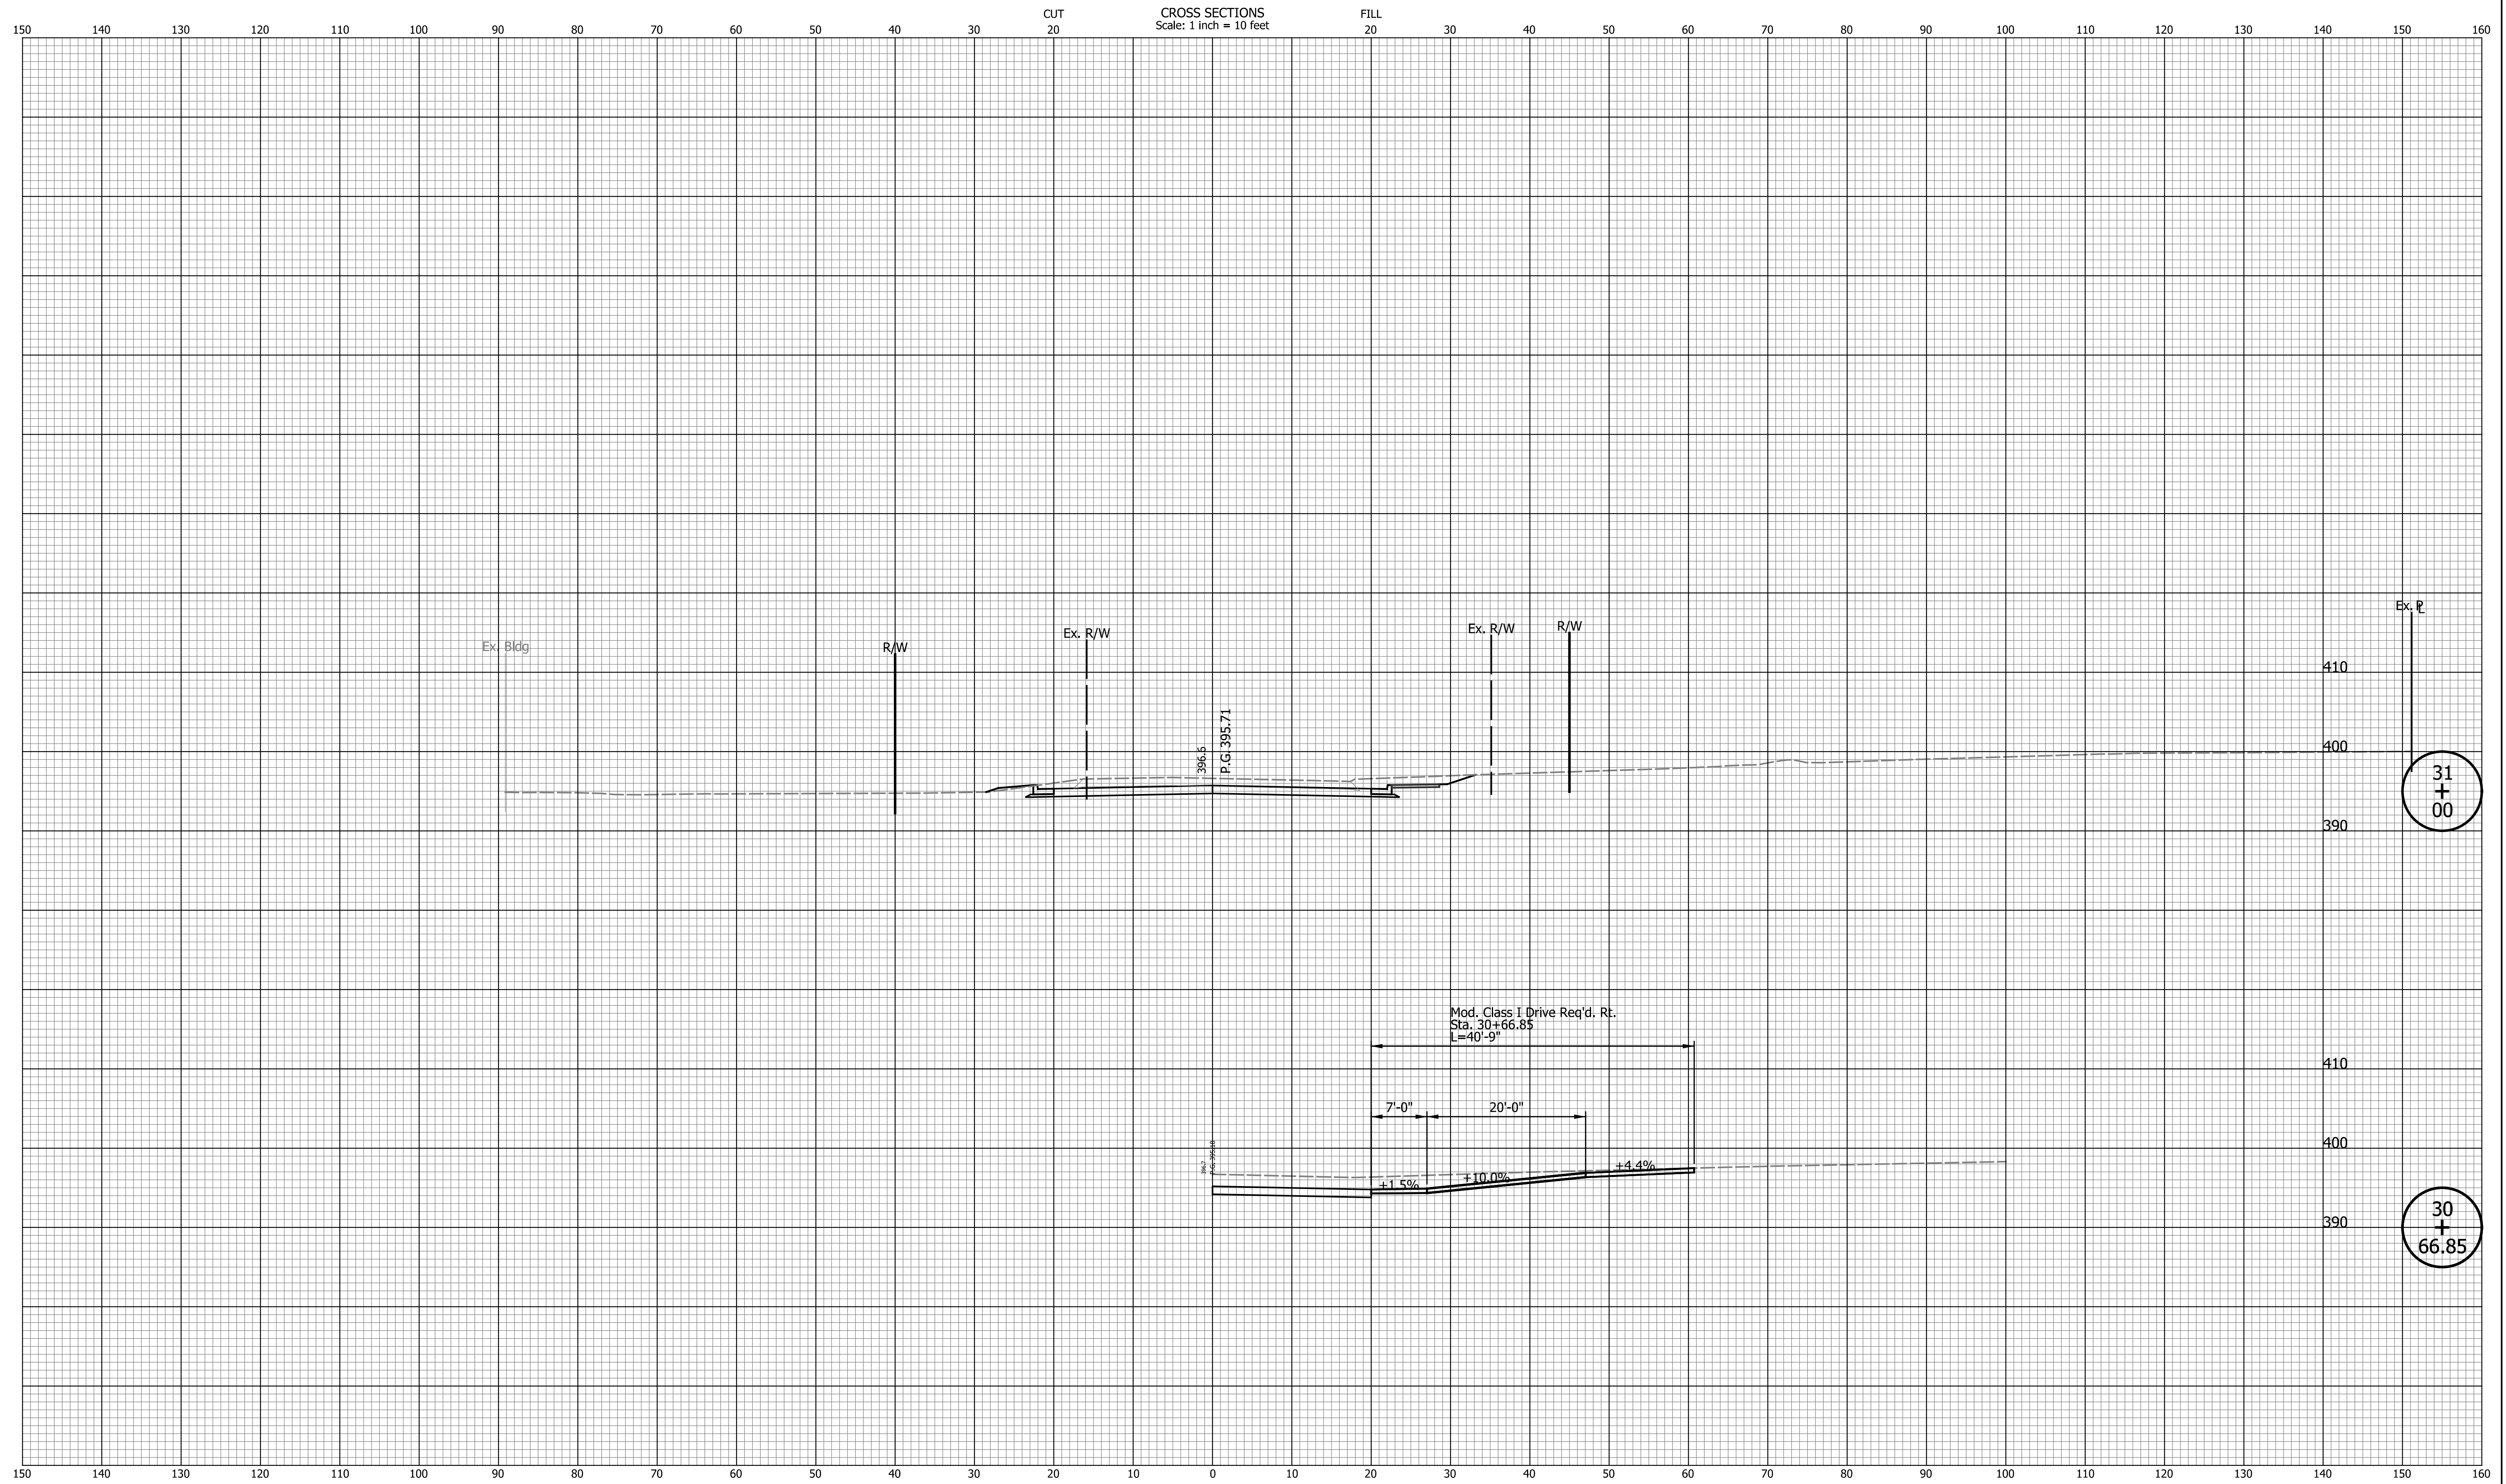CUT
20

FILL
20

DATE	REVISION


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DESIGNED: _____ JAB _____	DRAWN: _____ EAK _____	
CHECKED: _____ TMS _____	CHECKED: _____ TMS _____	

INDIANA DEPARTMENT OF TRANSPORTATION

CROSS SECTIONS LINE "PR-A"

HORIZONTAL SCALE 1" = 10'	BRIDGE FILE N/A
VERTICAL SCALE 1" = 10'	DESIGNATION 2002538
SURVEY BOOK N/A	SHEETS 75 of 117
CONTRACT R-43470	PROJECT 2002538

Indiana State

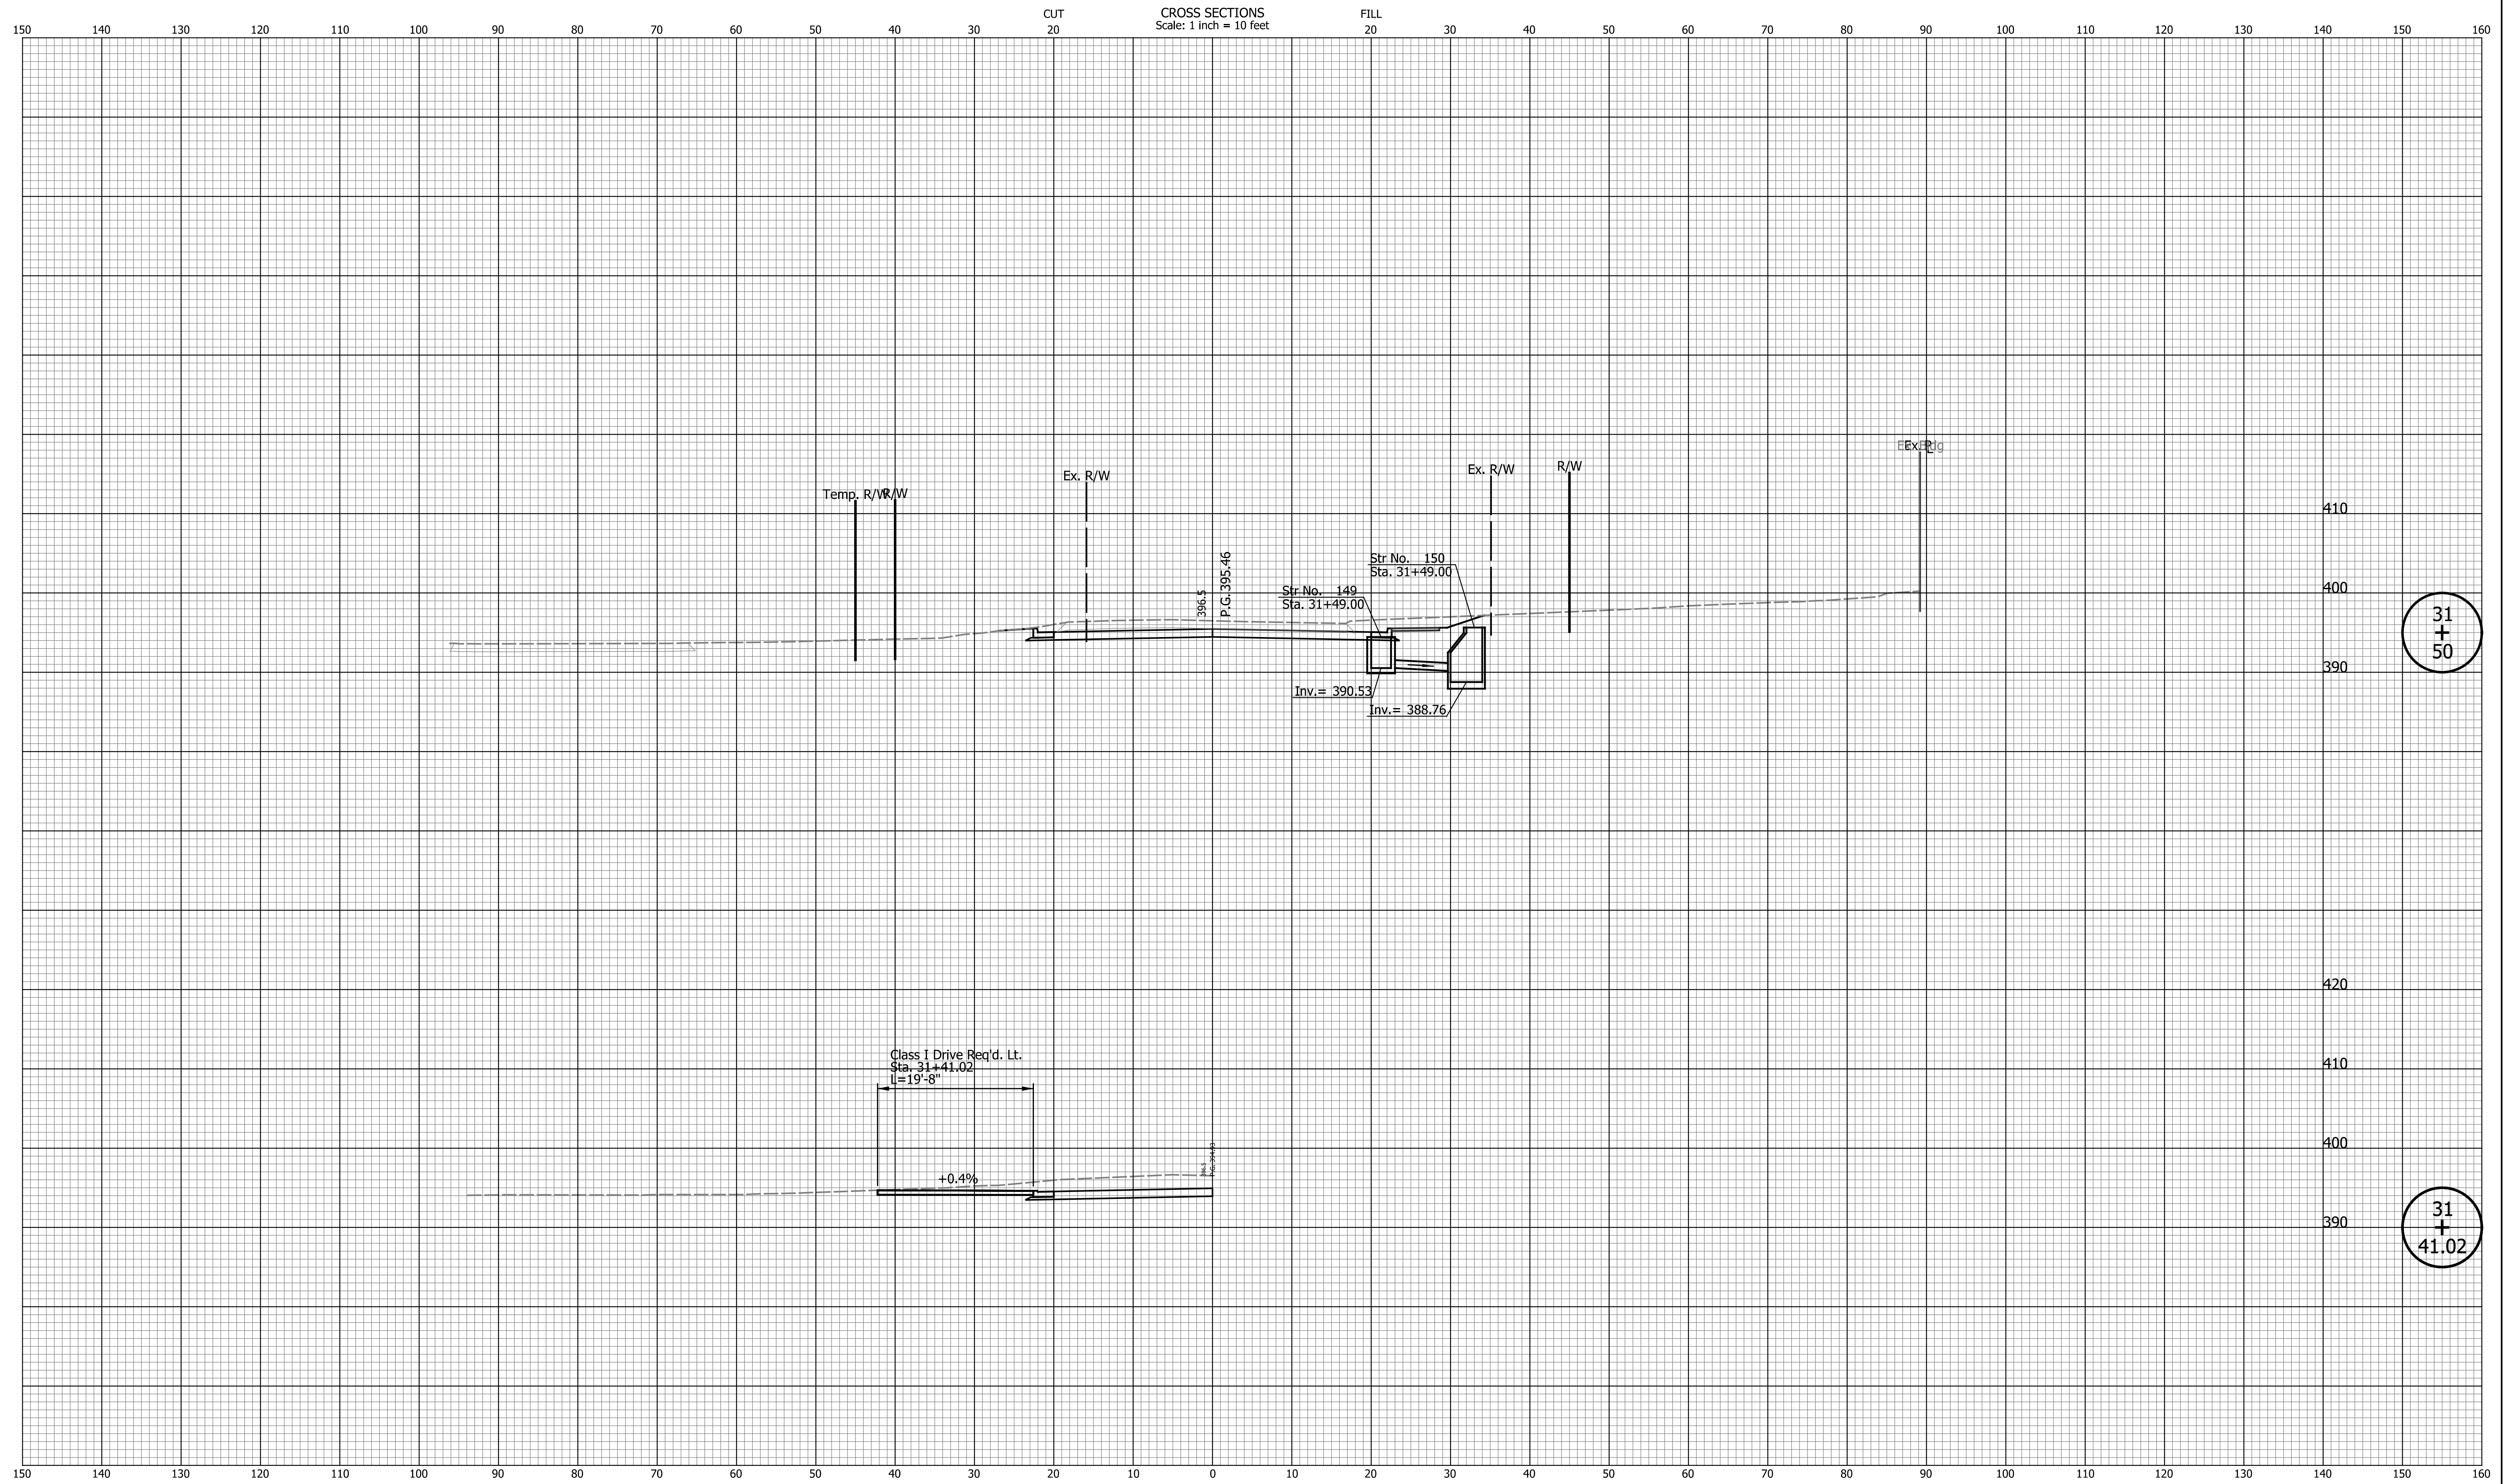

DATE	REVISION


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DESIGNED: JAB	DRAWN: EAK	
CHECKED: TMS	CHECKED: TMS	

INDIANA DEPARTMENT OF TRANSPORTATION

CROSS SECTIONS LINE "PR-A"

HORIZONTAL SCALE	BRIDGE FILE
1" = 10'	N/A
VERTICAL SCALE	DESIGNATION
1" = 10'	2002538
SURVEY BOOK	SHEETS
N/A	76 of 117
CONTRACT	PROJECT
R-43470	2002538

Indiana State

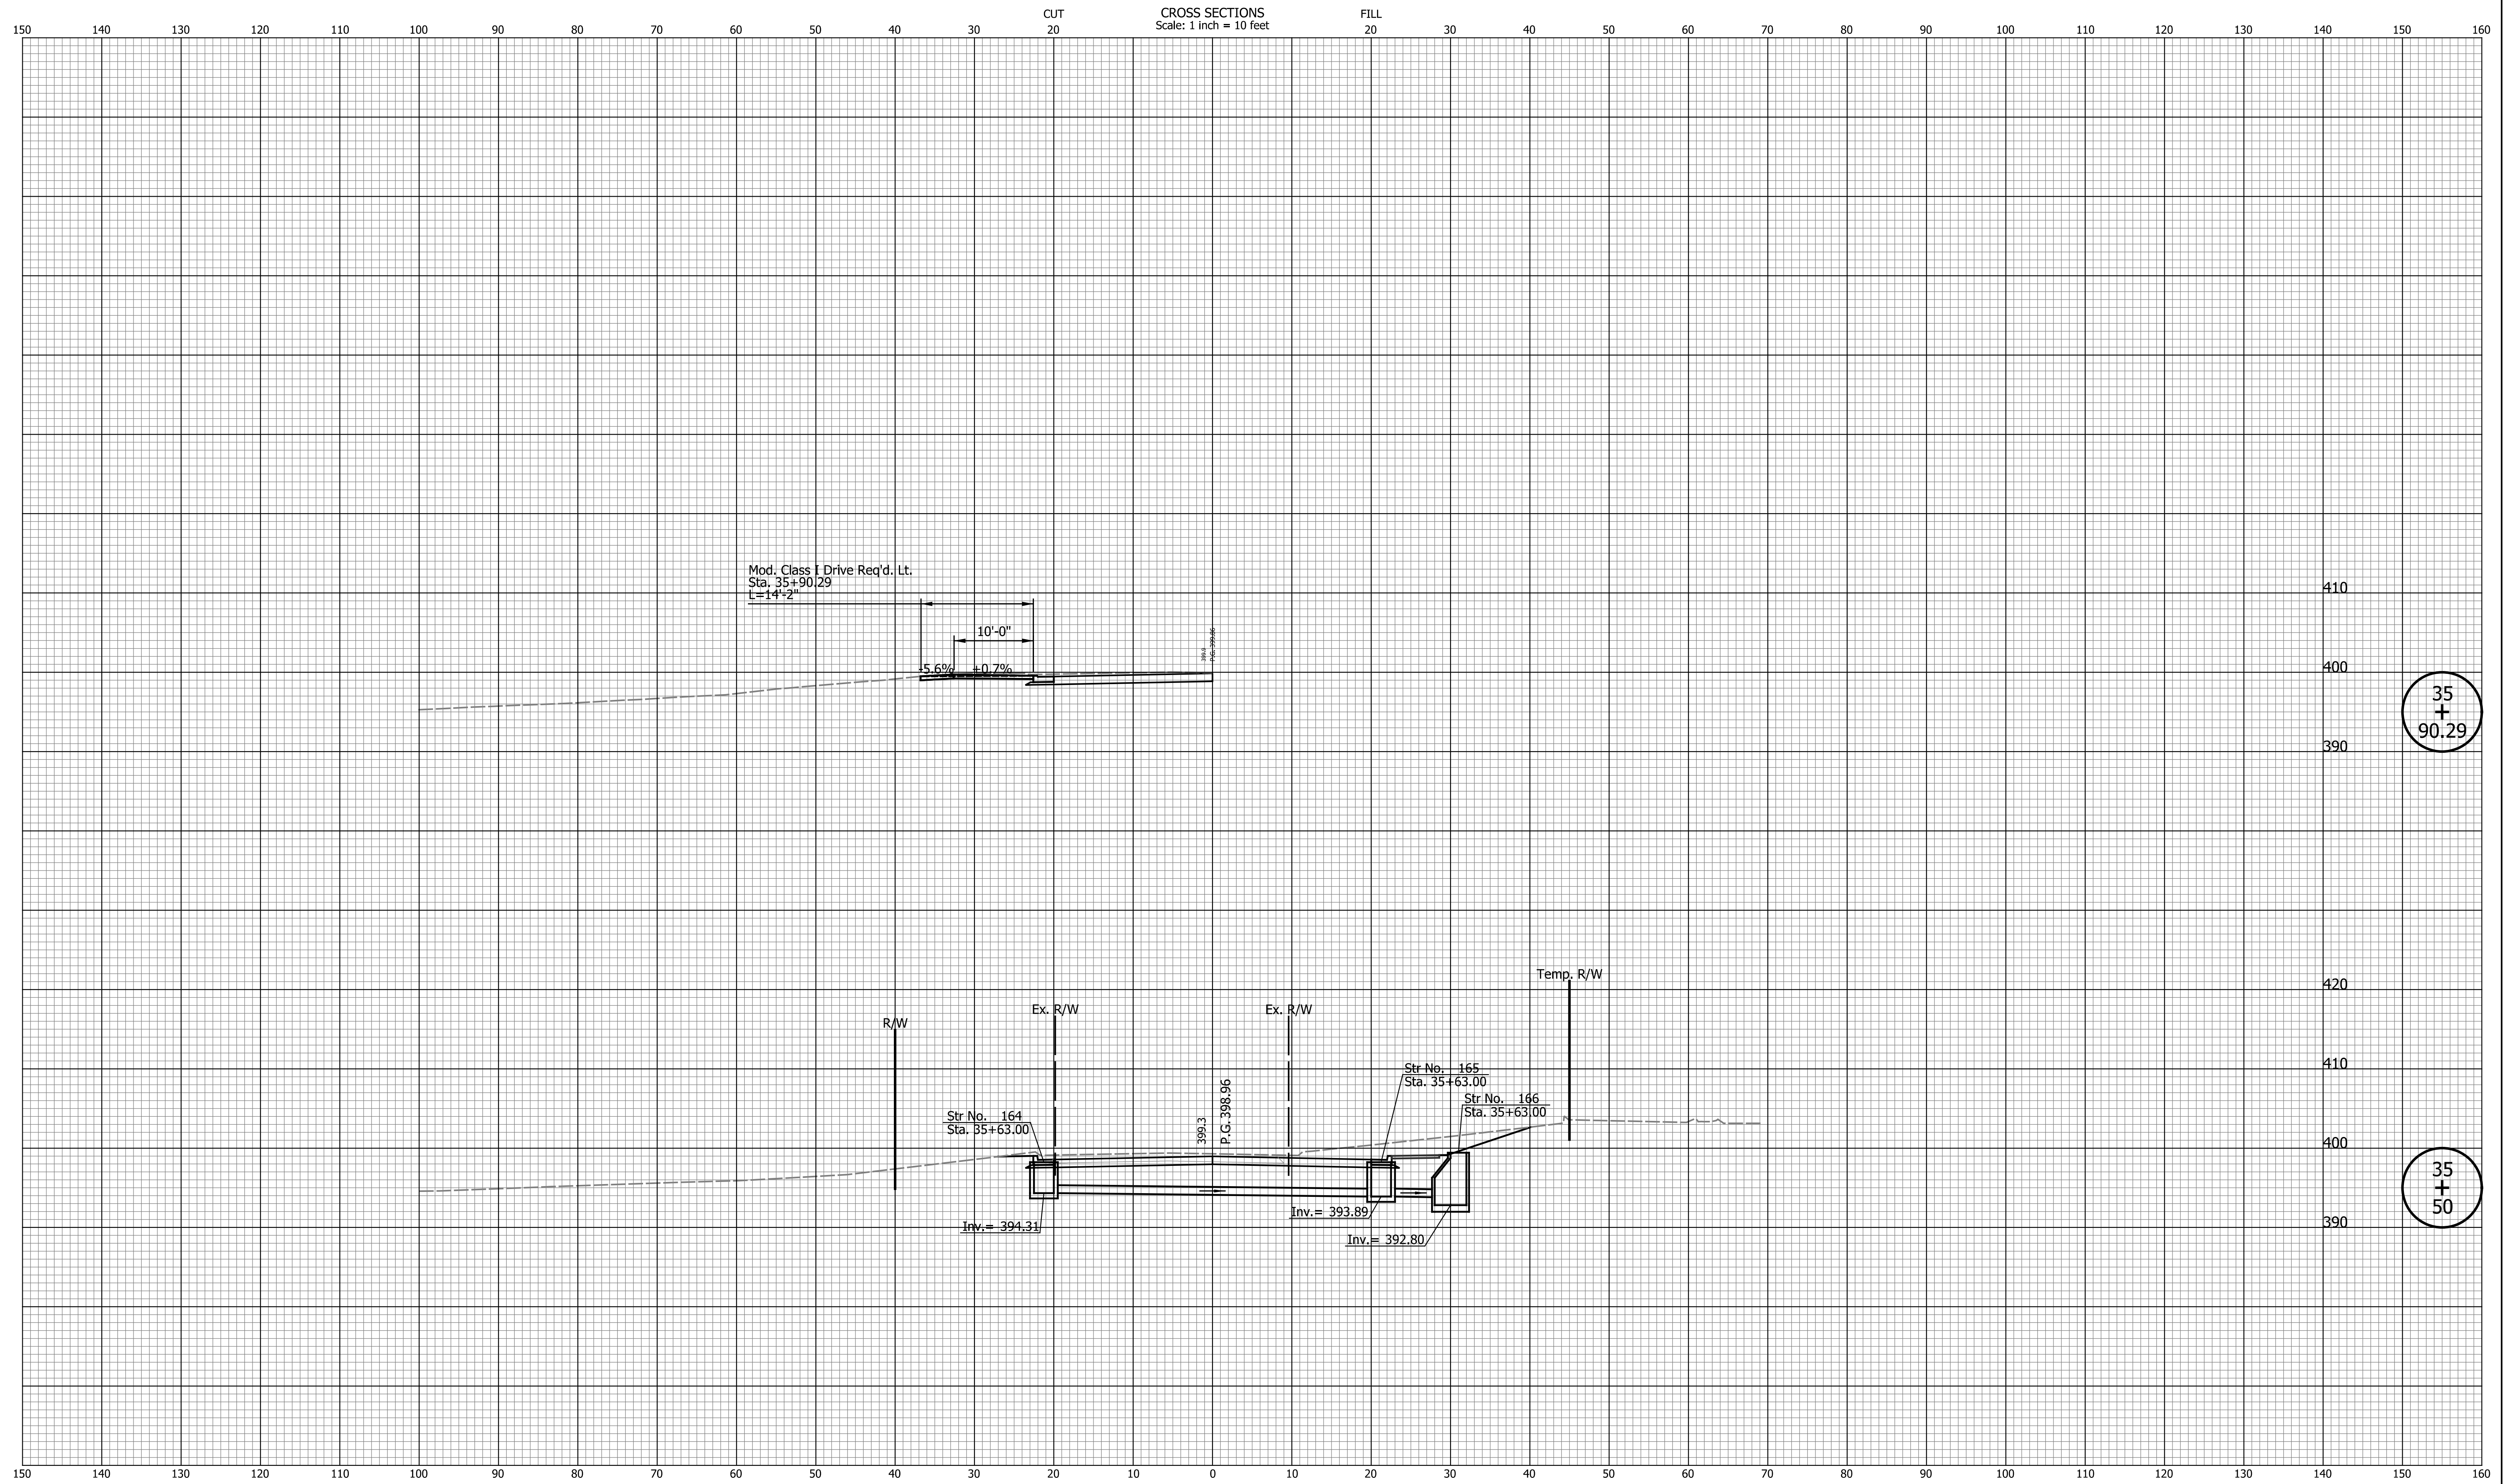


DATE	REVISION

RECOMMENDED FOR APPROVAL	DESIGN ENGINEER	DATE
DESIGNED: JAB	DRAWN: EAK	
CHECKED: TMS	CHECKED: TMS	

INDIANA DEPARTMENT OF TRANSPORTATION

CROSS SECTIONS LINE "PR-A"

HORIZONTAL SCALE	BRIDGE FILE
1" = 10'	N/A
VERTICAL SCALE	DESIGNATION
1" = 10'	2002538
SURVEY BOOK	SHEETS
N/A	81 of 117
CONTRACT	PROJECT
R-43470	2002538

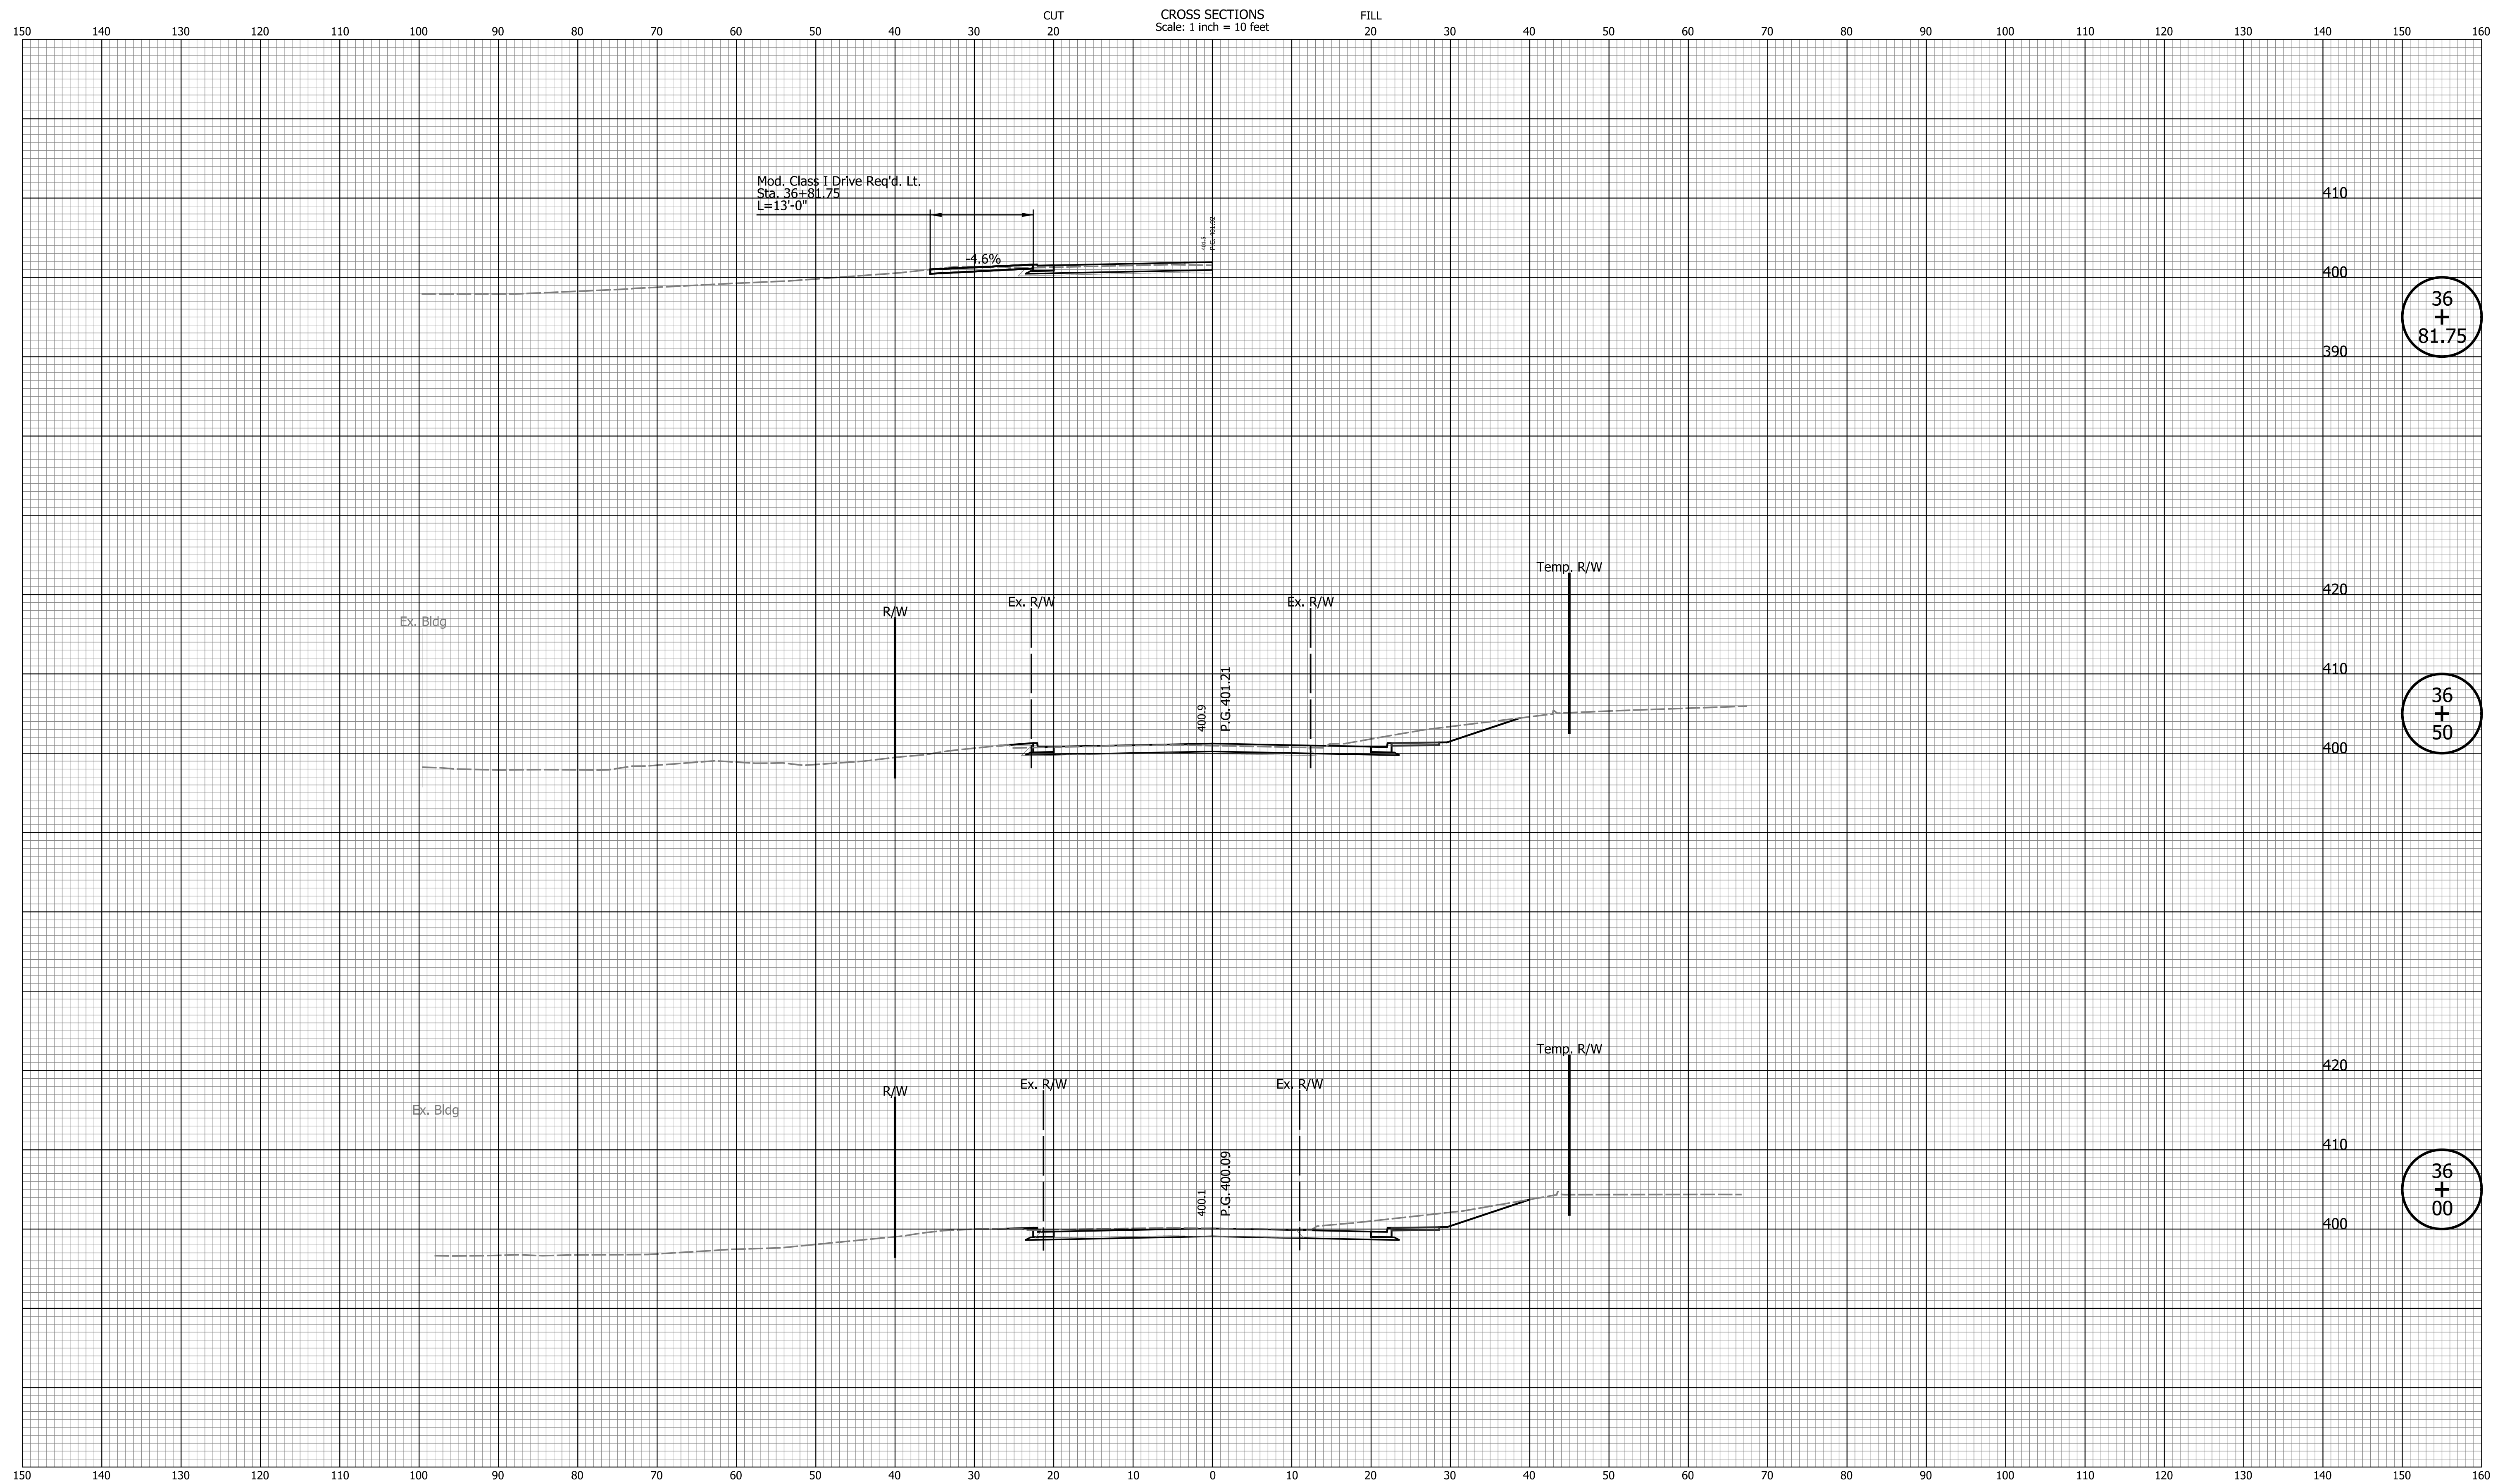

36
+
81.75

36
+
50

36
+
00

DATE	REVISION


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DESIGNED: JAB	DRAWN: EAK	
CHECKED: TMS	CHECKED: TMS	

INDIANA DEPARTMENT OF TRANSPORTATION

CROSS SECTIONS LINE "PR-A"

HORIZONTAL SCALE	BRIDGE FILE
1" = 10'	N/A
VERTICAL SCALE	DESIGNATION
1" = 10'	2002538
SURVEY BOOK	SHEETS
N/A	82 of 117
CONTRACT	PROJECT
R-43470	2002538

Indiana State

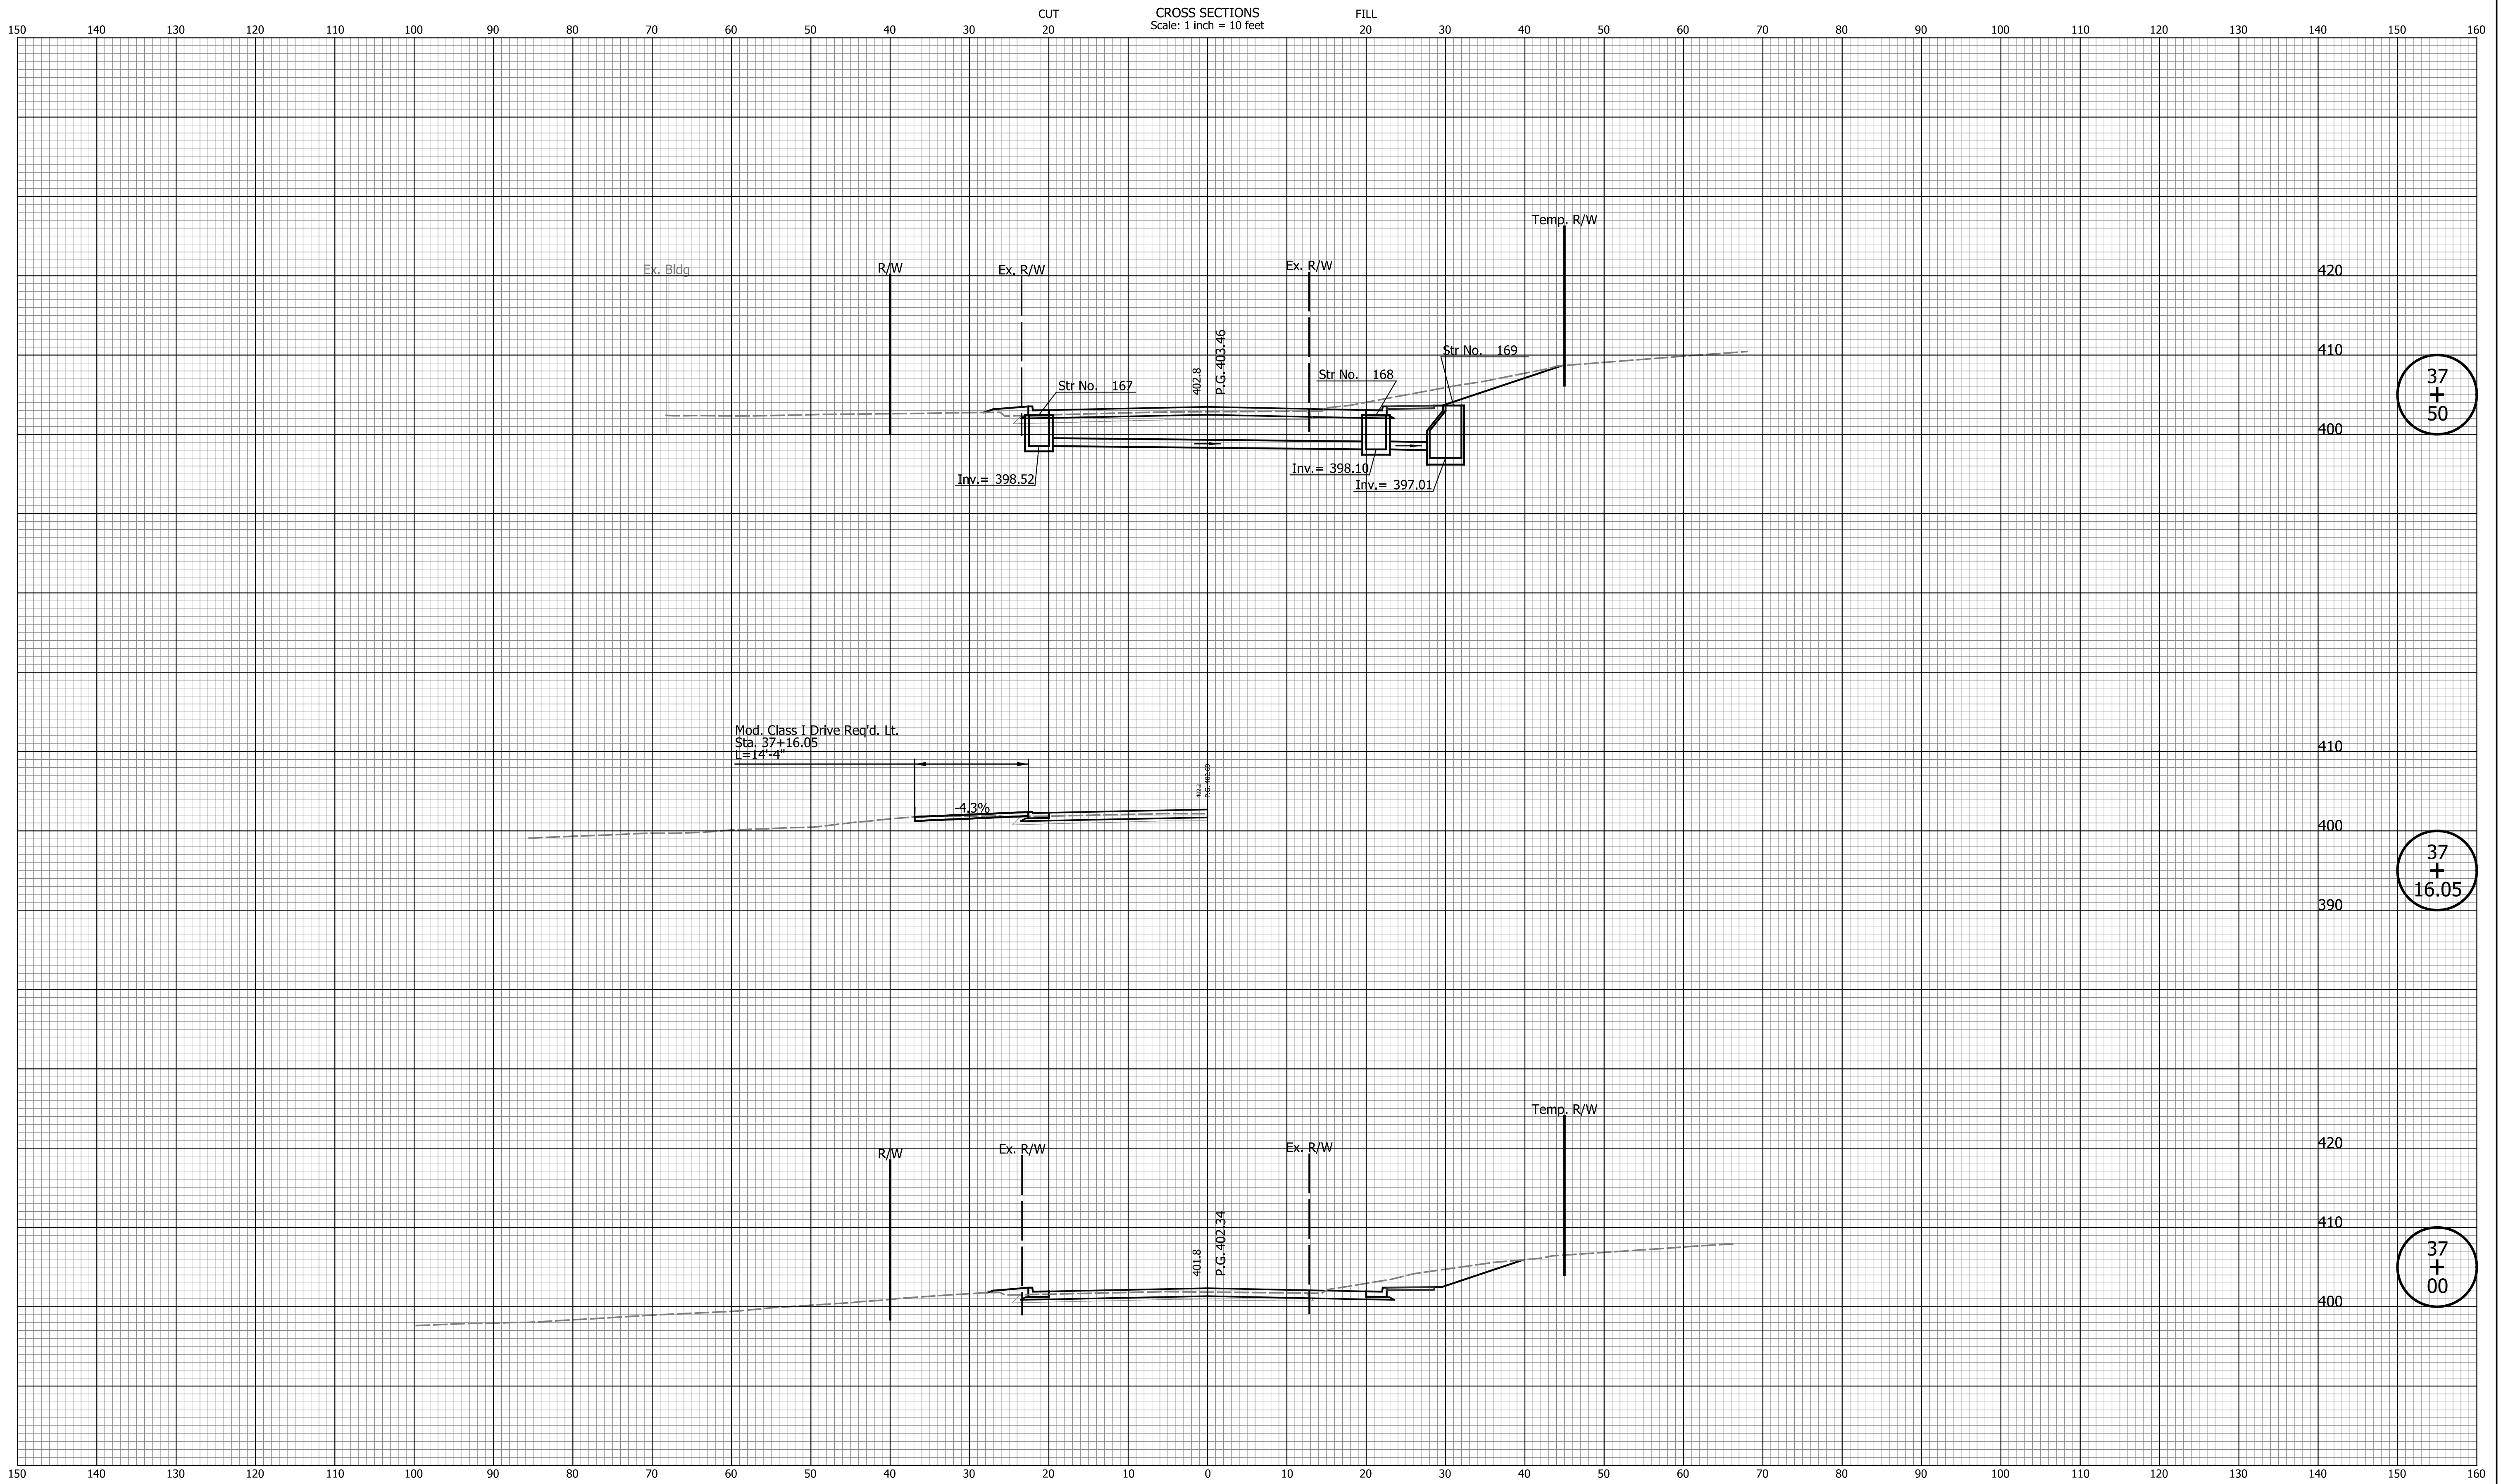

DATE	REVISION


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INDIANA DEPARTMENT OF TRANSPORTATION

CROSS SECTIONS LINE "PR-A"

HORIZONTAL SCALE	BRIDGE FILE
1" = 10'	N/A
VERTICAL SCALE	DESIGNATION
1" = 10'	2002538
SURVEY BOOK	SHEETS
N/A	83 of 117
CONTRACT	PROJECT
R-43470	2002538

Indiana State

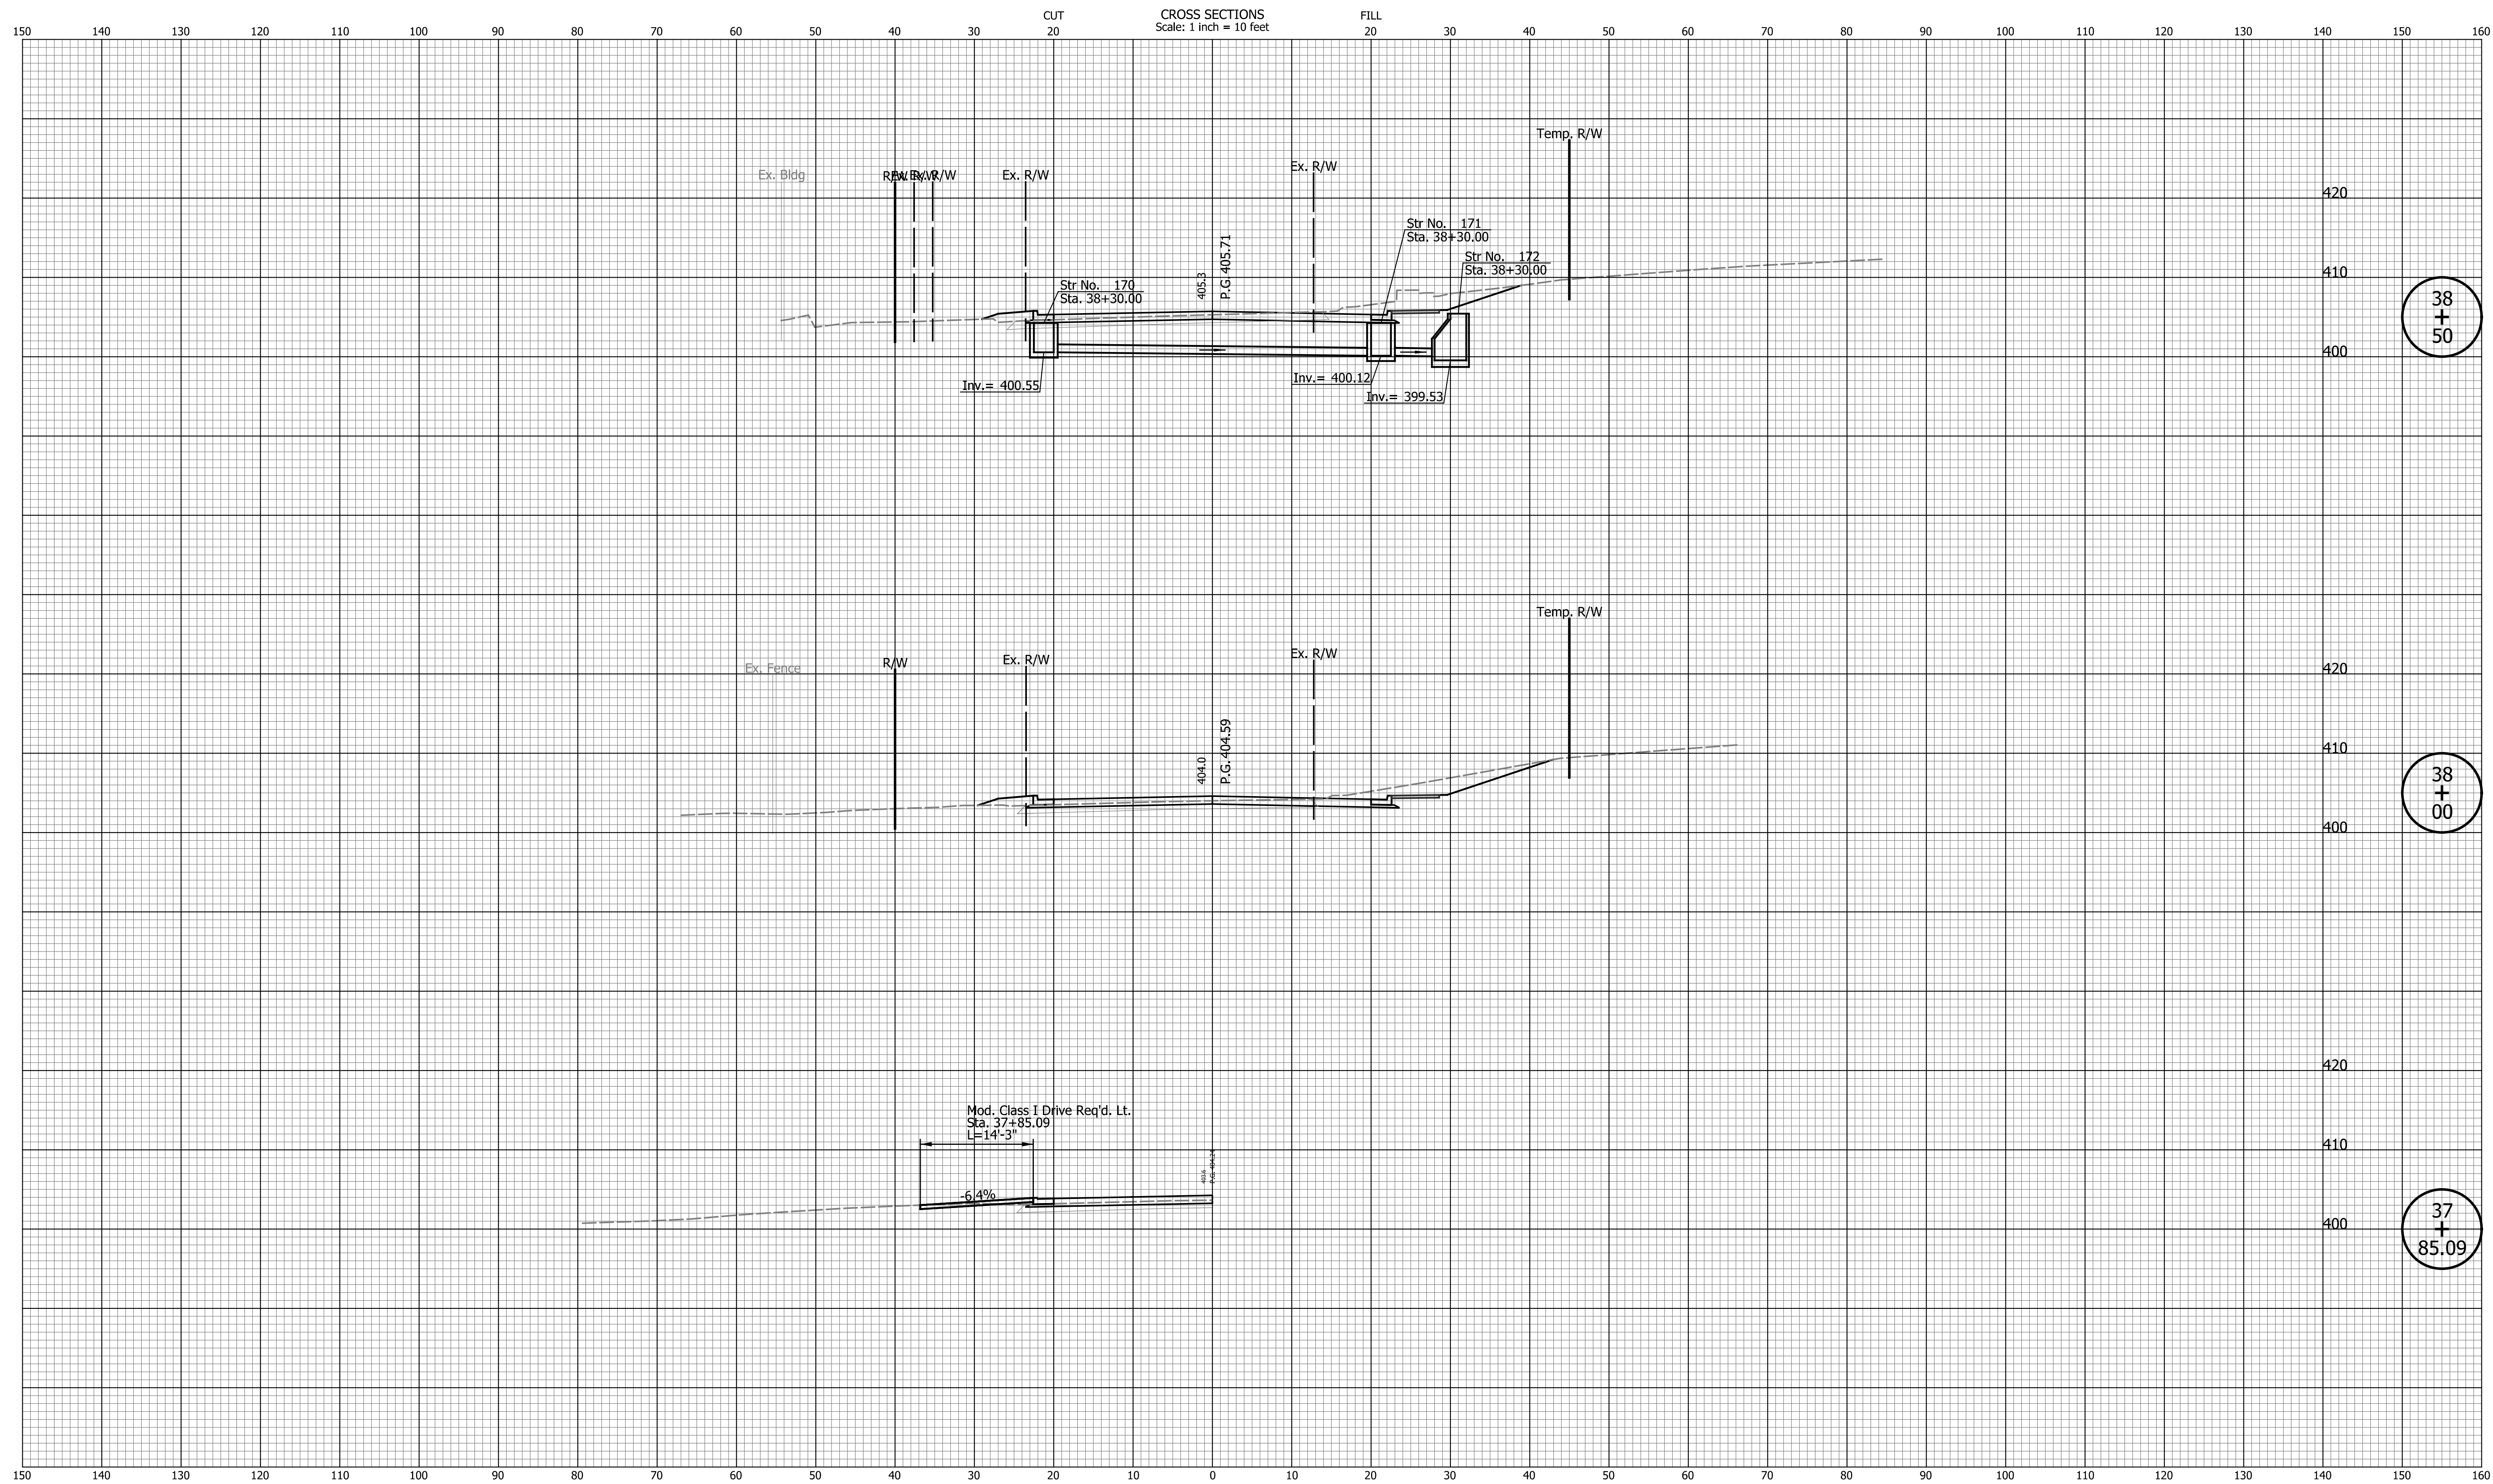

38
+
50

38
+
00

37
+
85.09


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DESIGNED: JAB	DRAWN: EAK	
CHECKED: TMS	CHECKED: TMS	

**INDIANA DEPARTMENT
OF TRANSPORTATION**

**CROSS SECTIONS
LINE "PR-A"**

HORIZONTAL SCALE 1" = 10'	BRIDGE FILE N/A
VERTICAL SCALE 1" = 10'	DESIGNATION 2002538
SURVEY BOOK N/A	SHEETS 84 of 117
CONTRACT R-43470	PROJECT 2002538

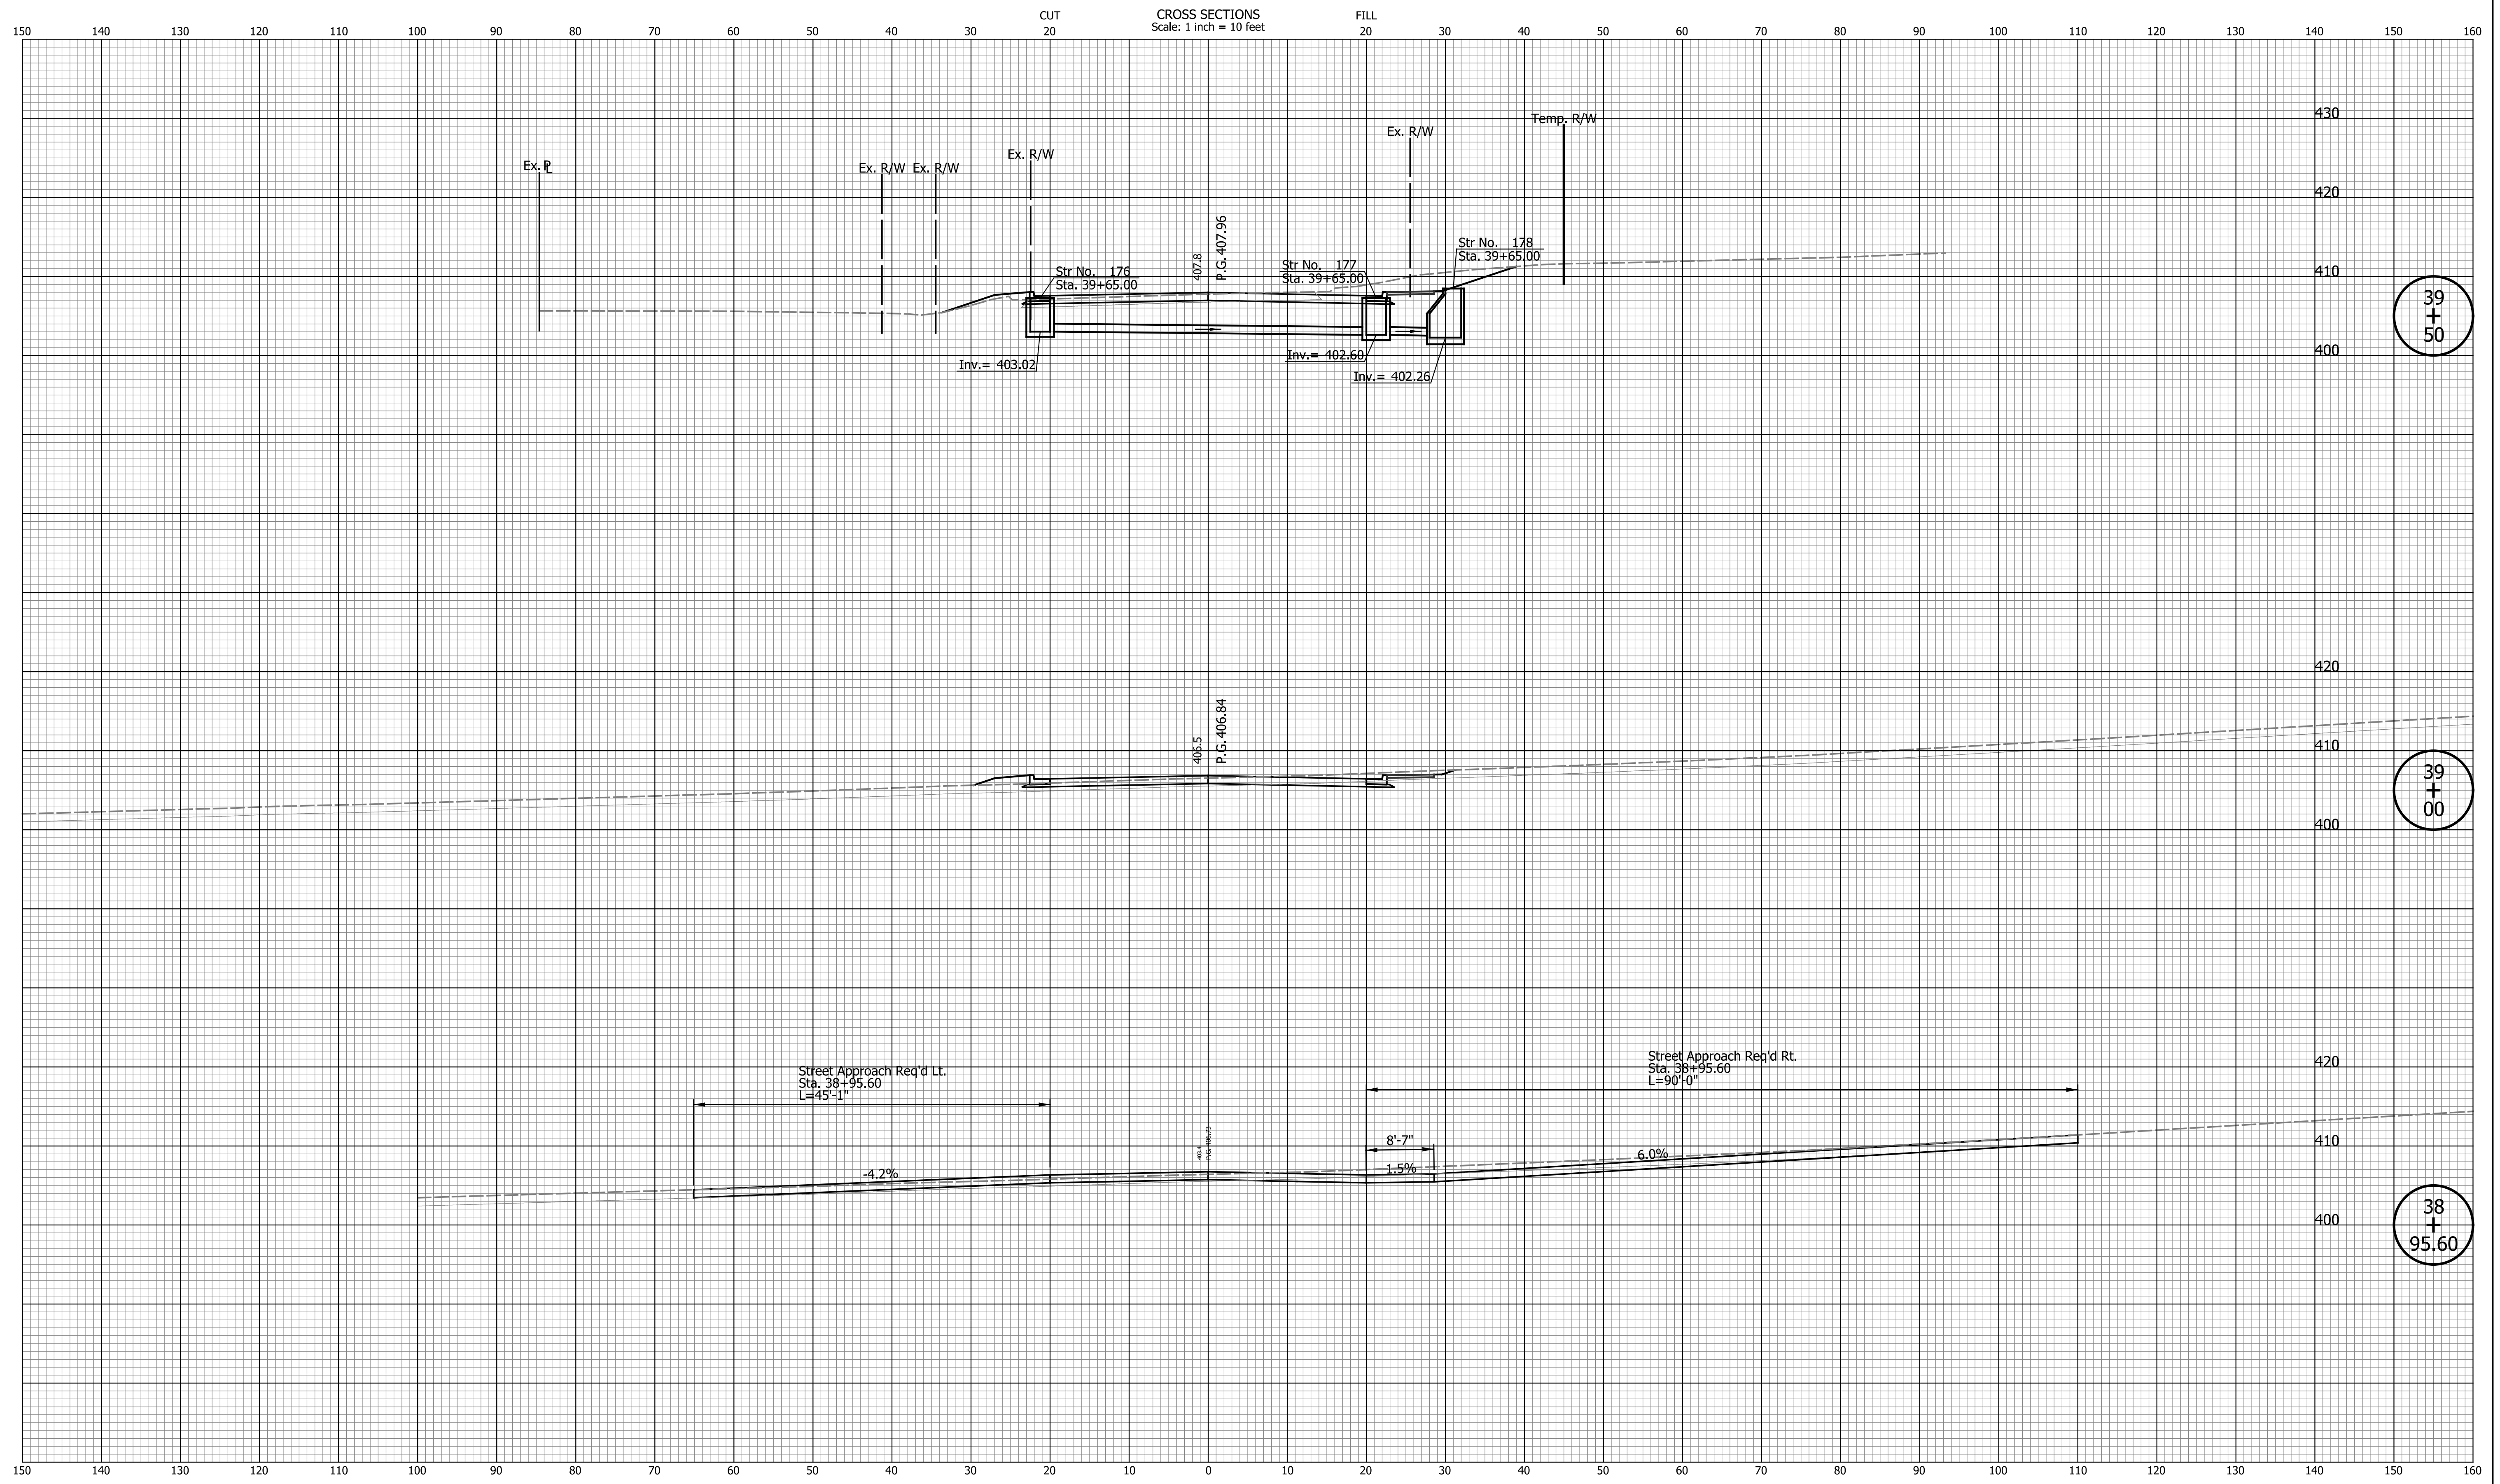

39
+
50

39
+
00

38
+
95.60


DATE	REVISION

RECOMMENDED FOR APPROVAL	DESIGN ENGINEER	DATE
DESIGNED: JAB	DRAWN: EAK	
CHECKED: TMS	CHECKED: TMS	

INDIANA DEPARTMENT OF TRANSPORTATION

CROSS SECTIONS LINE "PR-A"

HORIZONTAL SCALE	BRIDGE FILE
1" = 10'	N/A
VERTICAL SCALE	DESIGNATION
1" = 10'	2002538
SURVEY BOOK	SHEETS
N/A	85 of 117
CONTRACT	PROJECT
R-43470	2002538

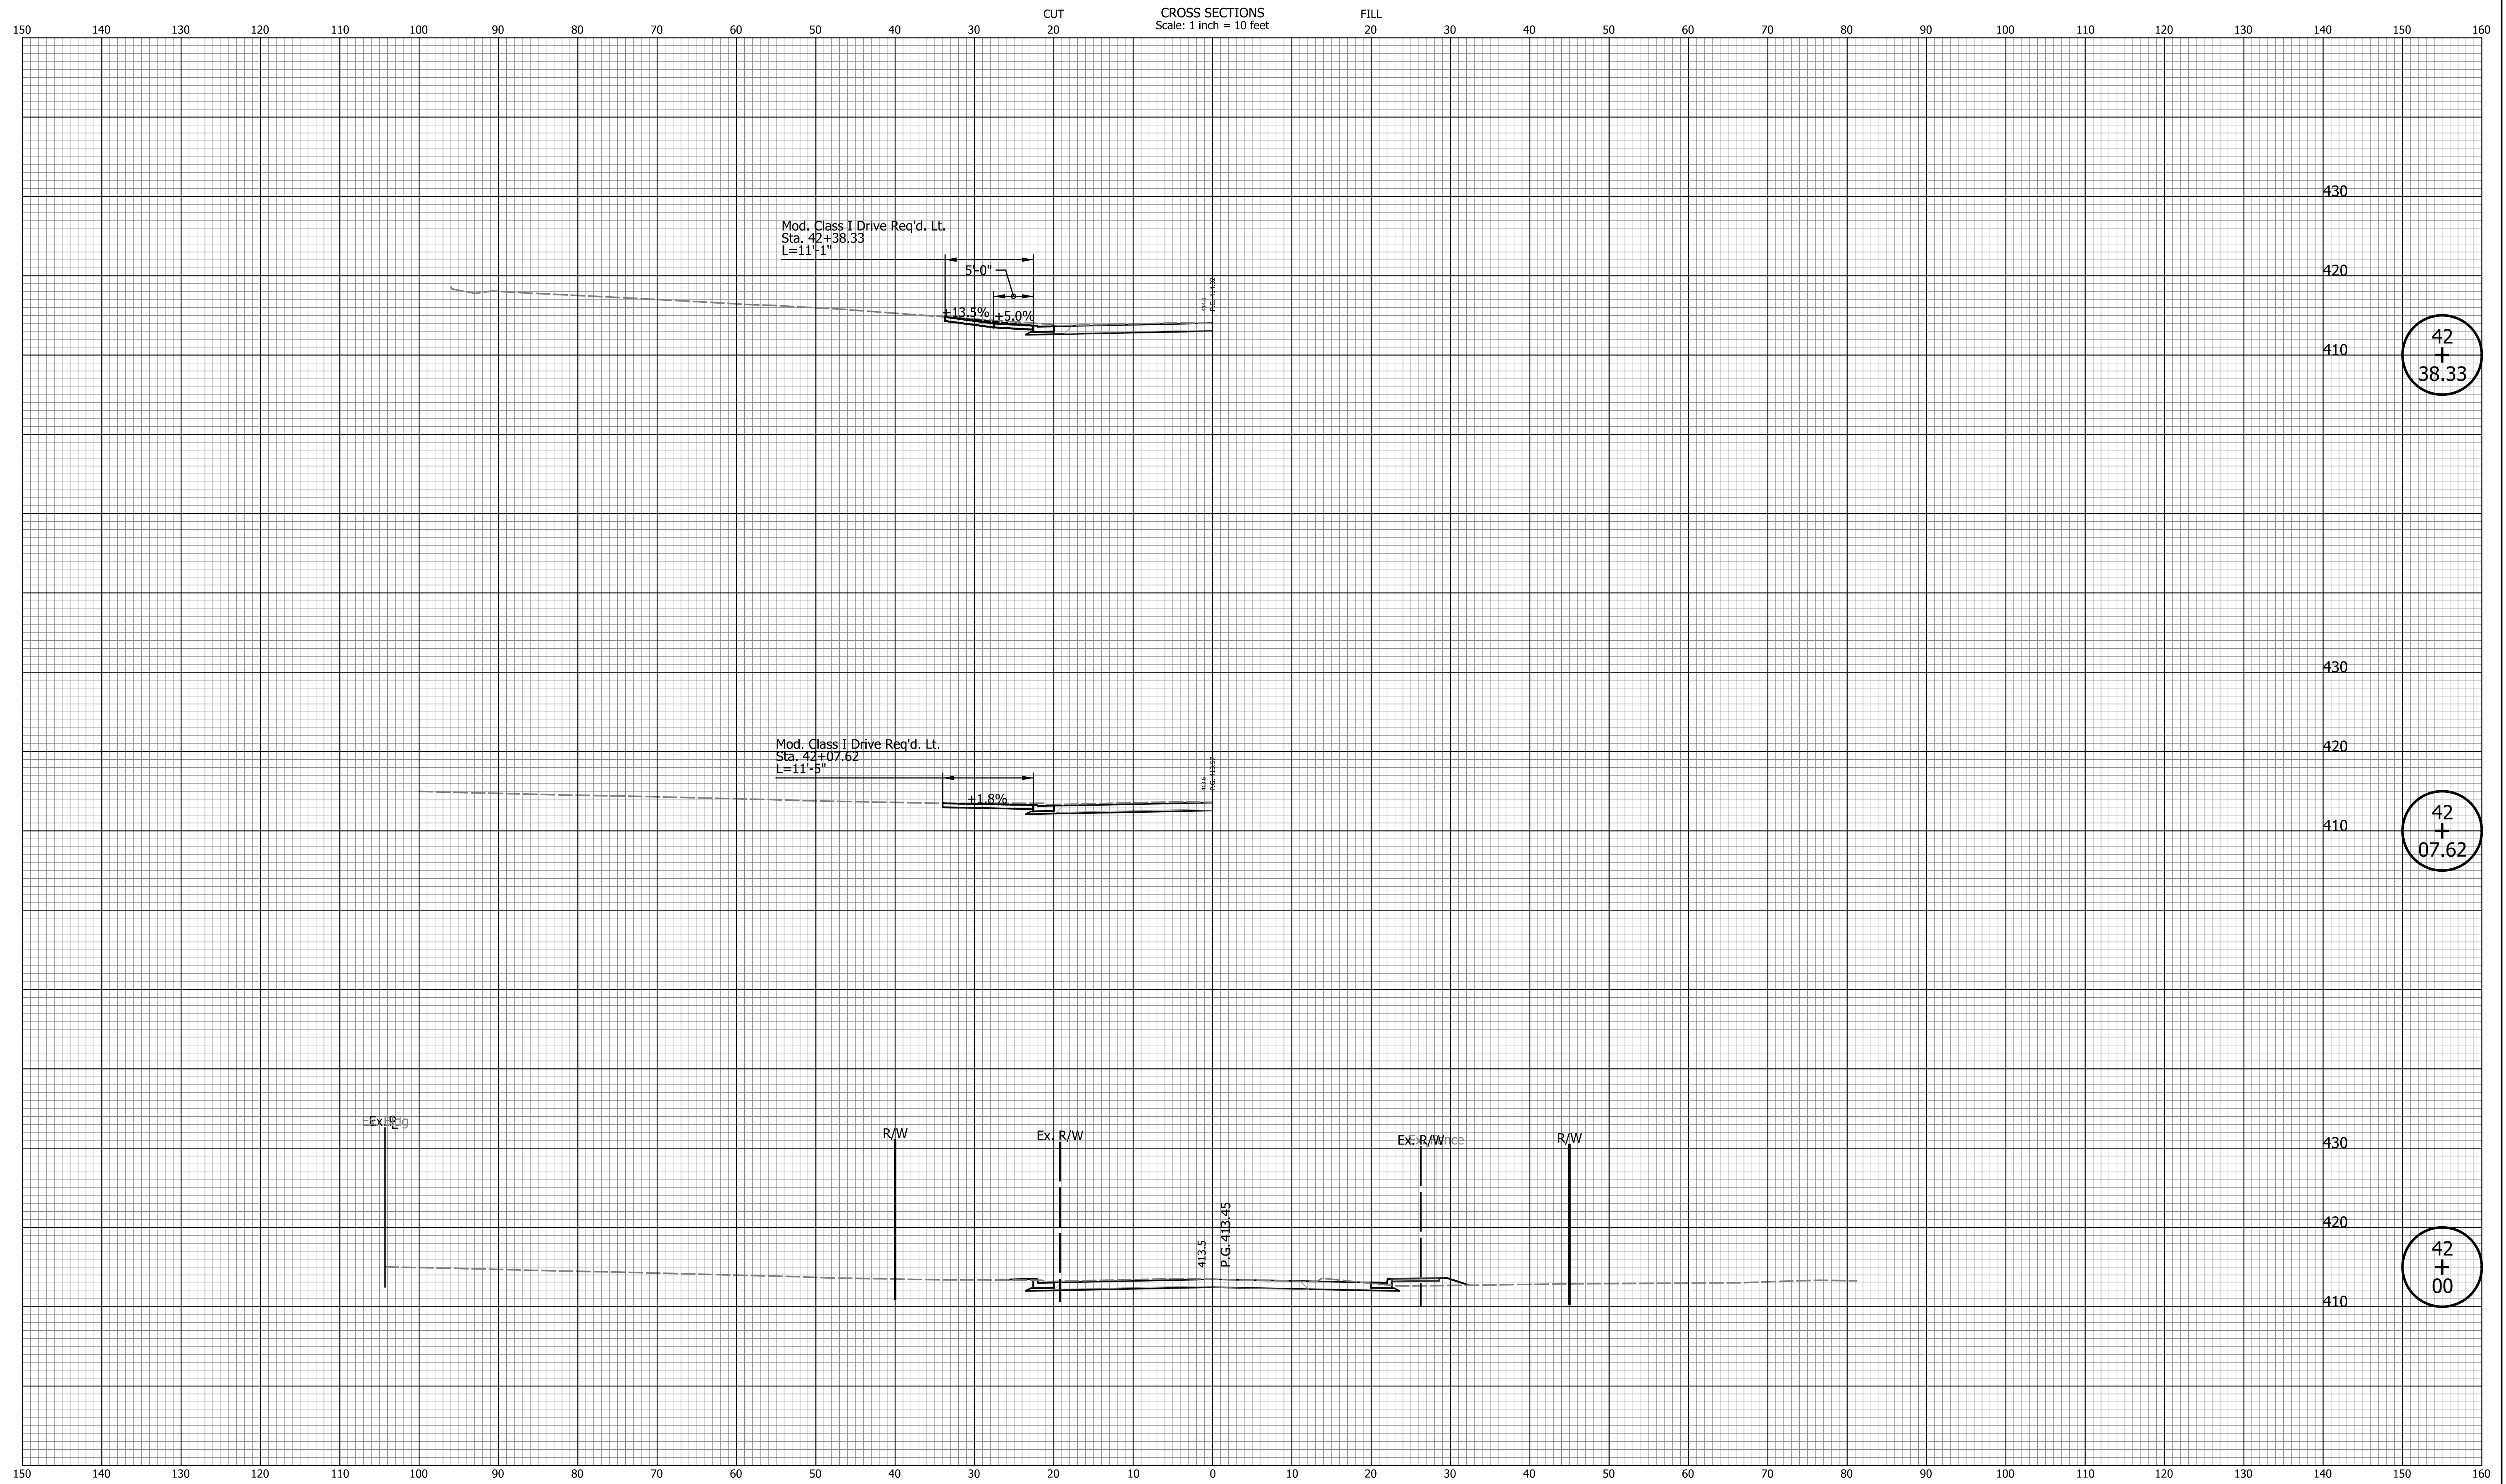

42
+
38.33

42
+
07.62

42
+
00


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RECOMMENDED FOR APPROVAL	DESIGN ENGINEER	DATE
DESIGNED: JAB	DRAWN: EAK	
CHECKED: TMS	CHECKED: TMS	

INDIANA DEPARTMENT OF TRANSPORTATION

CROSS SECTIONS LINE "PR-A"

HORIZONTAL SCALE	BRIDGE FILE
1" = 10'	N/A
VERTICAL SCALE	DESIGNATION
1" = 10'	2002538
SURVEY BOOK	SHEETS
N/A	88 of 117
CONTRACT	PROJECT
R-43470	2002538

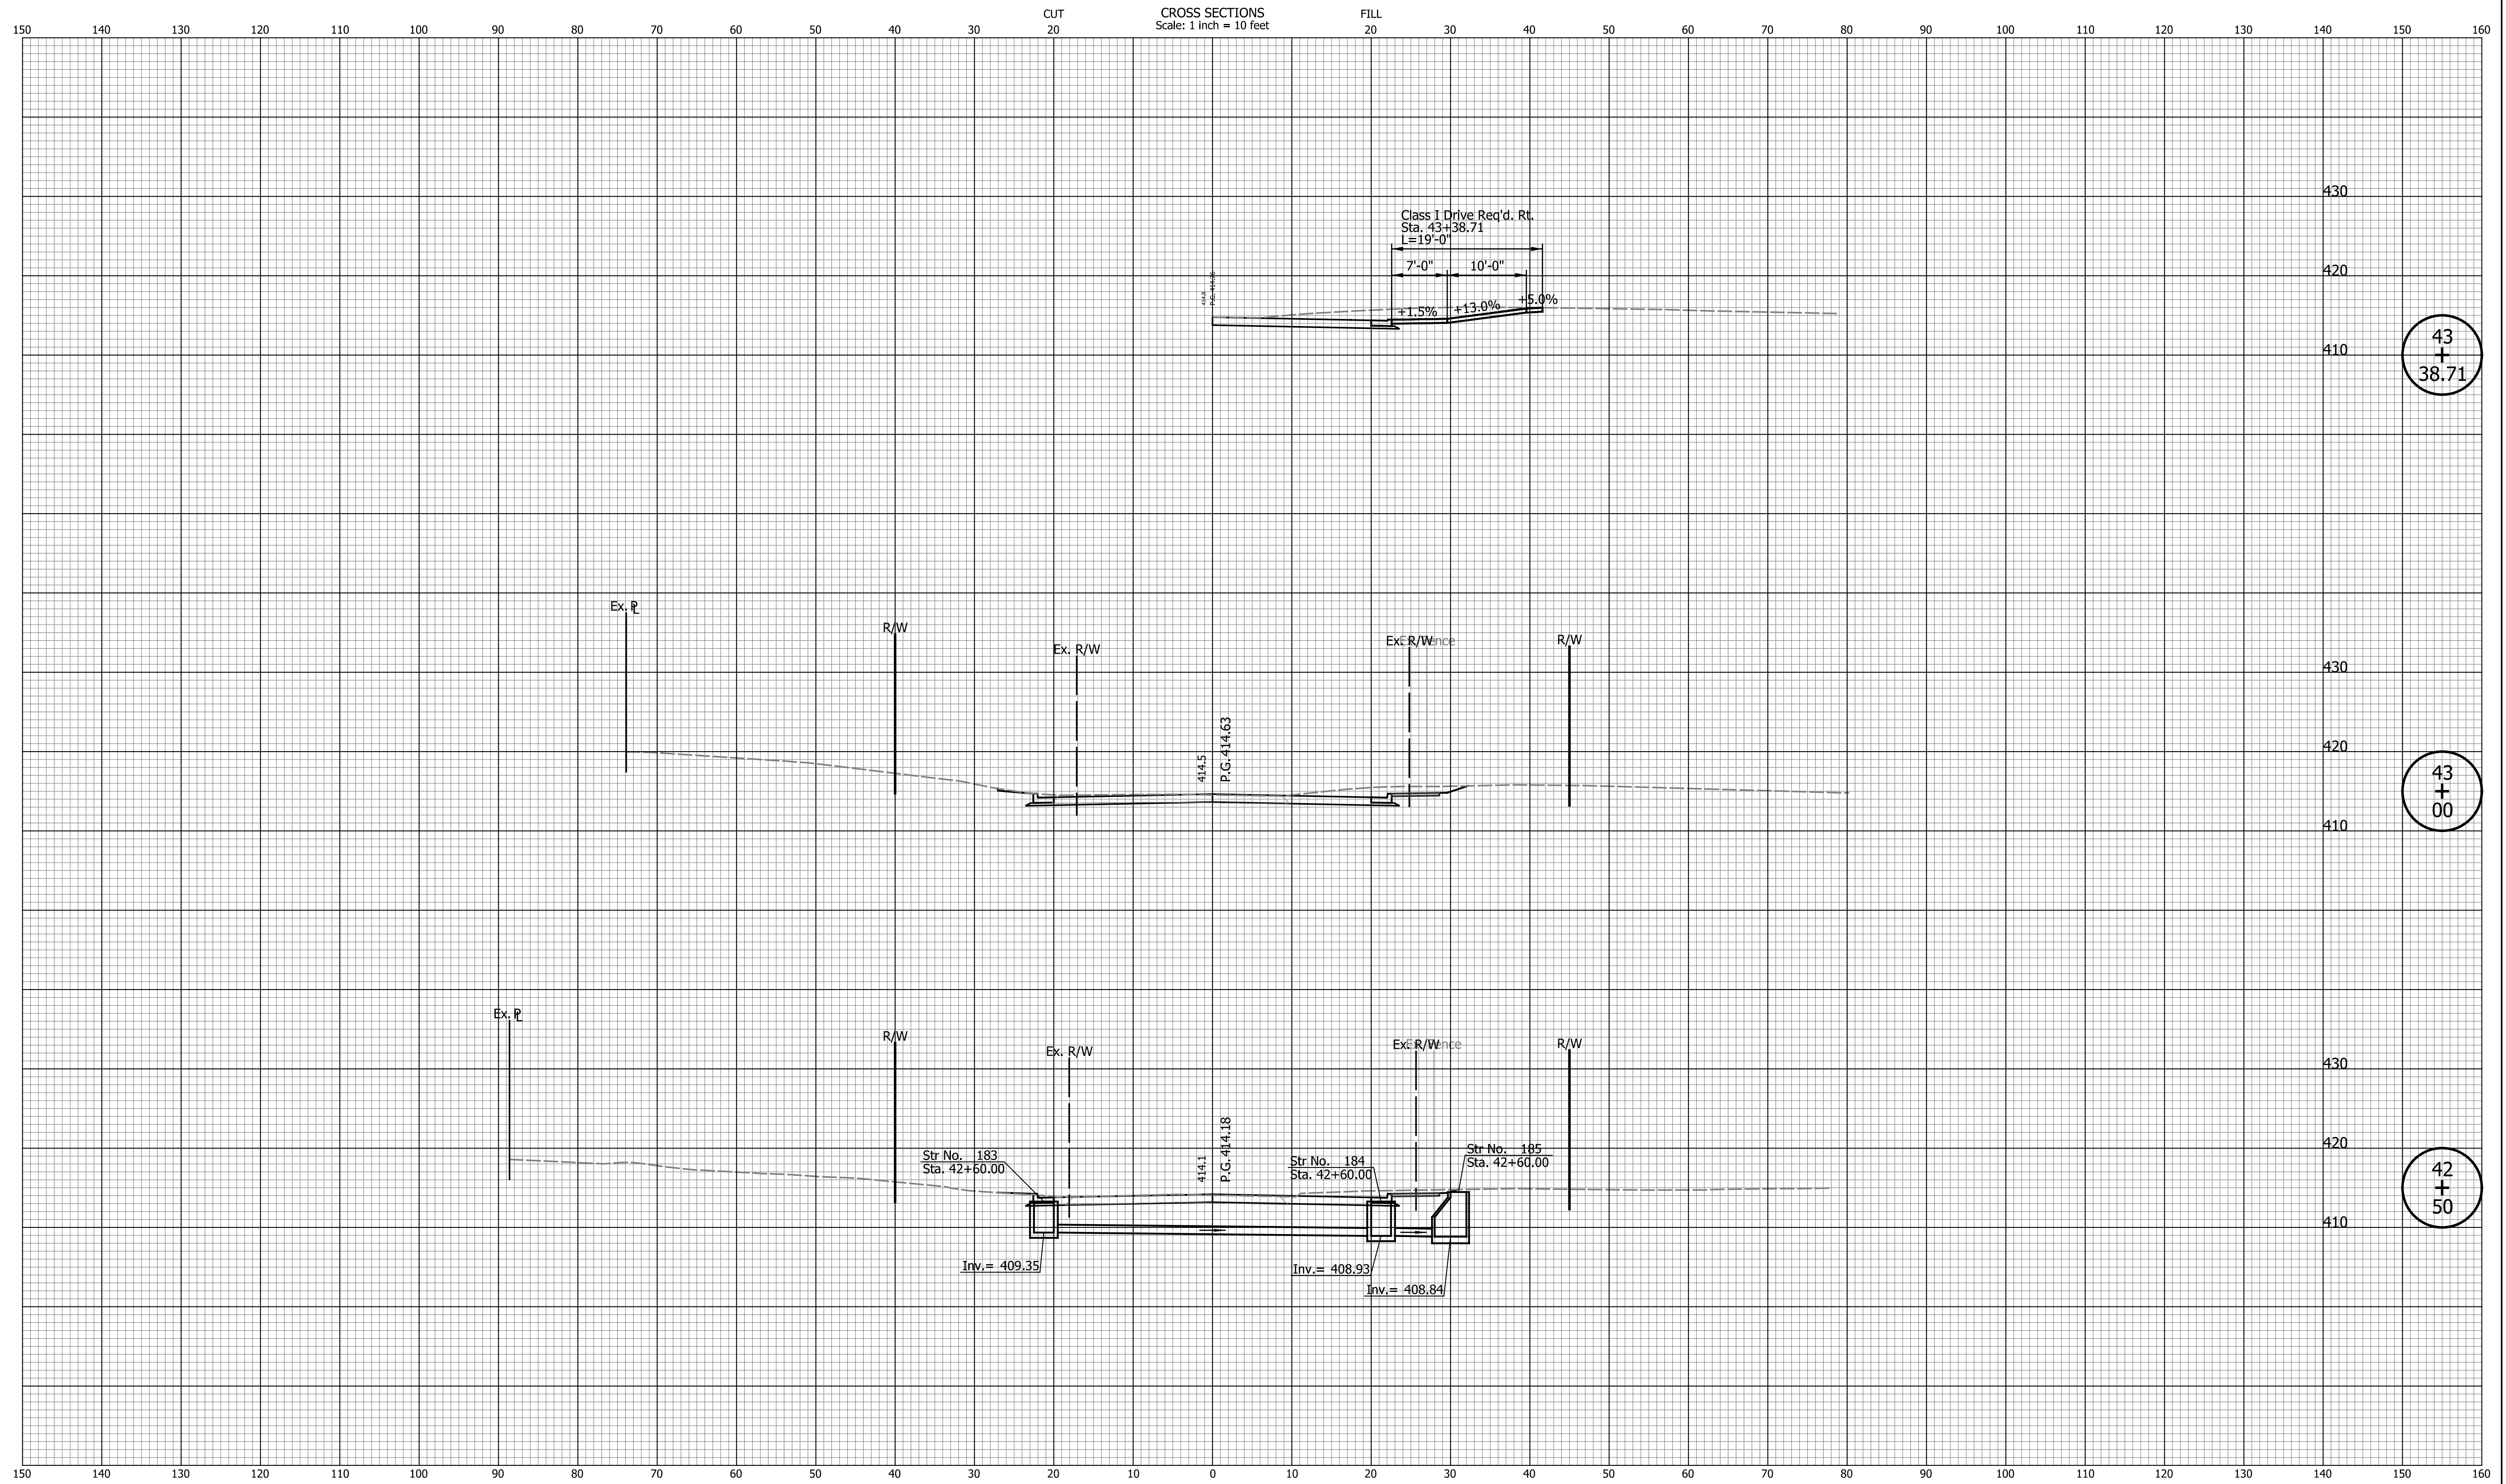

DATE	REVISION


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DESIGNED: JAB	DRAWN: EAK	
CHECKED: TMS	CHECKED: TMS	

INDIANA DEPARTMENT OF TRANSPORTATION

CROSS SECTIONS LINE "PR-A"

HORIZONTAL SCALE	BRIDGE FILE
1" = 10'	N/A
VERTICAL SCALE	DESIGNATION
1" = 10'	2002538
SURVEY BOOK	SHEETS
N/A	89 of 117
CONTRACT	PROJECT
R-43470	2002538

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44
+
47.82

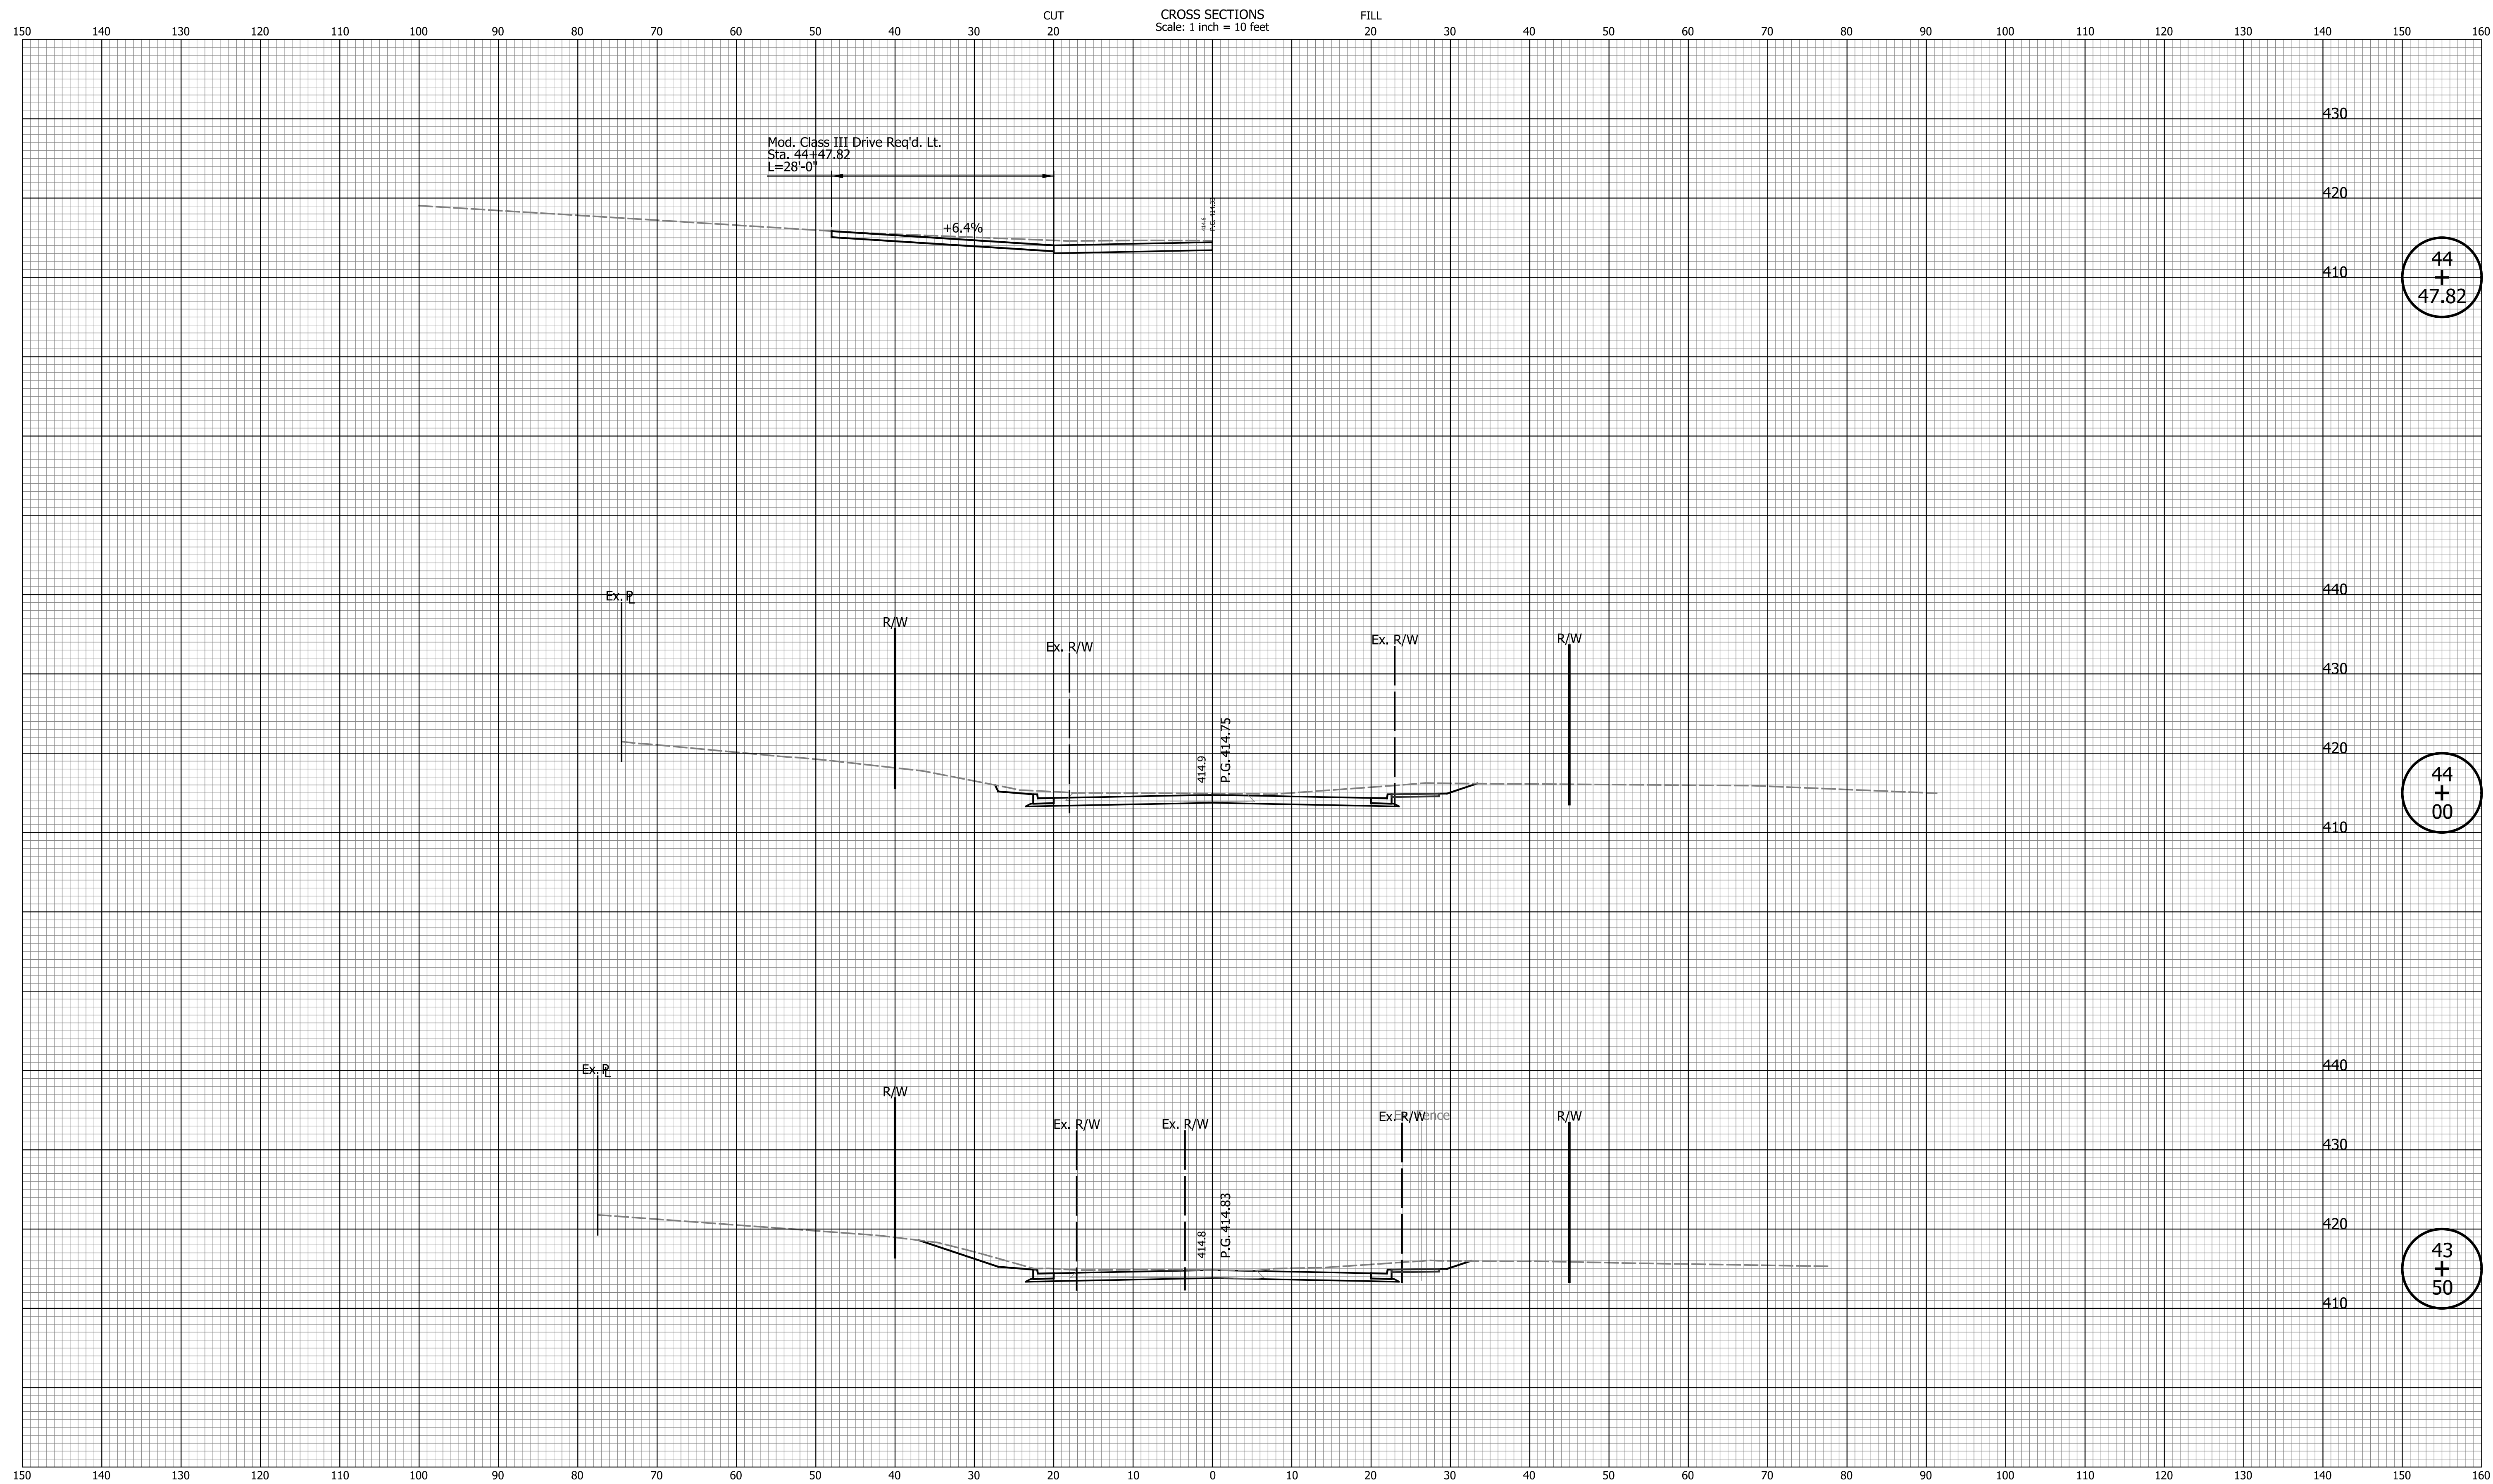44
+
00

43
+
50


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DESIGNED: JAB	DRAWN: EAK	
CHECKED: TMS	CHECKED: TMS	

INDIANA DEPARTMENT OF TRANSPORTATION

CROSS SECTIONS LINE "PR-A"

HORIZONTAL SCALE	BRIDGE FILE
1" = 10'	N/A
VERTICAL SCALE	DESIGNATION
1" = 10'	2002538
SURVEY BOOK	SHEETS
N/A	90 of 117
CONTRACT	PROJECT
R-43470	2002538

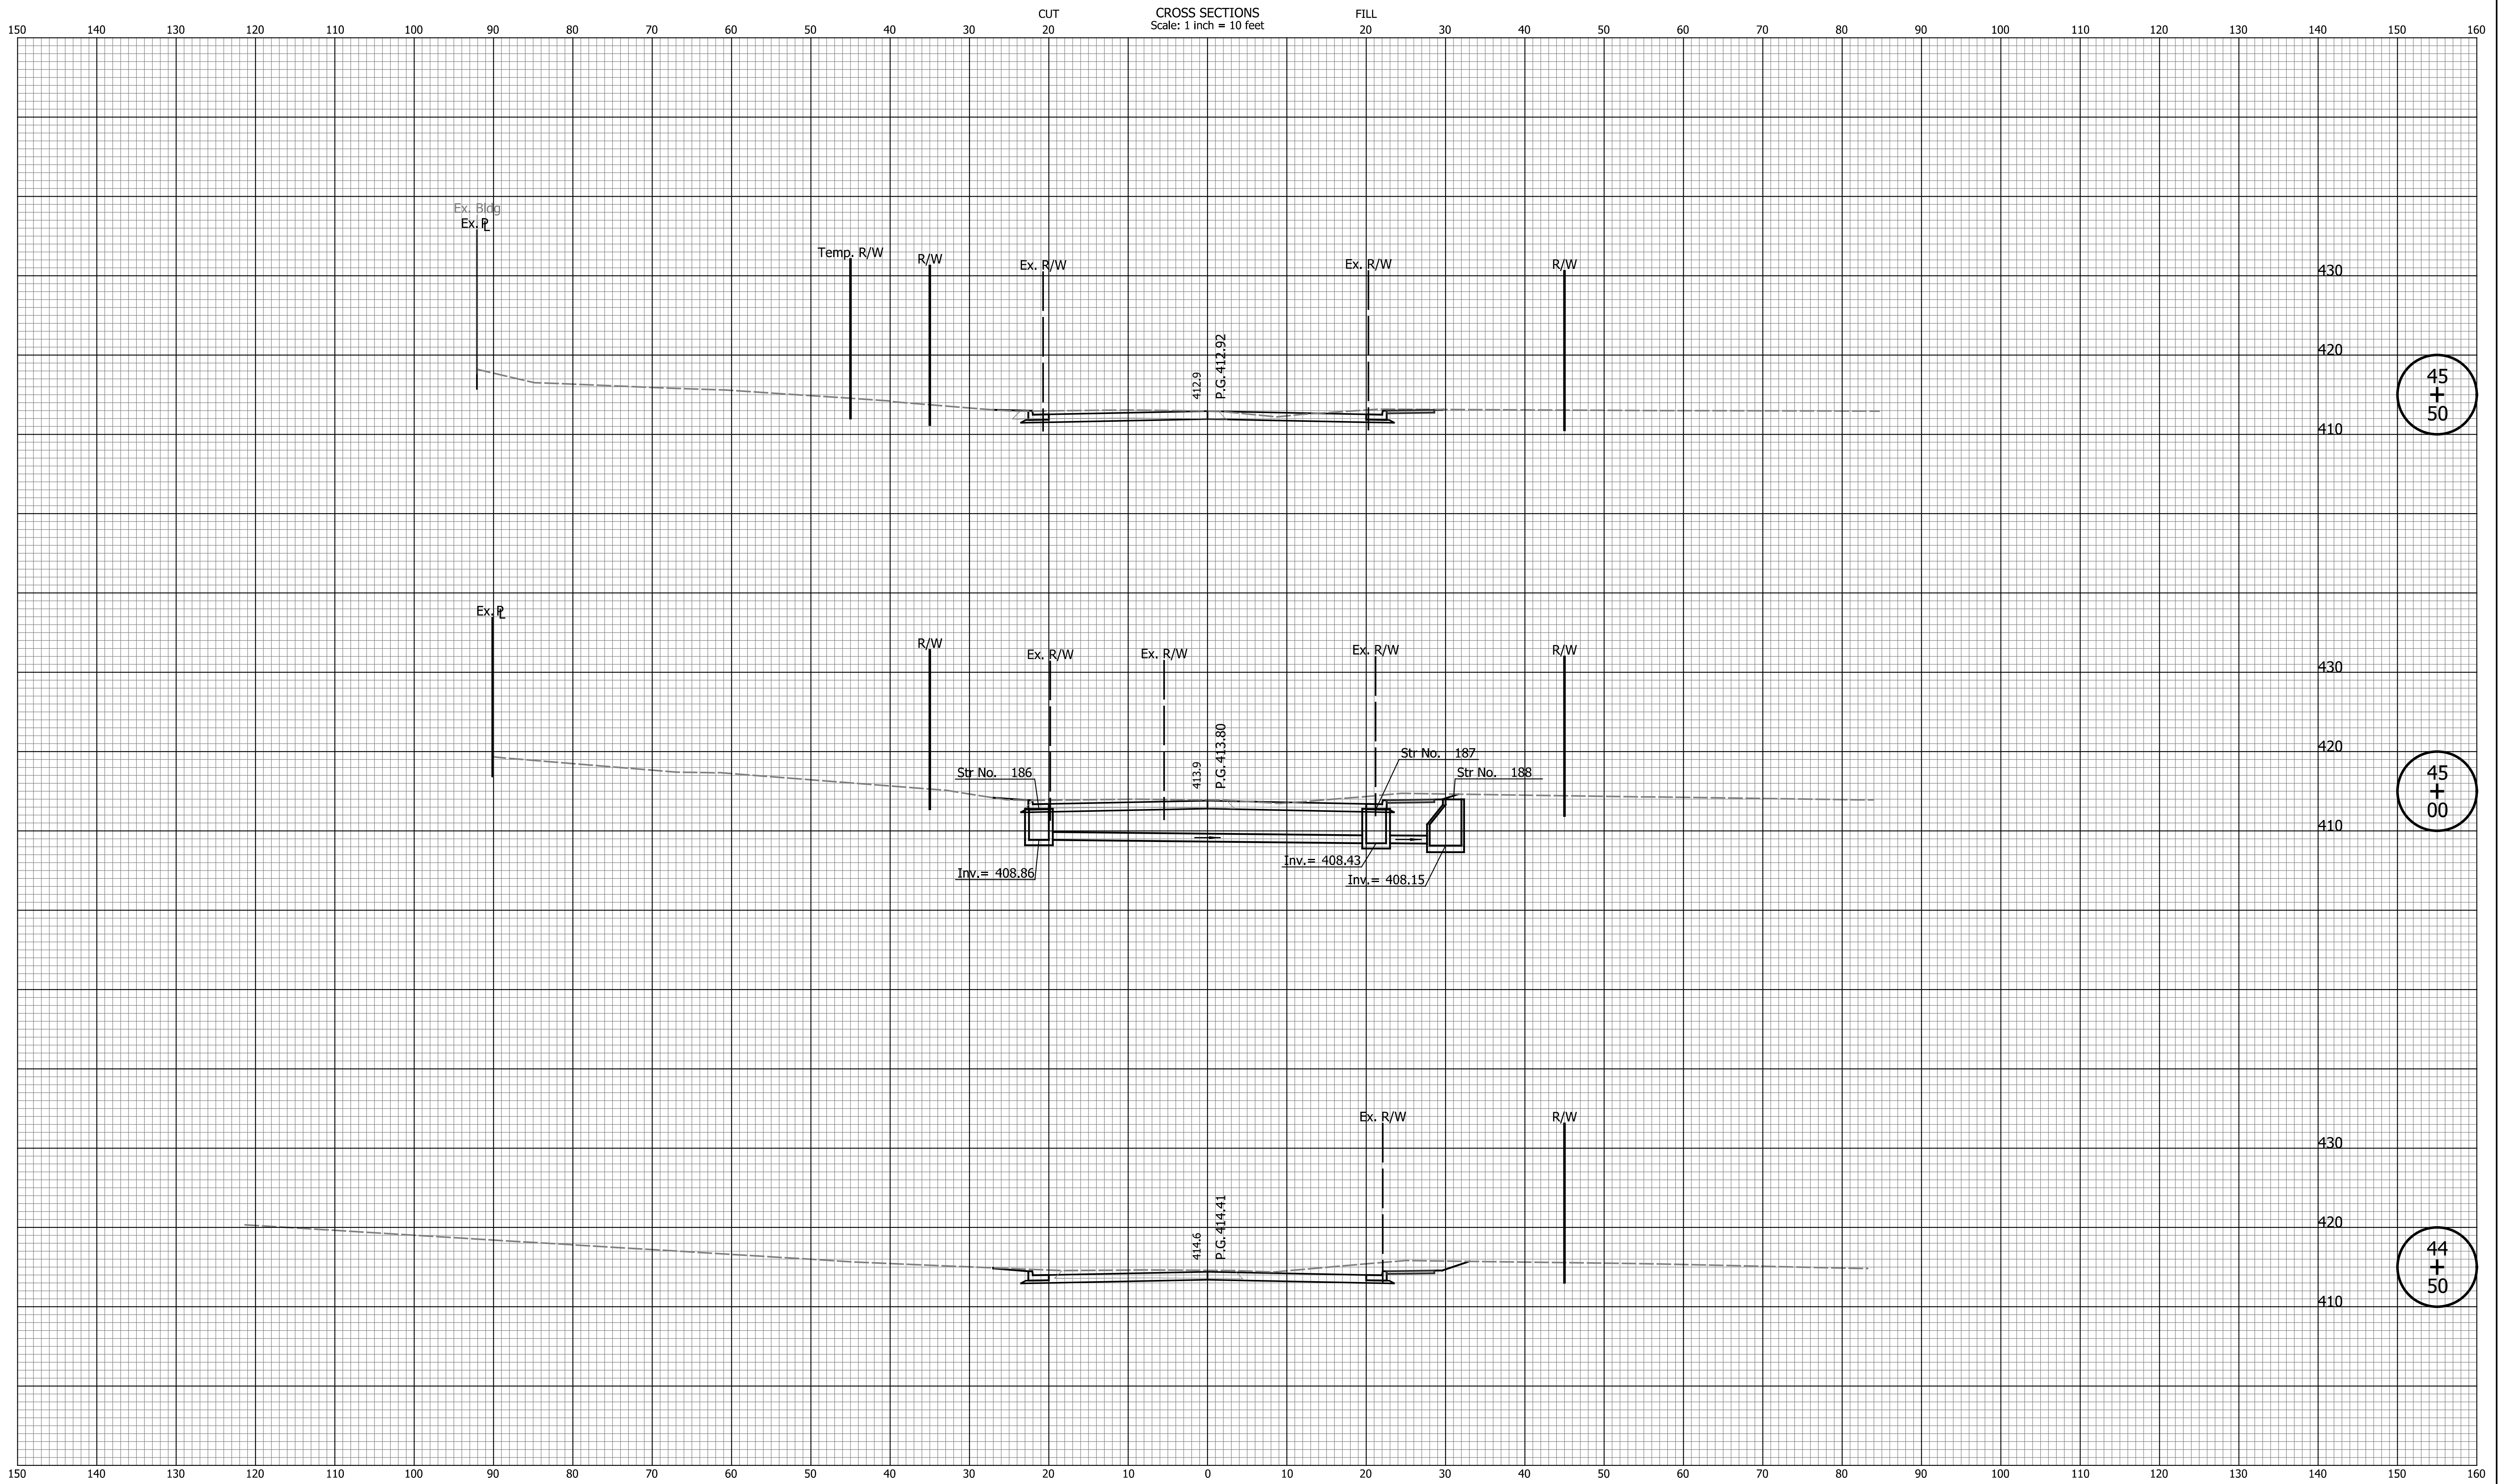


DATE	REVISION

RECOMMENDED FOR APPROVAL	DESIGN ENGINEER	DATE
DESIGNED: JAB	DRAWN: EAK	
CHECKED: TMS	CHECKED: TMS	

INDIANA DEPARTMENT OF TRANSPORTATION

CROSS SECTIONS LINE "PR-A"

HORIZONTAL SCALE	BRIDGE FILE
1" = 10'	N/A
VERTICAL SCALE	DESIGNATION
1" = 10'	2002538
SURVEY BOOK	SHEETS
N/A	91 of 117
CONTRACT	PROJECT
R-43470	2002538

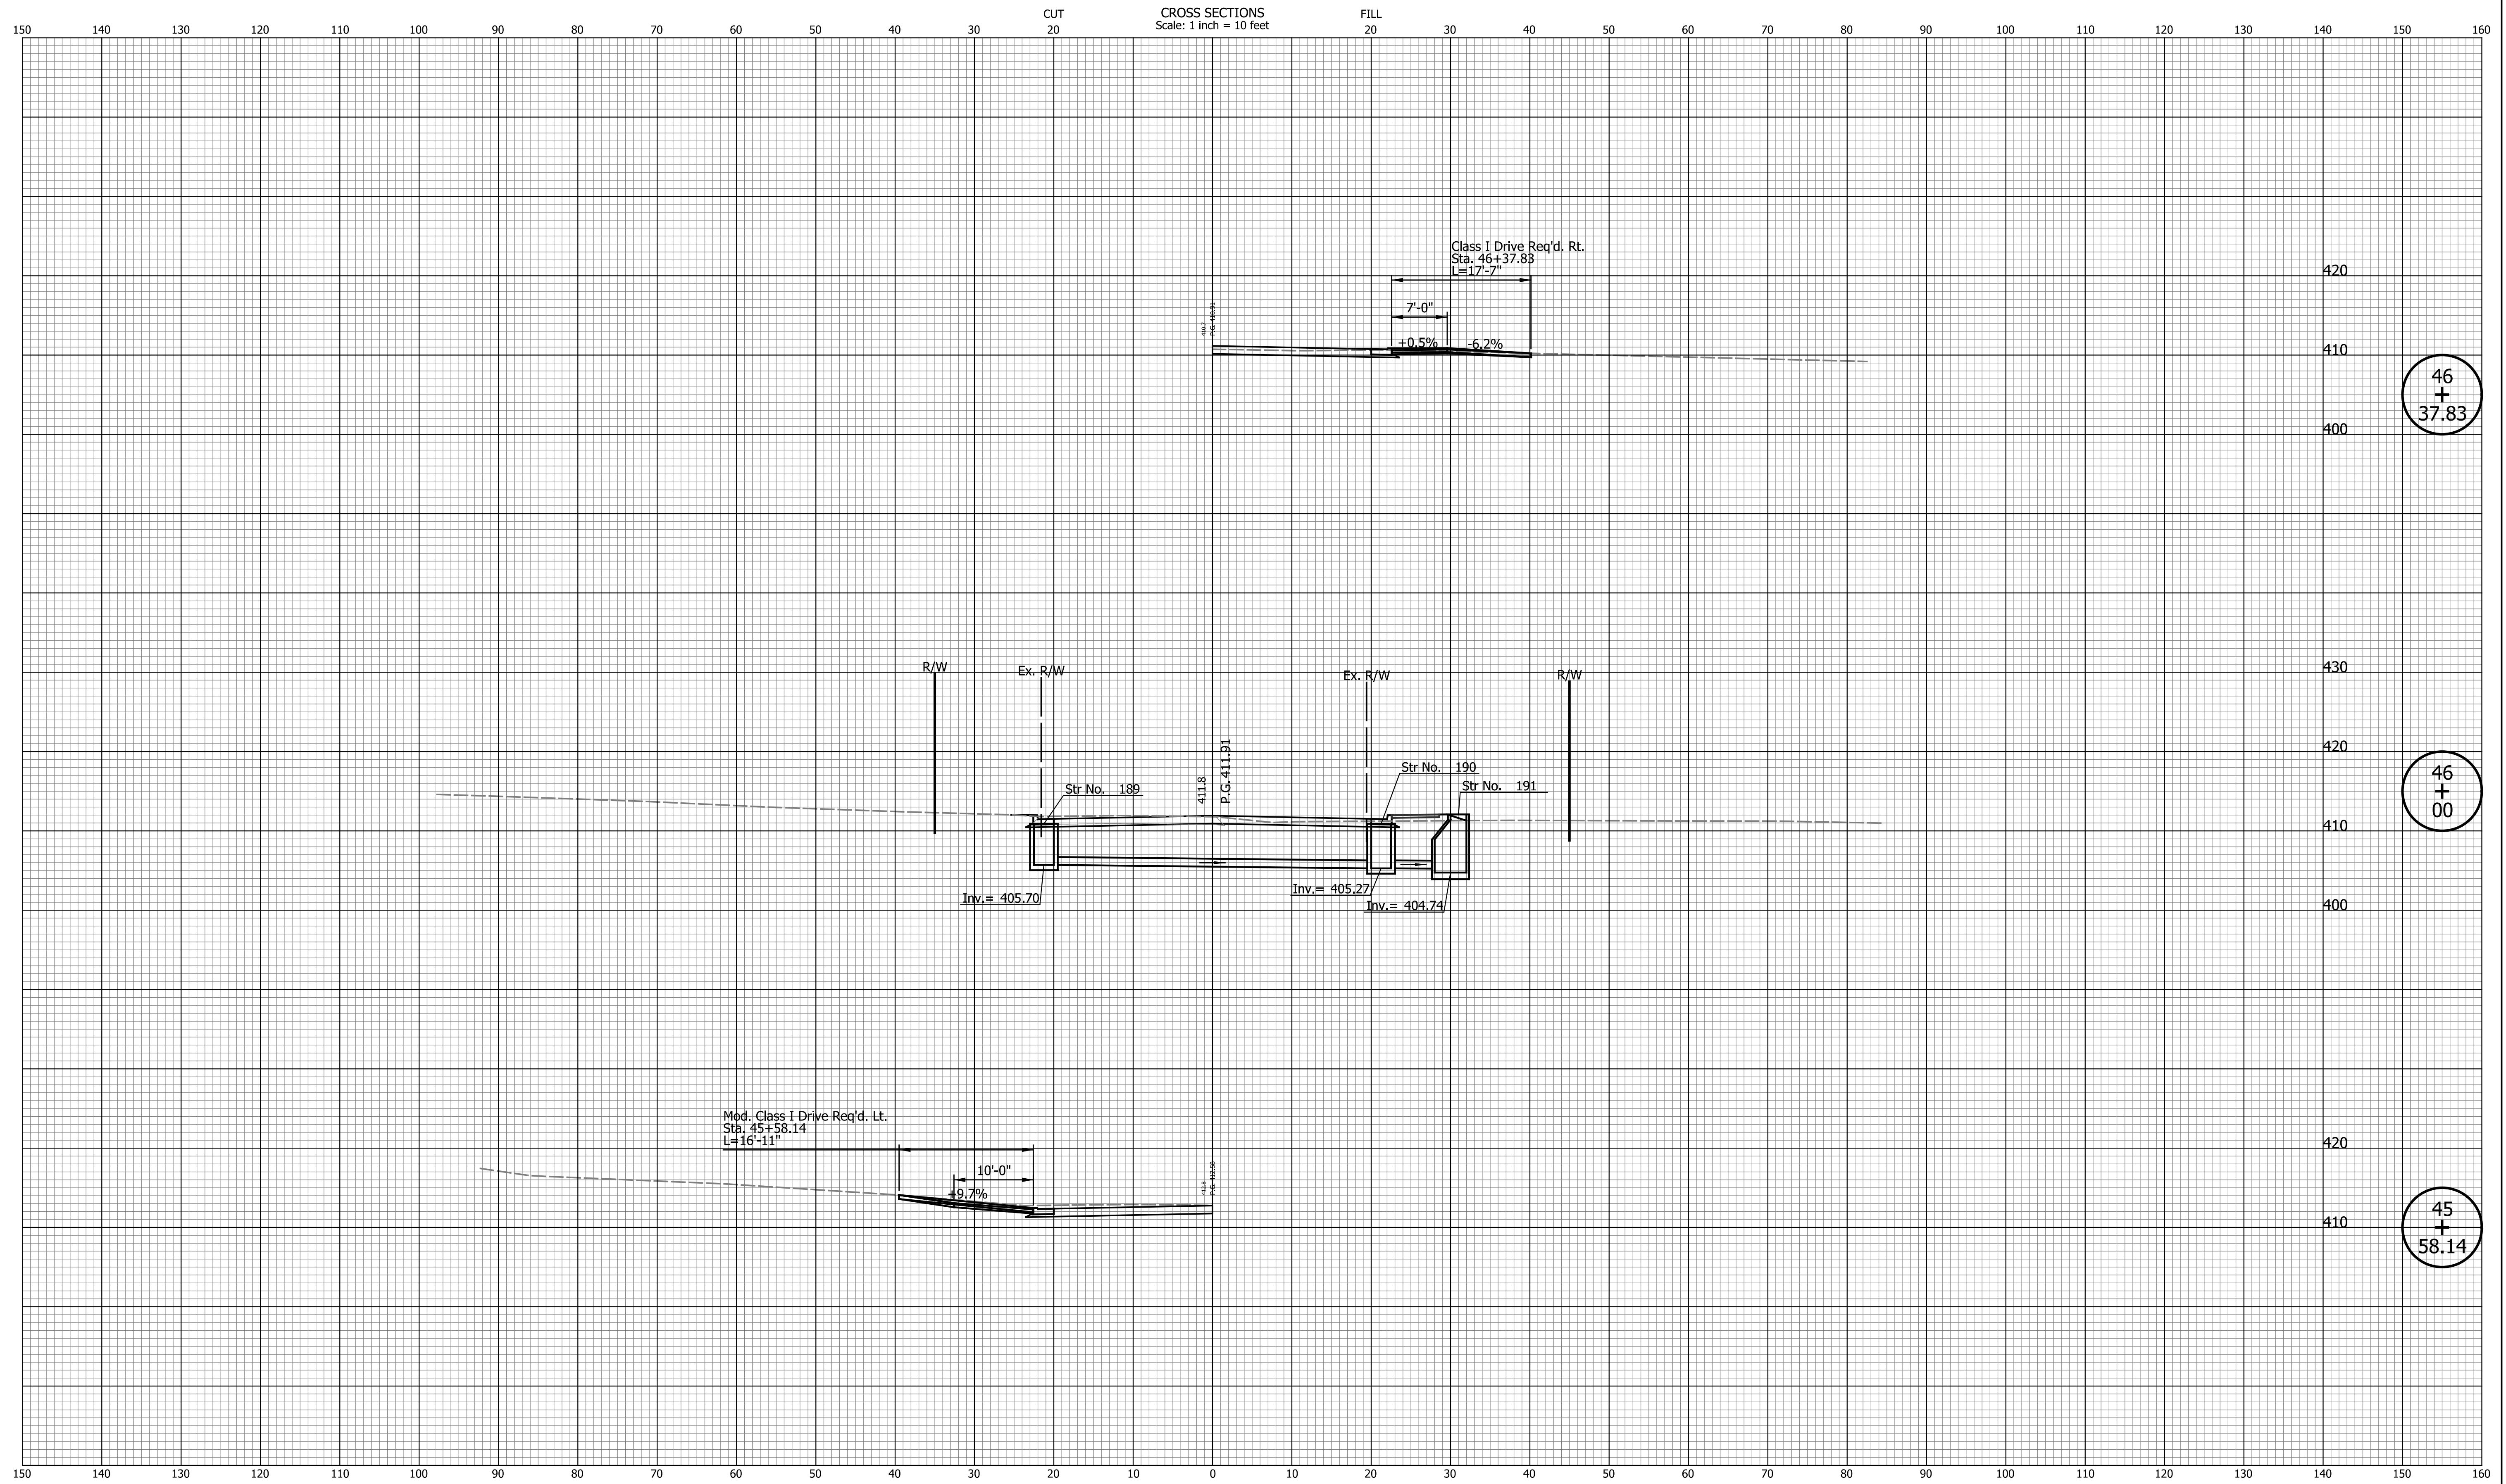

46
+
37.83

46
+
00

45
+
58.14


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DESIGNED: JAB	DRAWN: EAK	
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INDIANA DEPARTMENT OF TRANSPORTATION

CROSS SECTIONS LINE "PR-A"

HORIZONTAL SCALE	BRIDGE FILE
1" = 10'	N/A
VERTICAL SCALE	DESIGNATION
1" = 10'	2002538
SURVEY BOOK	SHEETS
N/A	92 of 117
CONTRACT	PROJECT
R-43470	2002538



48
+
95.77

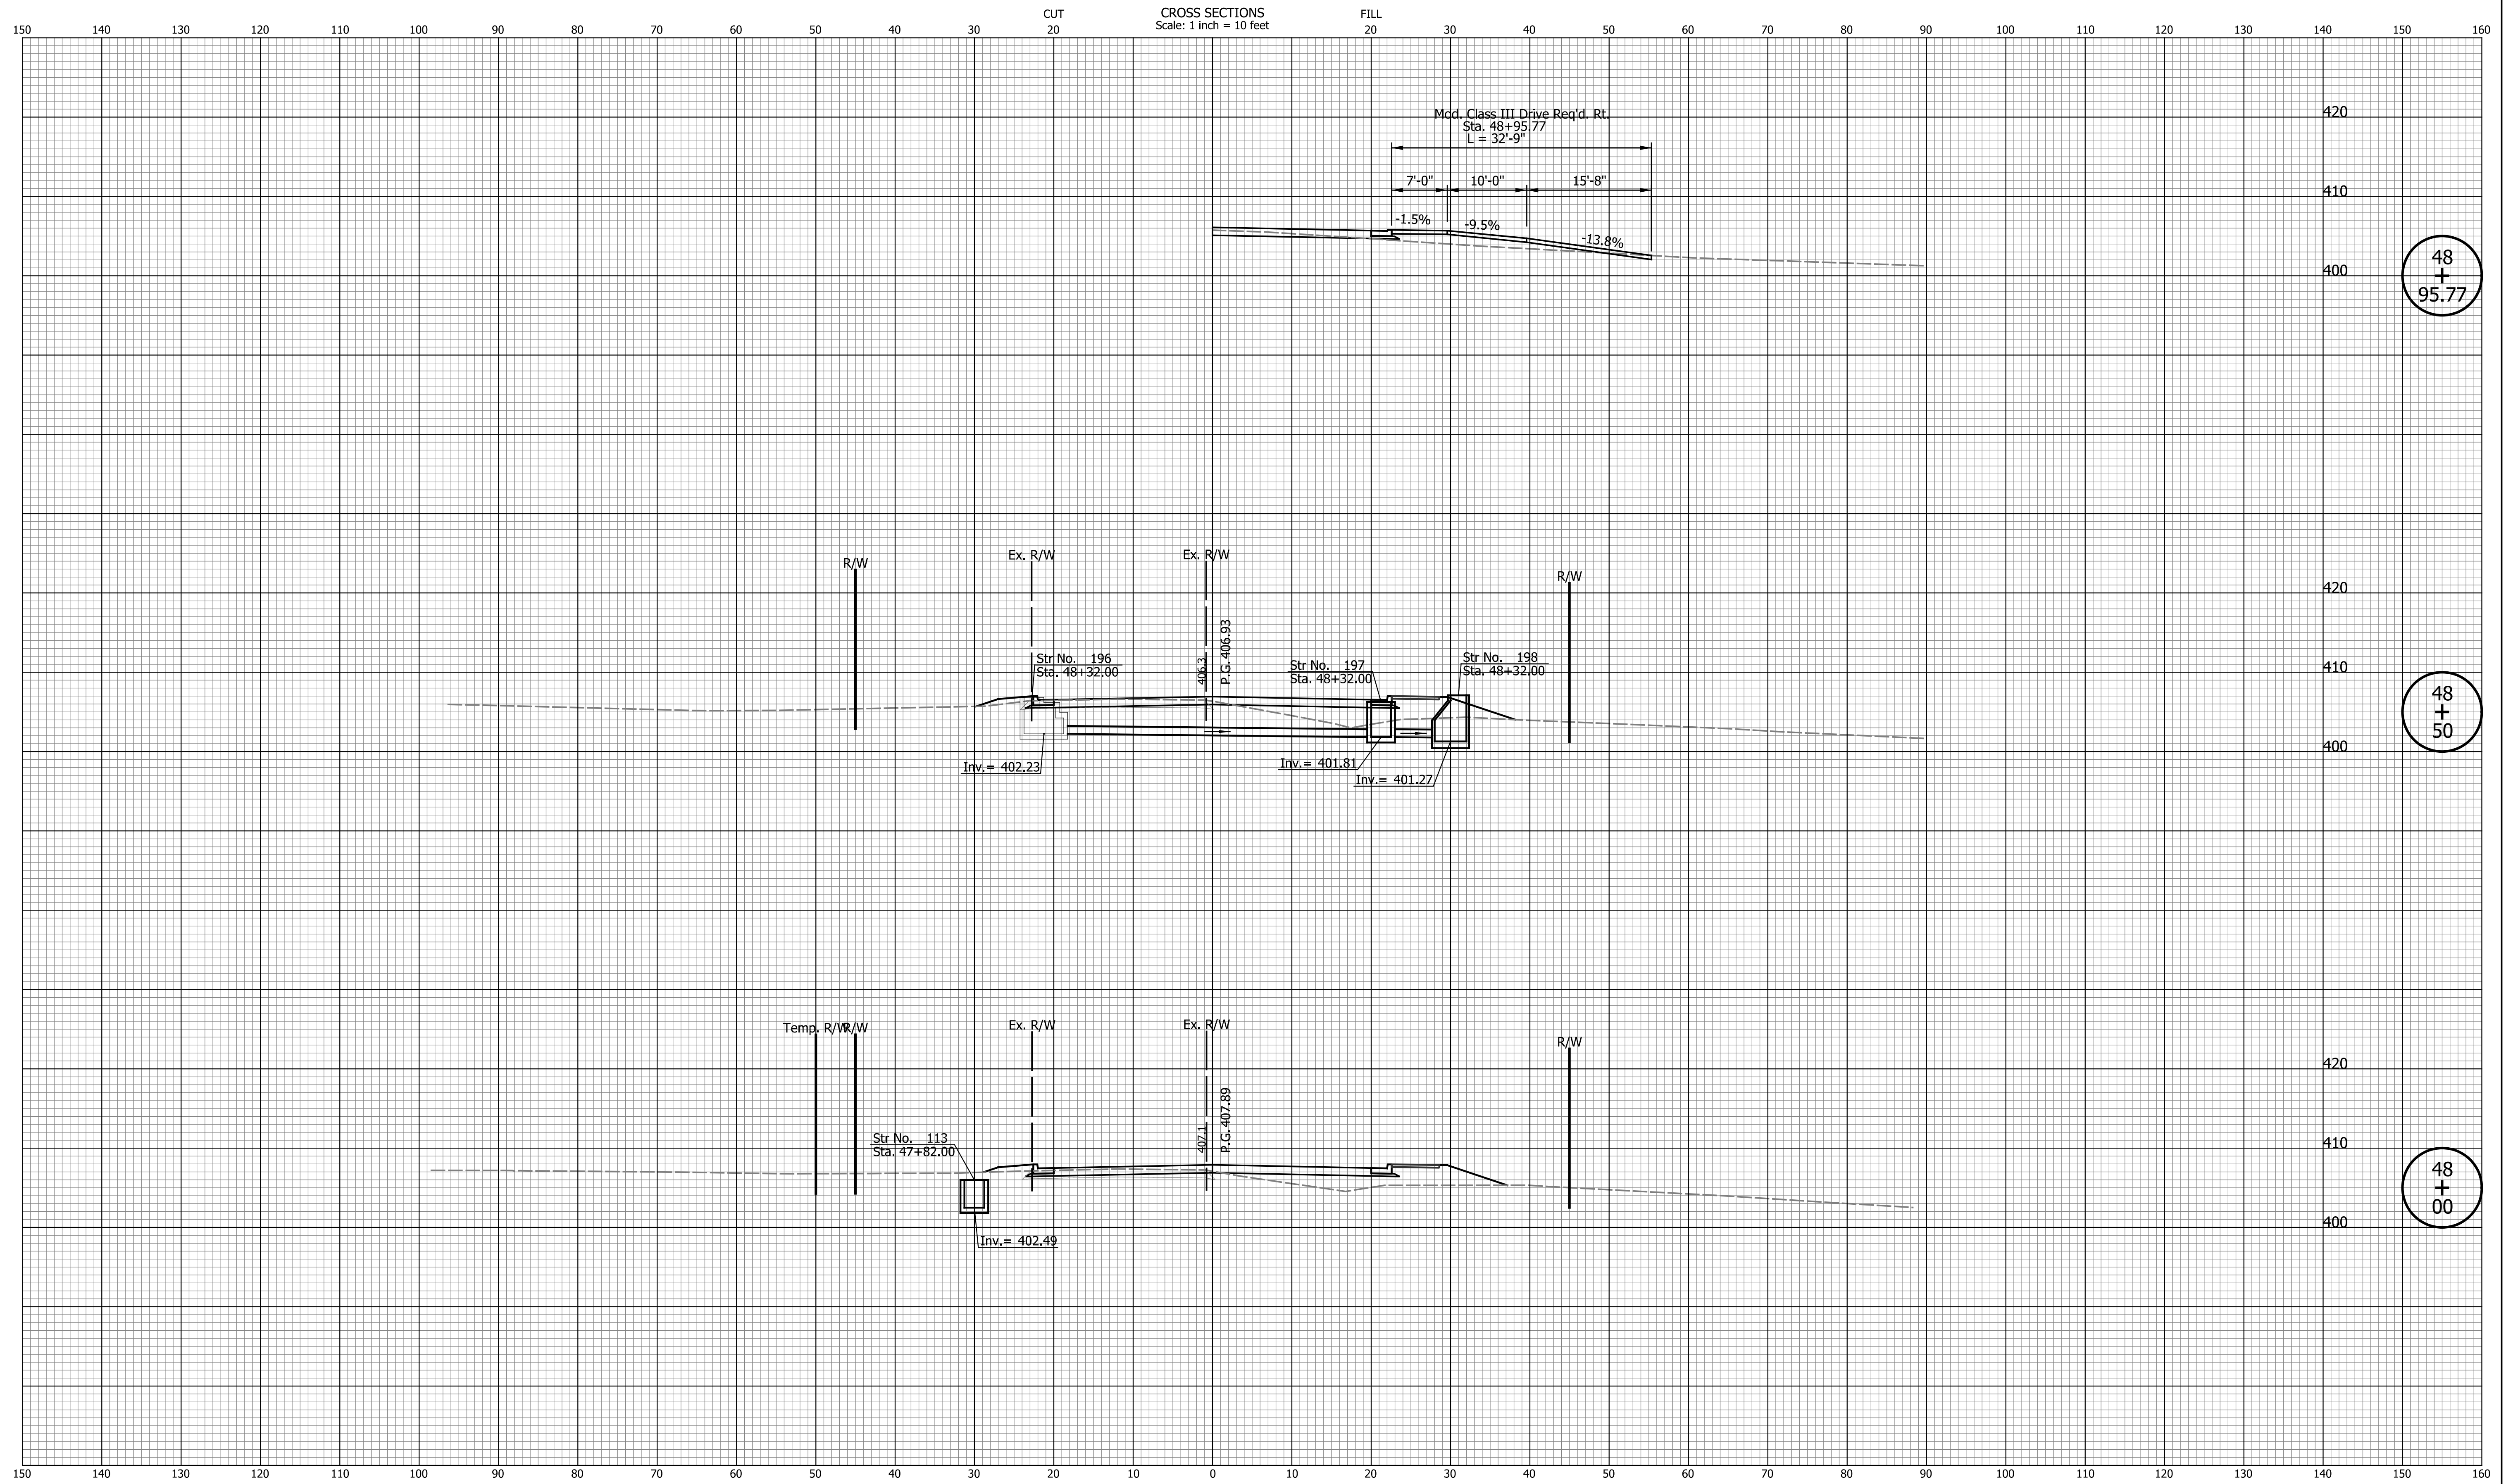48
+
50

48
+
00


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DESIGNED: JAB	DRAWN: EAK	
CHECKED: TMS	CHECKED: TMS	

INDIANA DEPARTMENT OF TRANSPORTATION

CROSS SECTIONS LINE "PR-A"

HORIZONTAL SCALE	BRIDGE FILE
1" = 10'	N/A
VERTICAL SCALE	DESIGNATION
1" = 10'	2002538
SURVEY BOOK	SHEETS
N/A	95 of 117
CONTRACT	PROJECT
R-43470	2002538

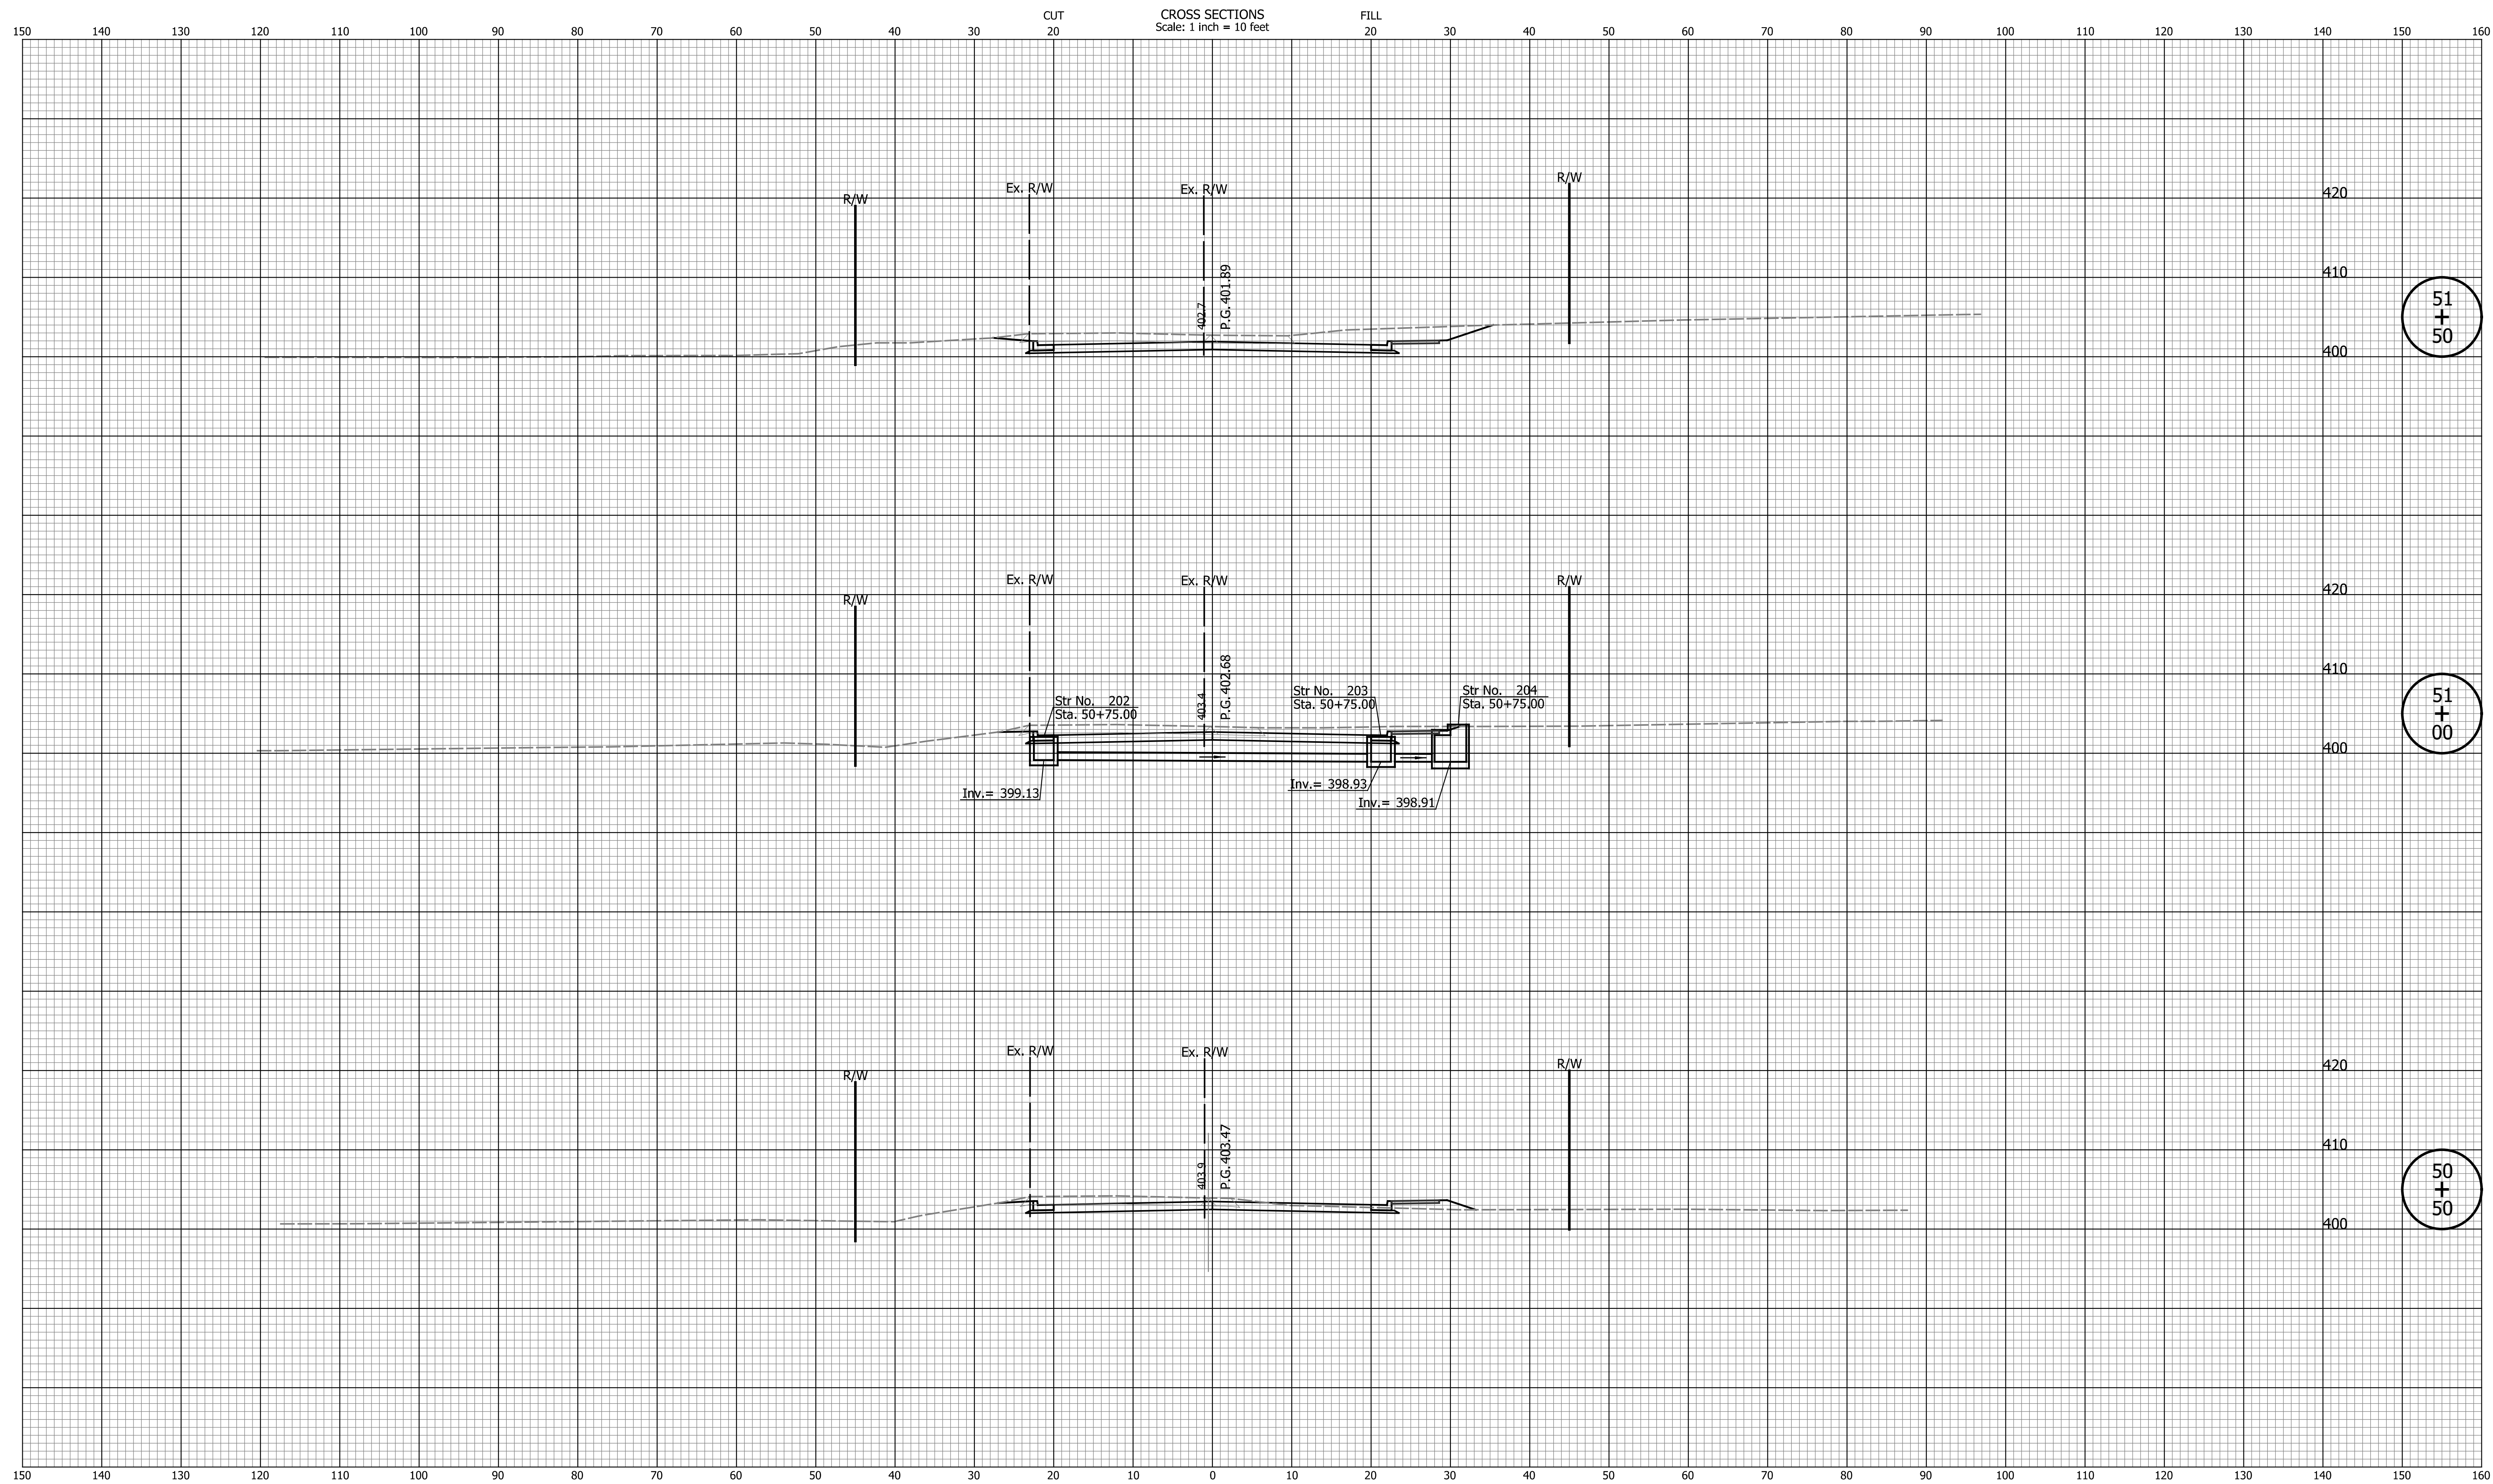

51
+
50

51
+
00

50
+
50

DATE	REVISION


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INDIANA DEPARTMENT OF TRANSPORTATION

CROSS SECTIONS LINE "PR-A"

HORIZONTAL SCALE	BRIDGE FILE
1" = 10'	N/A
VERTICAL SCALE	DESIGNATION
1" = 10'	2002538
SURVEY BOOK	SHEETS
N/A	97 of 117
CONTRACT	PROJECT
R-43470	2002538

CROSS SECTIONS
Scale: 1 inch = 10 feet

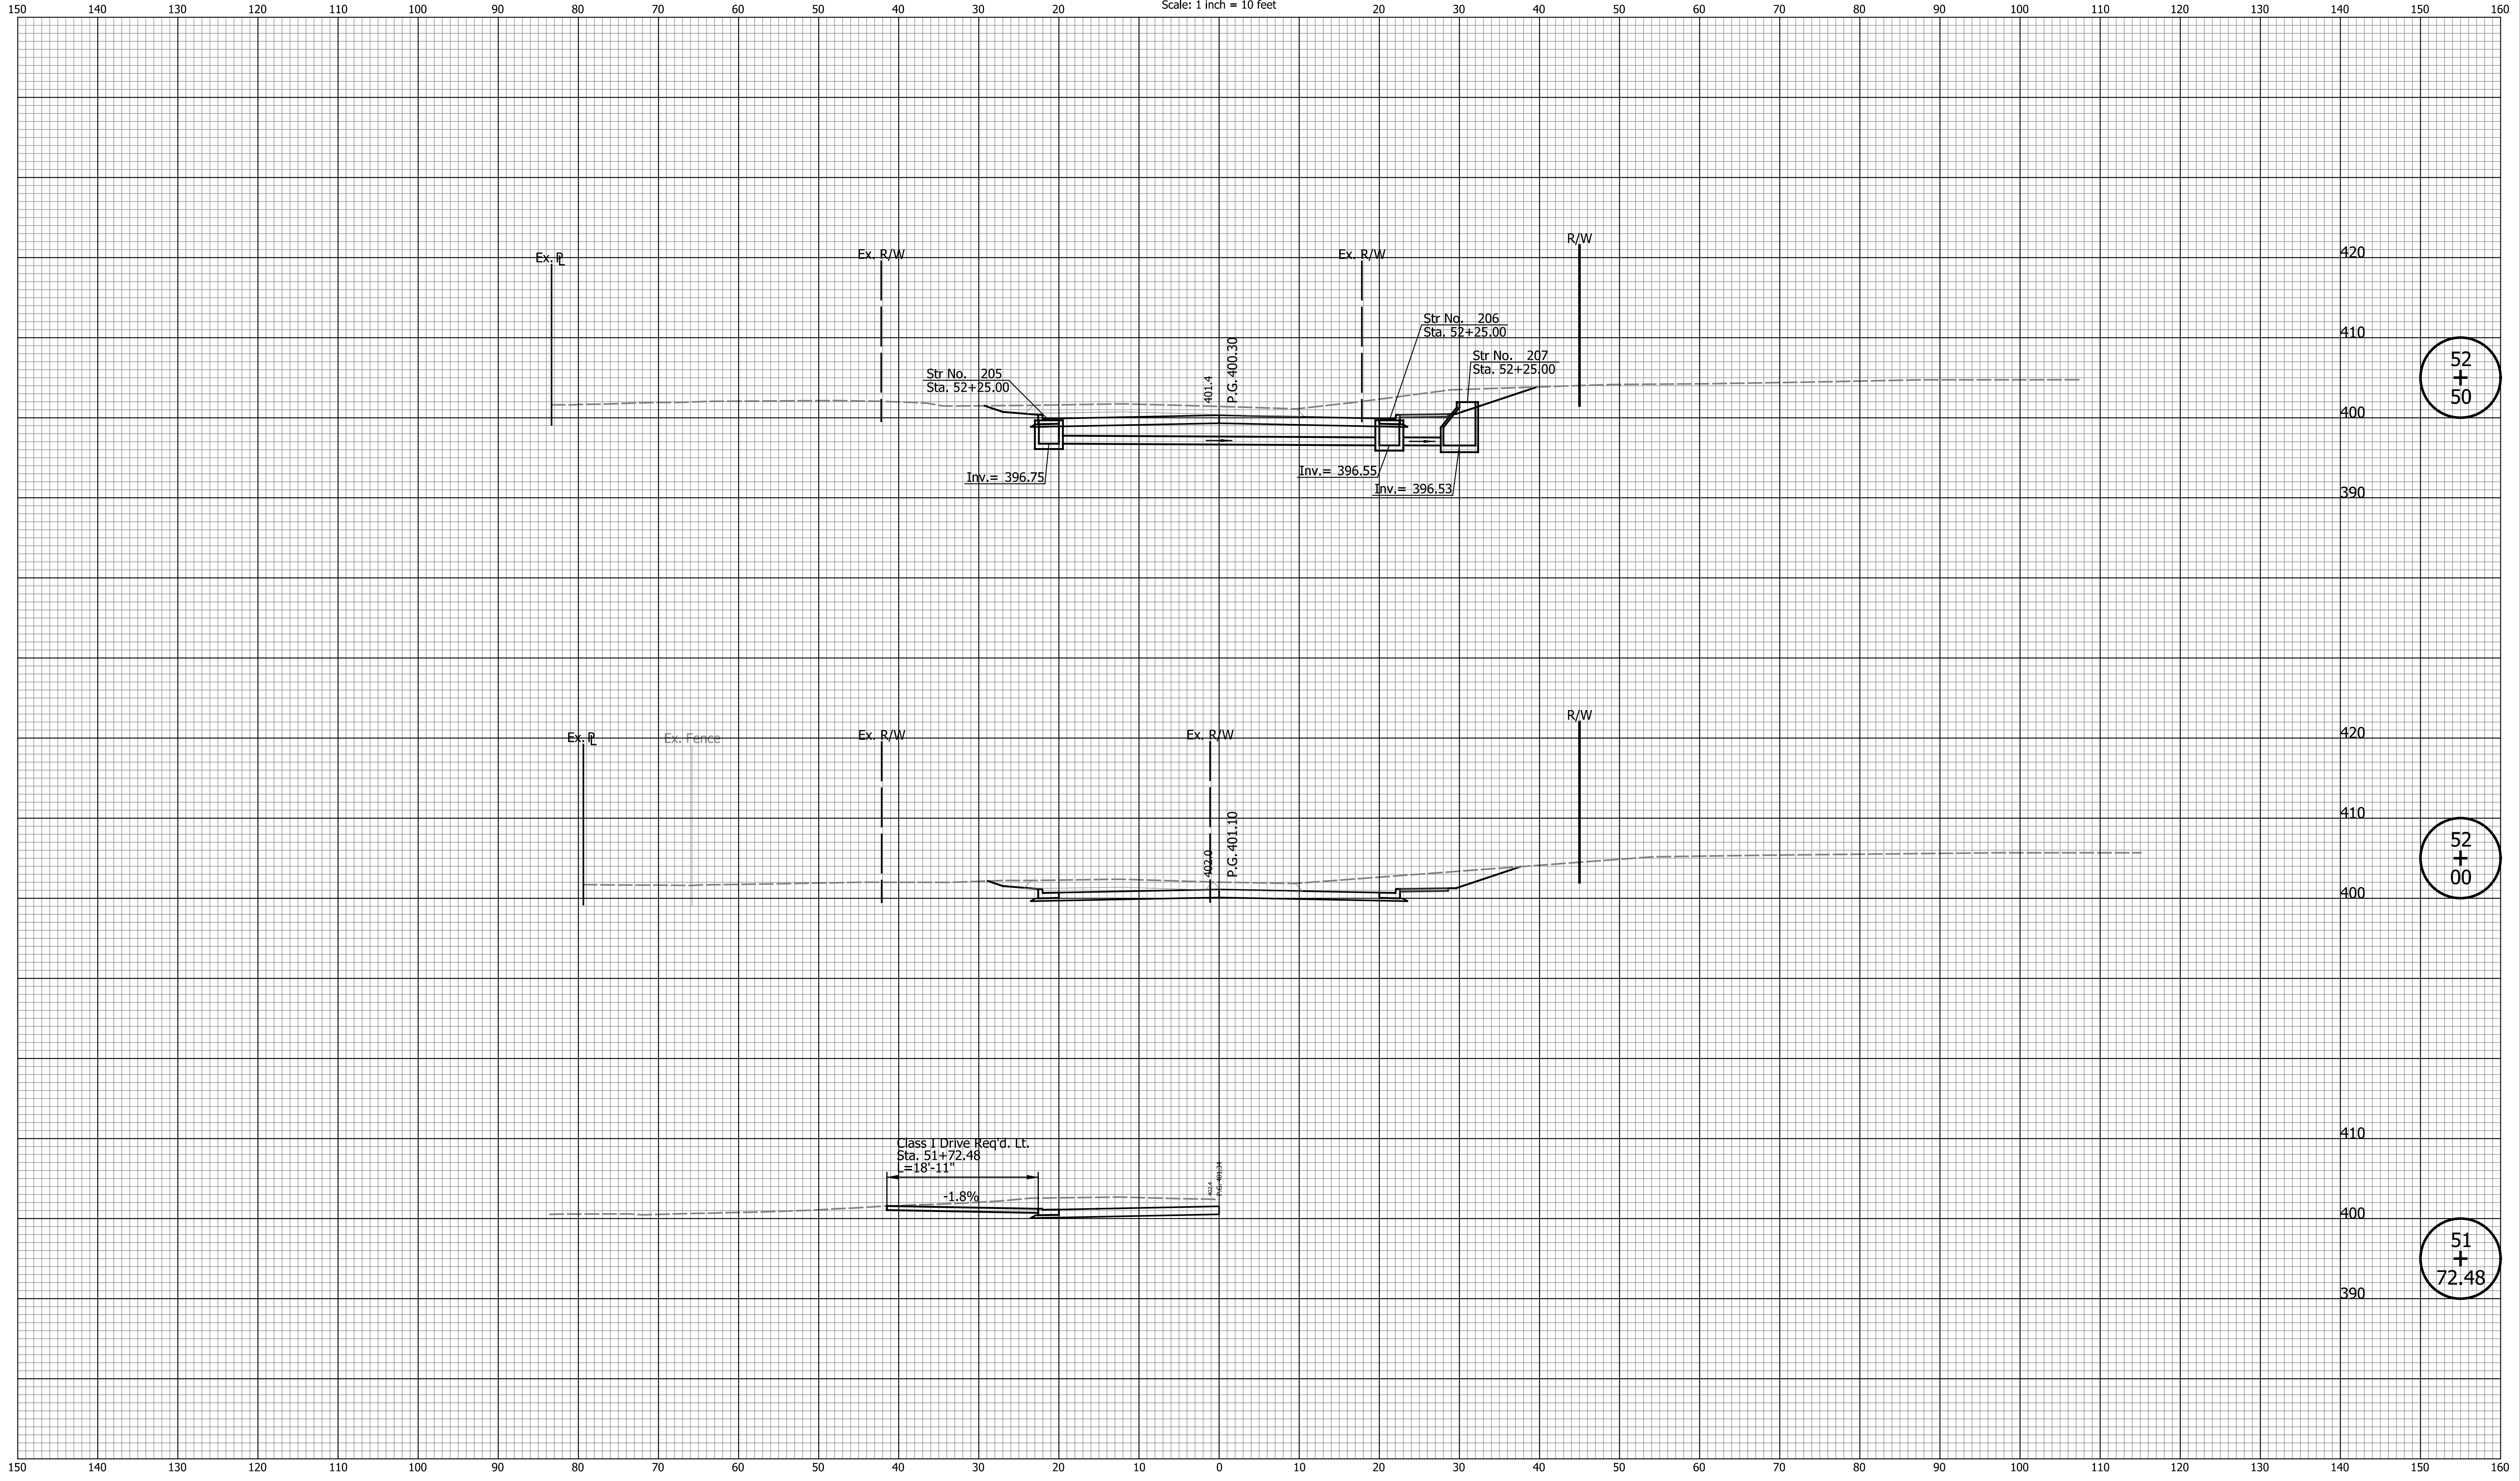

52
+
50

52
+
00

51
+
72.48

DATE	REVISION


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INDIANA DEPARTMENT OF TRANSPORTATION

CROSS SECTIONS LINE "PR-A"

HORIZONTAL SCALE	BRIDGE FILE
1" = 10'	N/A
VERTICAL SCALE	DESIGNATION
1" = 10'	2002538
SURVEY BOOK	SHEETS
N/A	98 of 117
CONTRACT	PROJECT
R-43470	2002538

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53
+
47.19

53
+
00

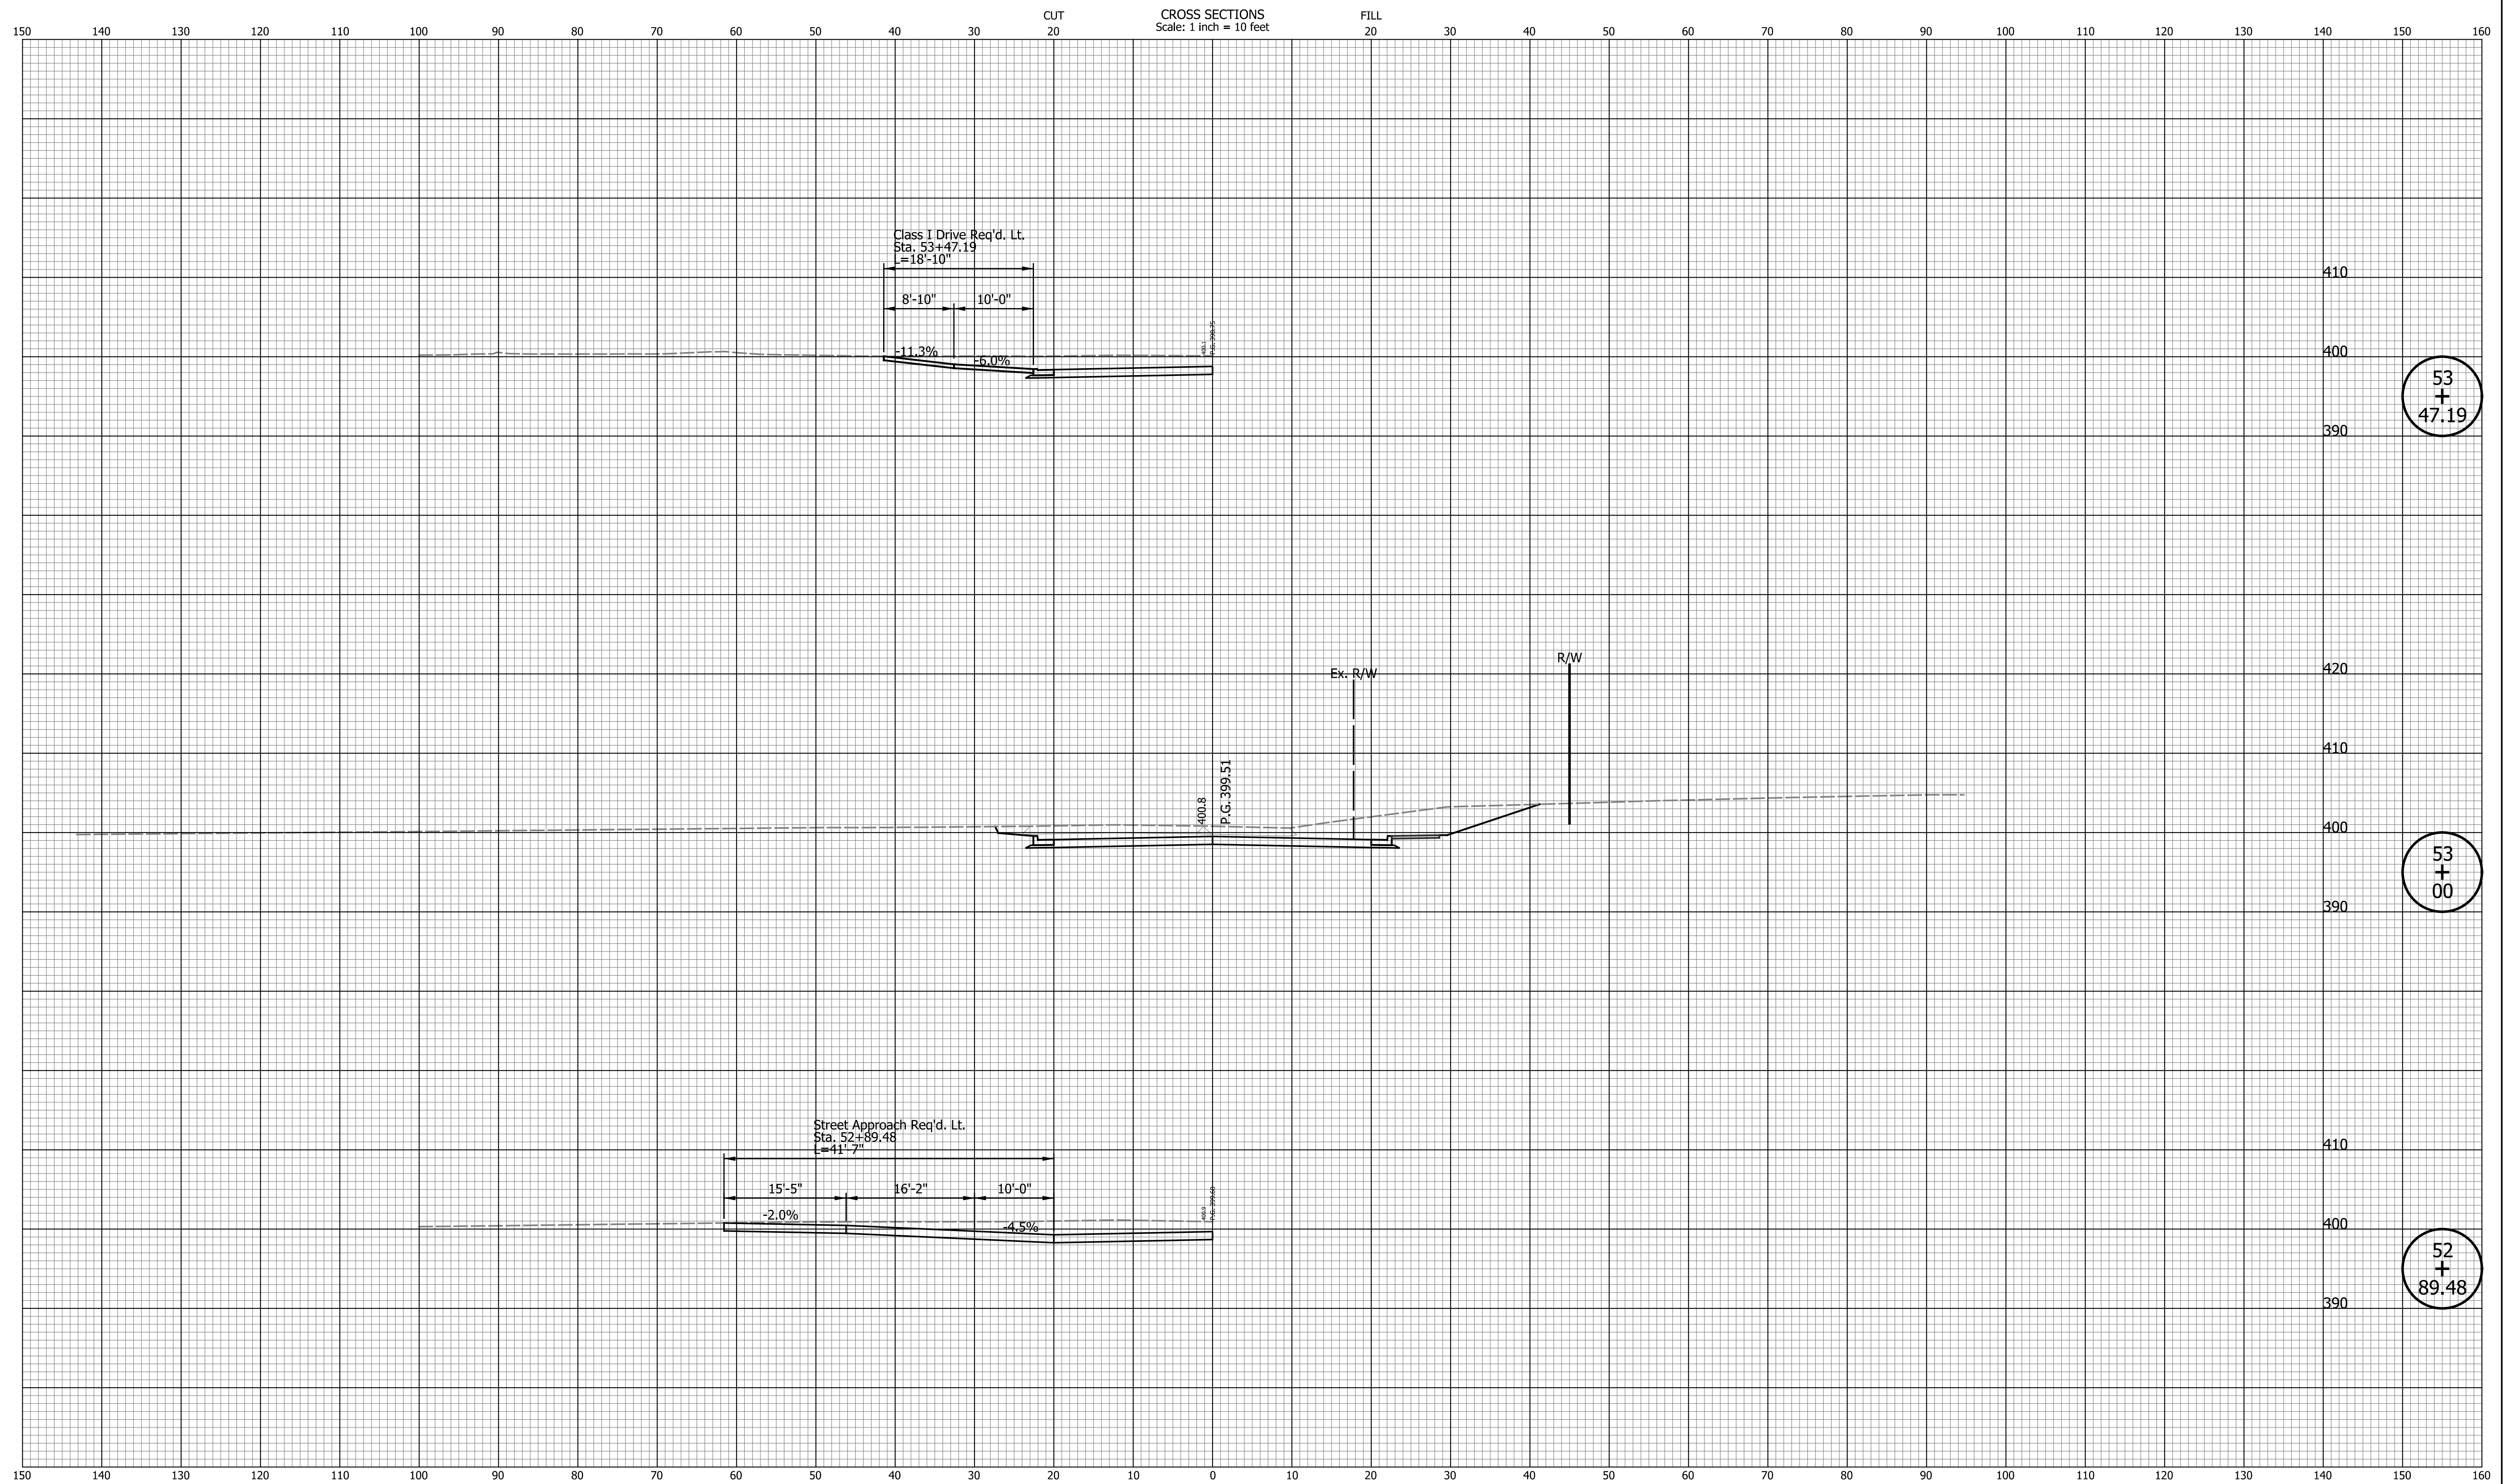52
+
89.48


DATE	REVISION

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DESIGNED: JAB	DRAWN: EAK	
CHECKED: TMS	CHECKED: TMS	

INDIANA DEPARTMENT OF TRANSPORTATION

CROSS SECTIONS LINE "PR-A"

HORIZONTAL SCALE	BRIDGE FILE
1" = 10'	N/A
VERTICAL SCALE	DESIGNATION
1" = 10'	2002538
SURVEY BOOK	SHEETS
N/A	99 of 117
CONTRACT	PROJECT
R-43470	2002538

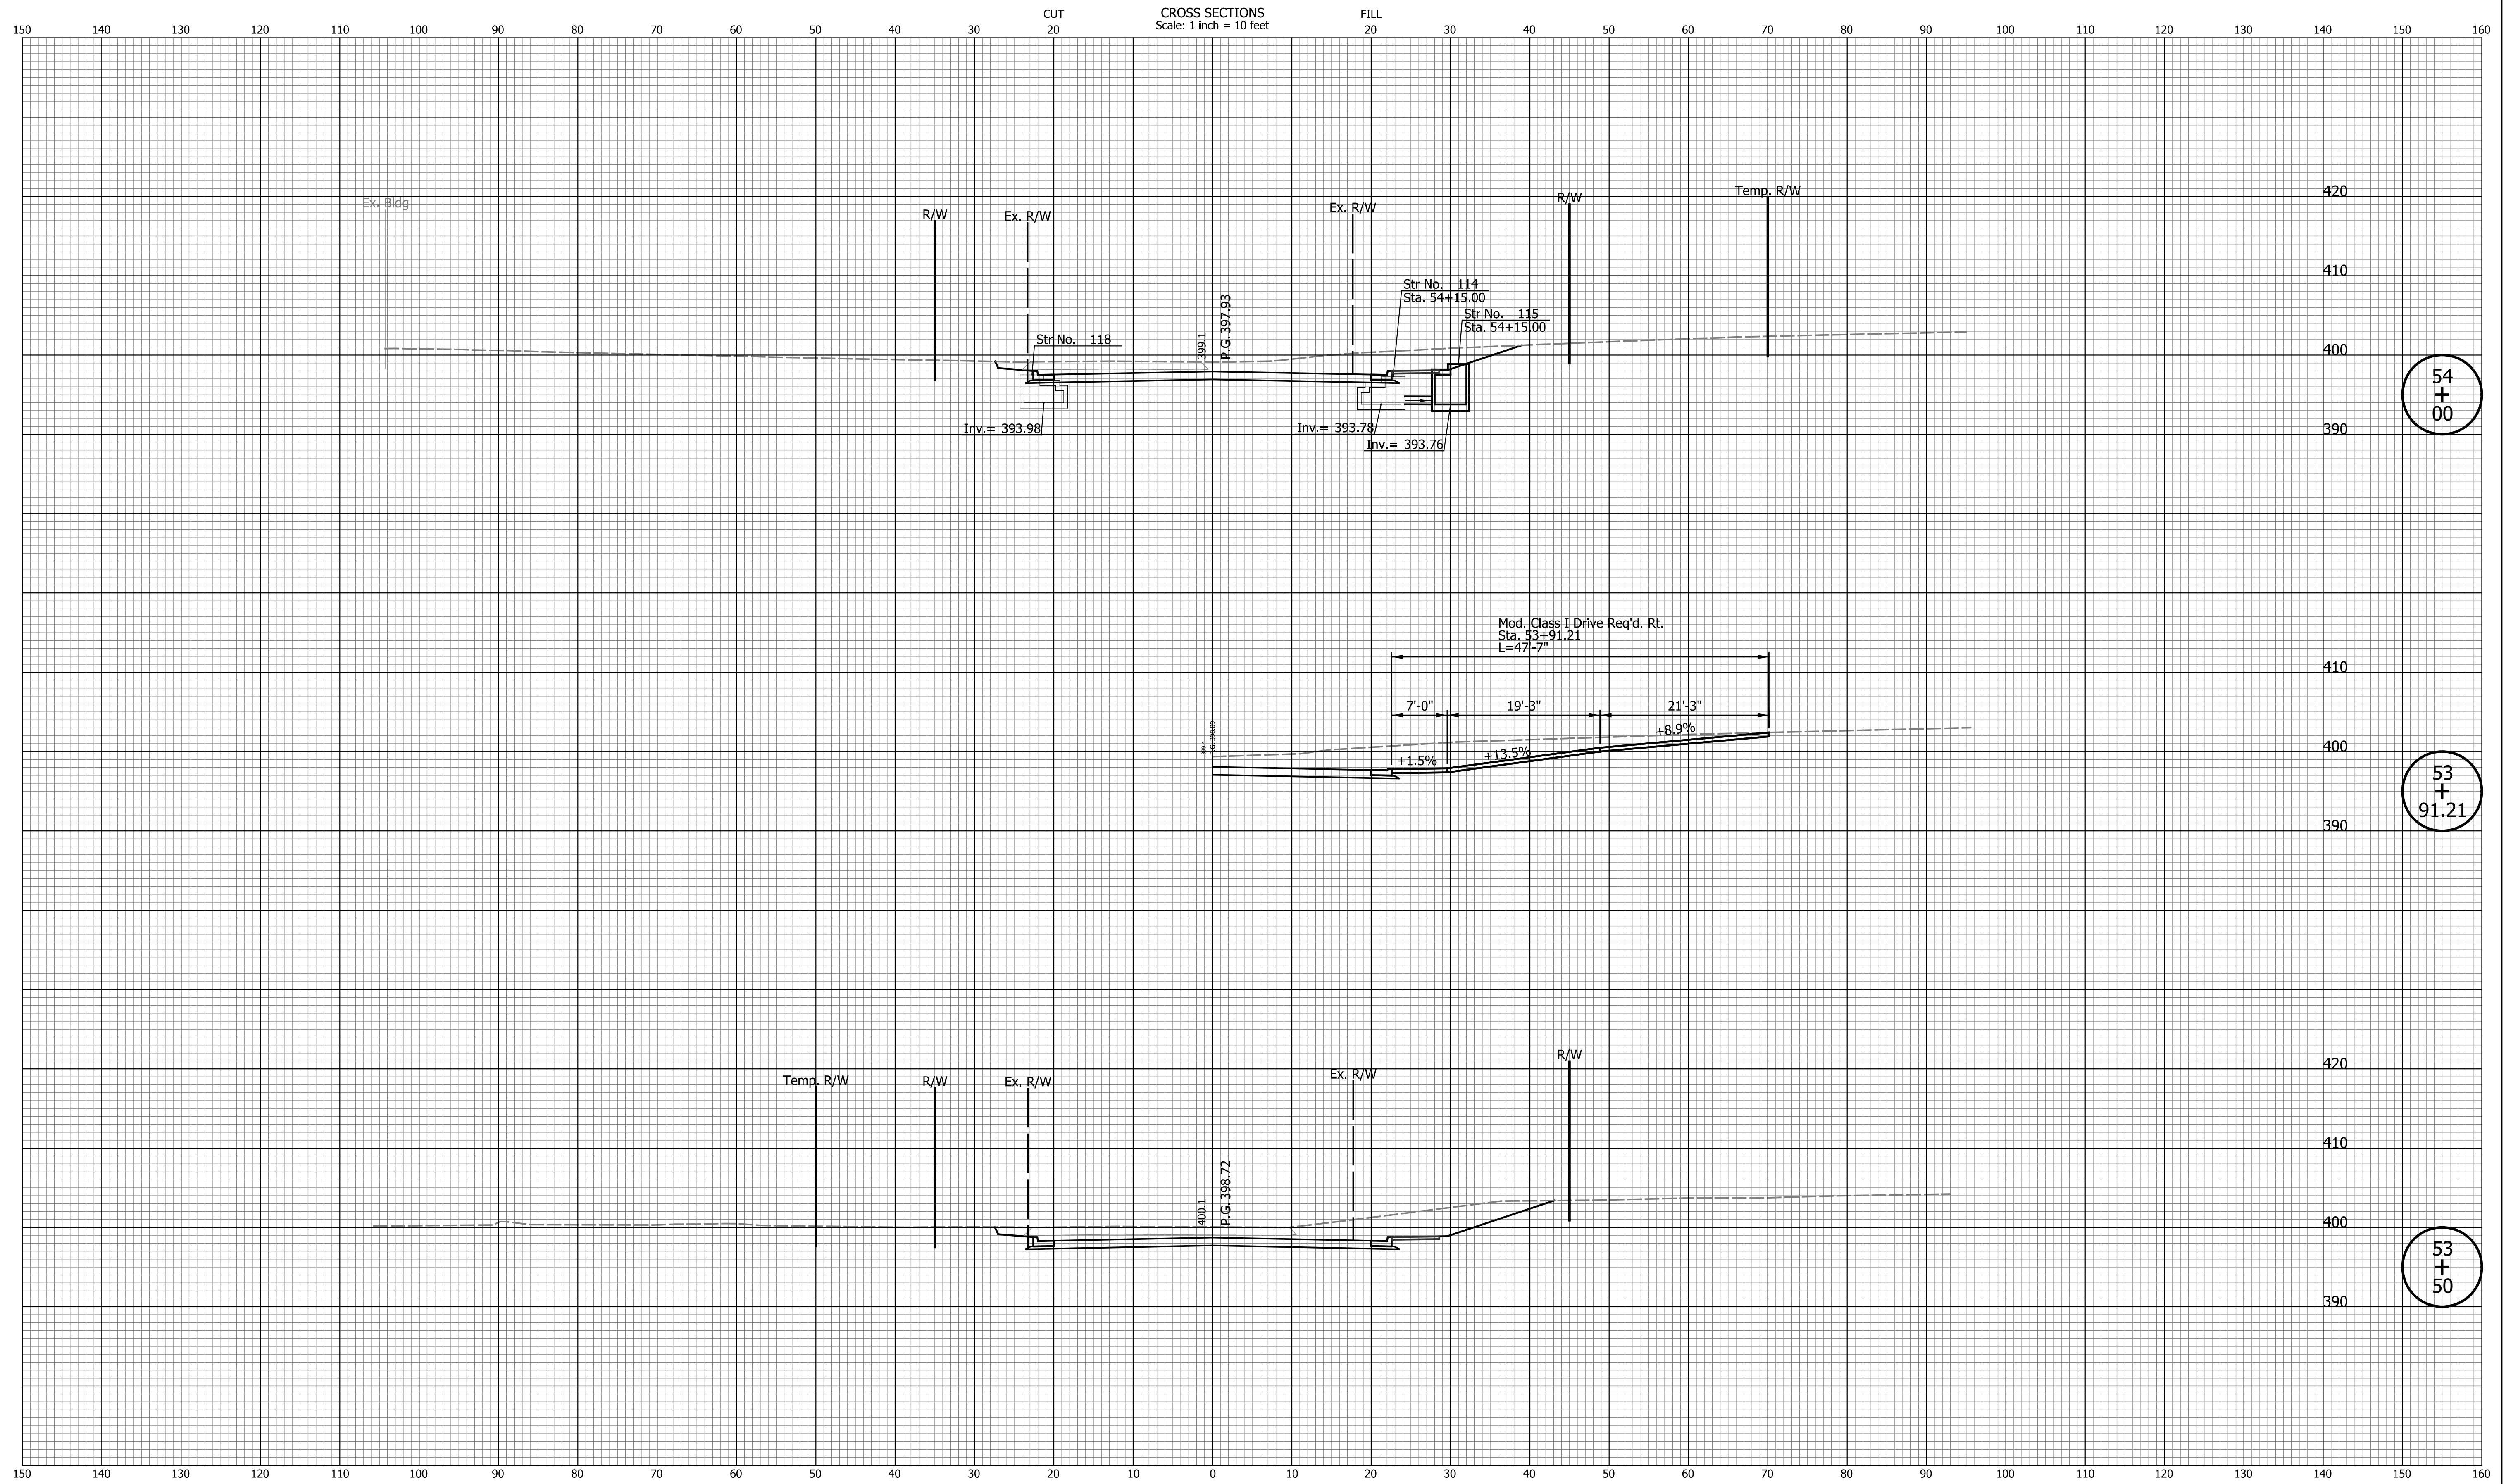

54
+
00

53
+
91.21

53
+
50


DATE	REVISION

RECOMMENDED FOR APPROVAL	DESIGN ENGINEER	DATE
DESIGNED: JAB	DRAWN: EAK	
CHECKED: TMS	CHECKED: TMS	

INDIANA DEPARTMENT OF TRANSPORTATION

CROSS SECTIONS LINE "PR-A"

HORIZONTAL SCALE	BRIDGE FILE
1" = 10'	N/A
VERTICAL SCALE	DESIGNATION
1" = 10'	2002538
SURVEY BOOK	SHEETS
N/A	100 of 117
CONTRACT	PROJECT
R-43470	2002538

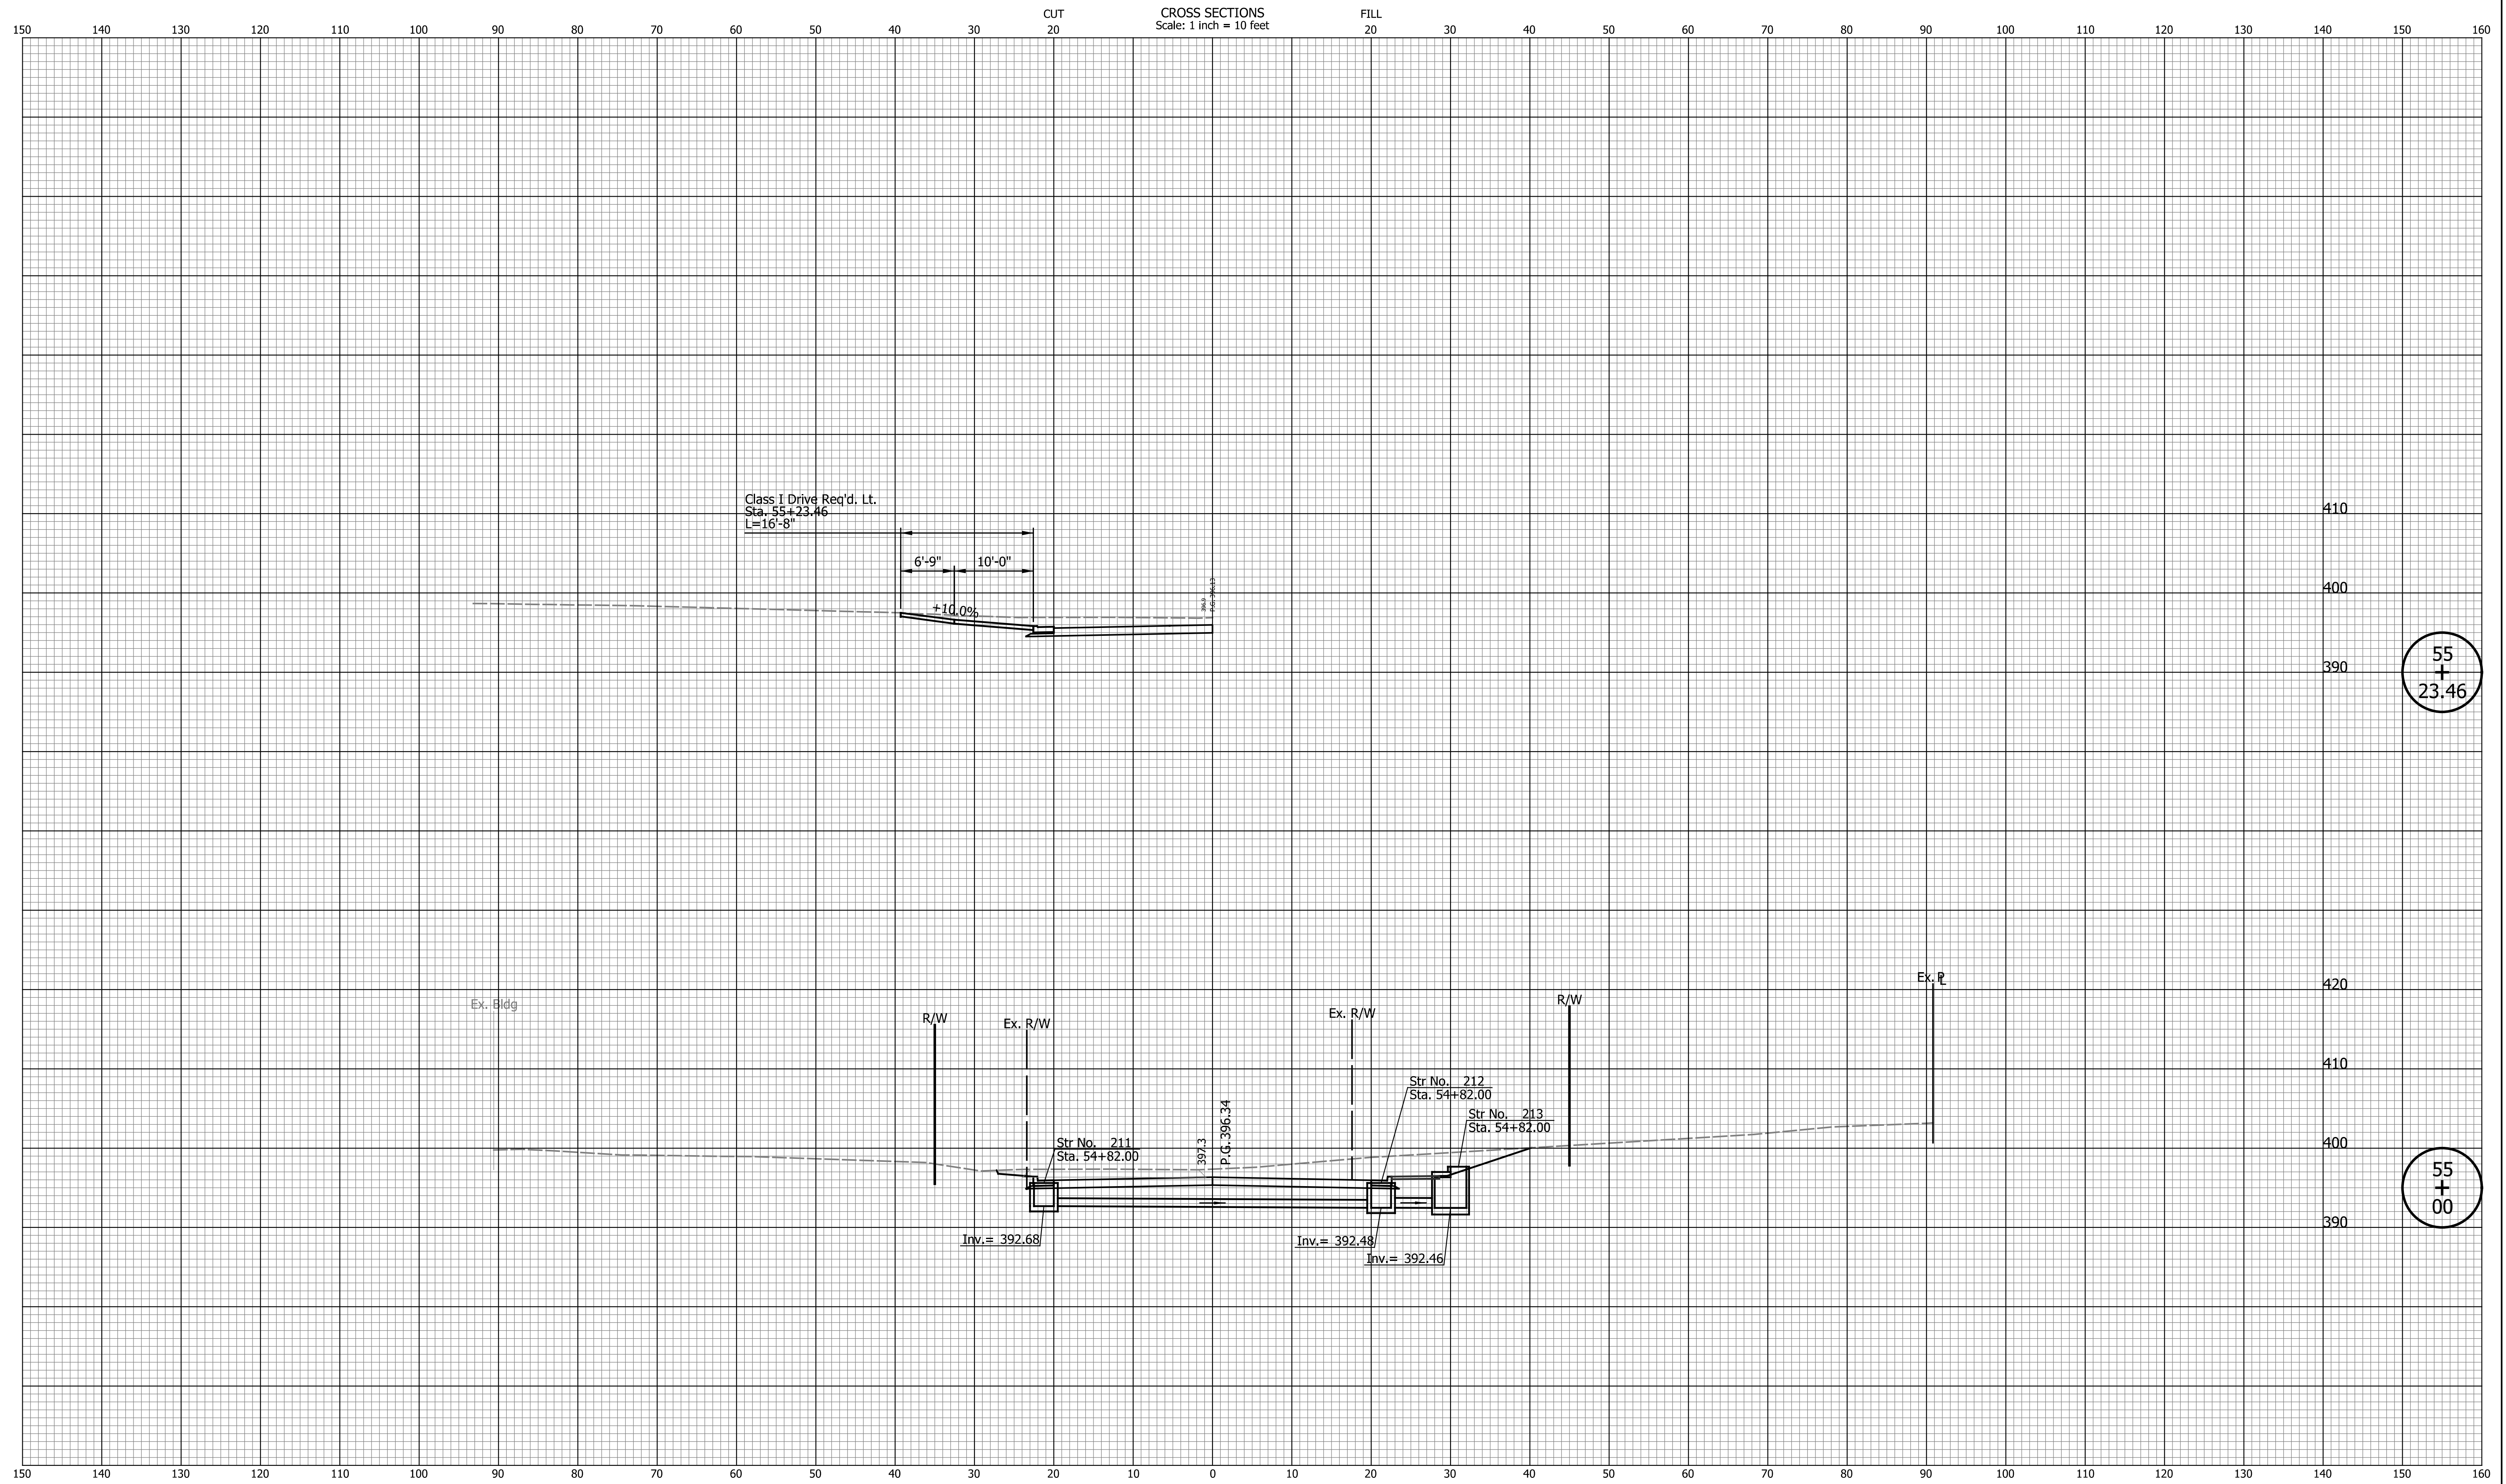

DATE	REVISION


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INDIANA DEPARTMENT OF TRANSPORTATION

CROSS SECTIONS LINE "PR-A"

HORIZONTAL SCALE	BRIDGE FILE
1" = 10'	N/A
VERTICAL SCALE	DESIGNATION
1" = 10'	2002538
SURVEY BOOK	SHEETS
N/A	102 of 117
CONTRACT	PROJECT
R-43470	2002538

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DATE	REVISION


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INDIANA DEPARTMENT OF TRANSPORTATION

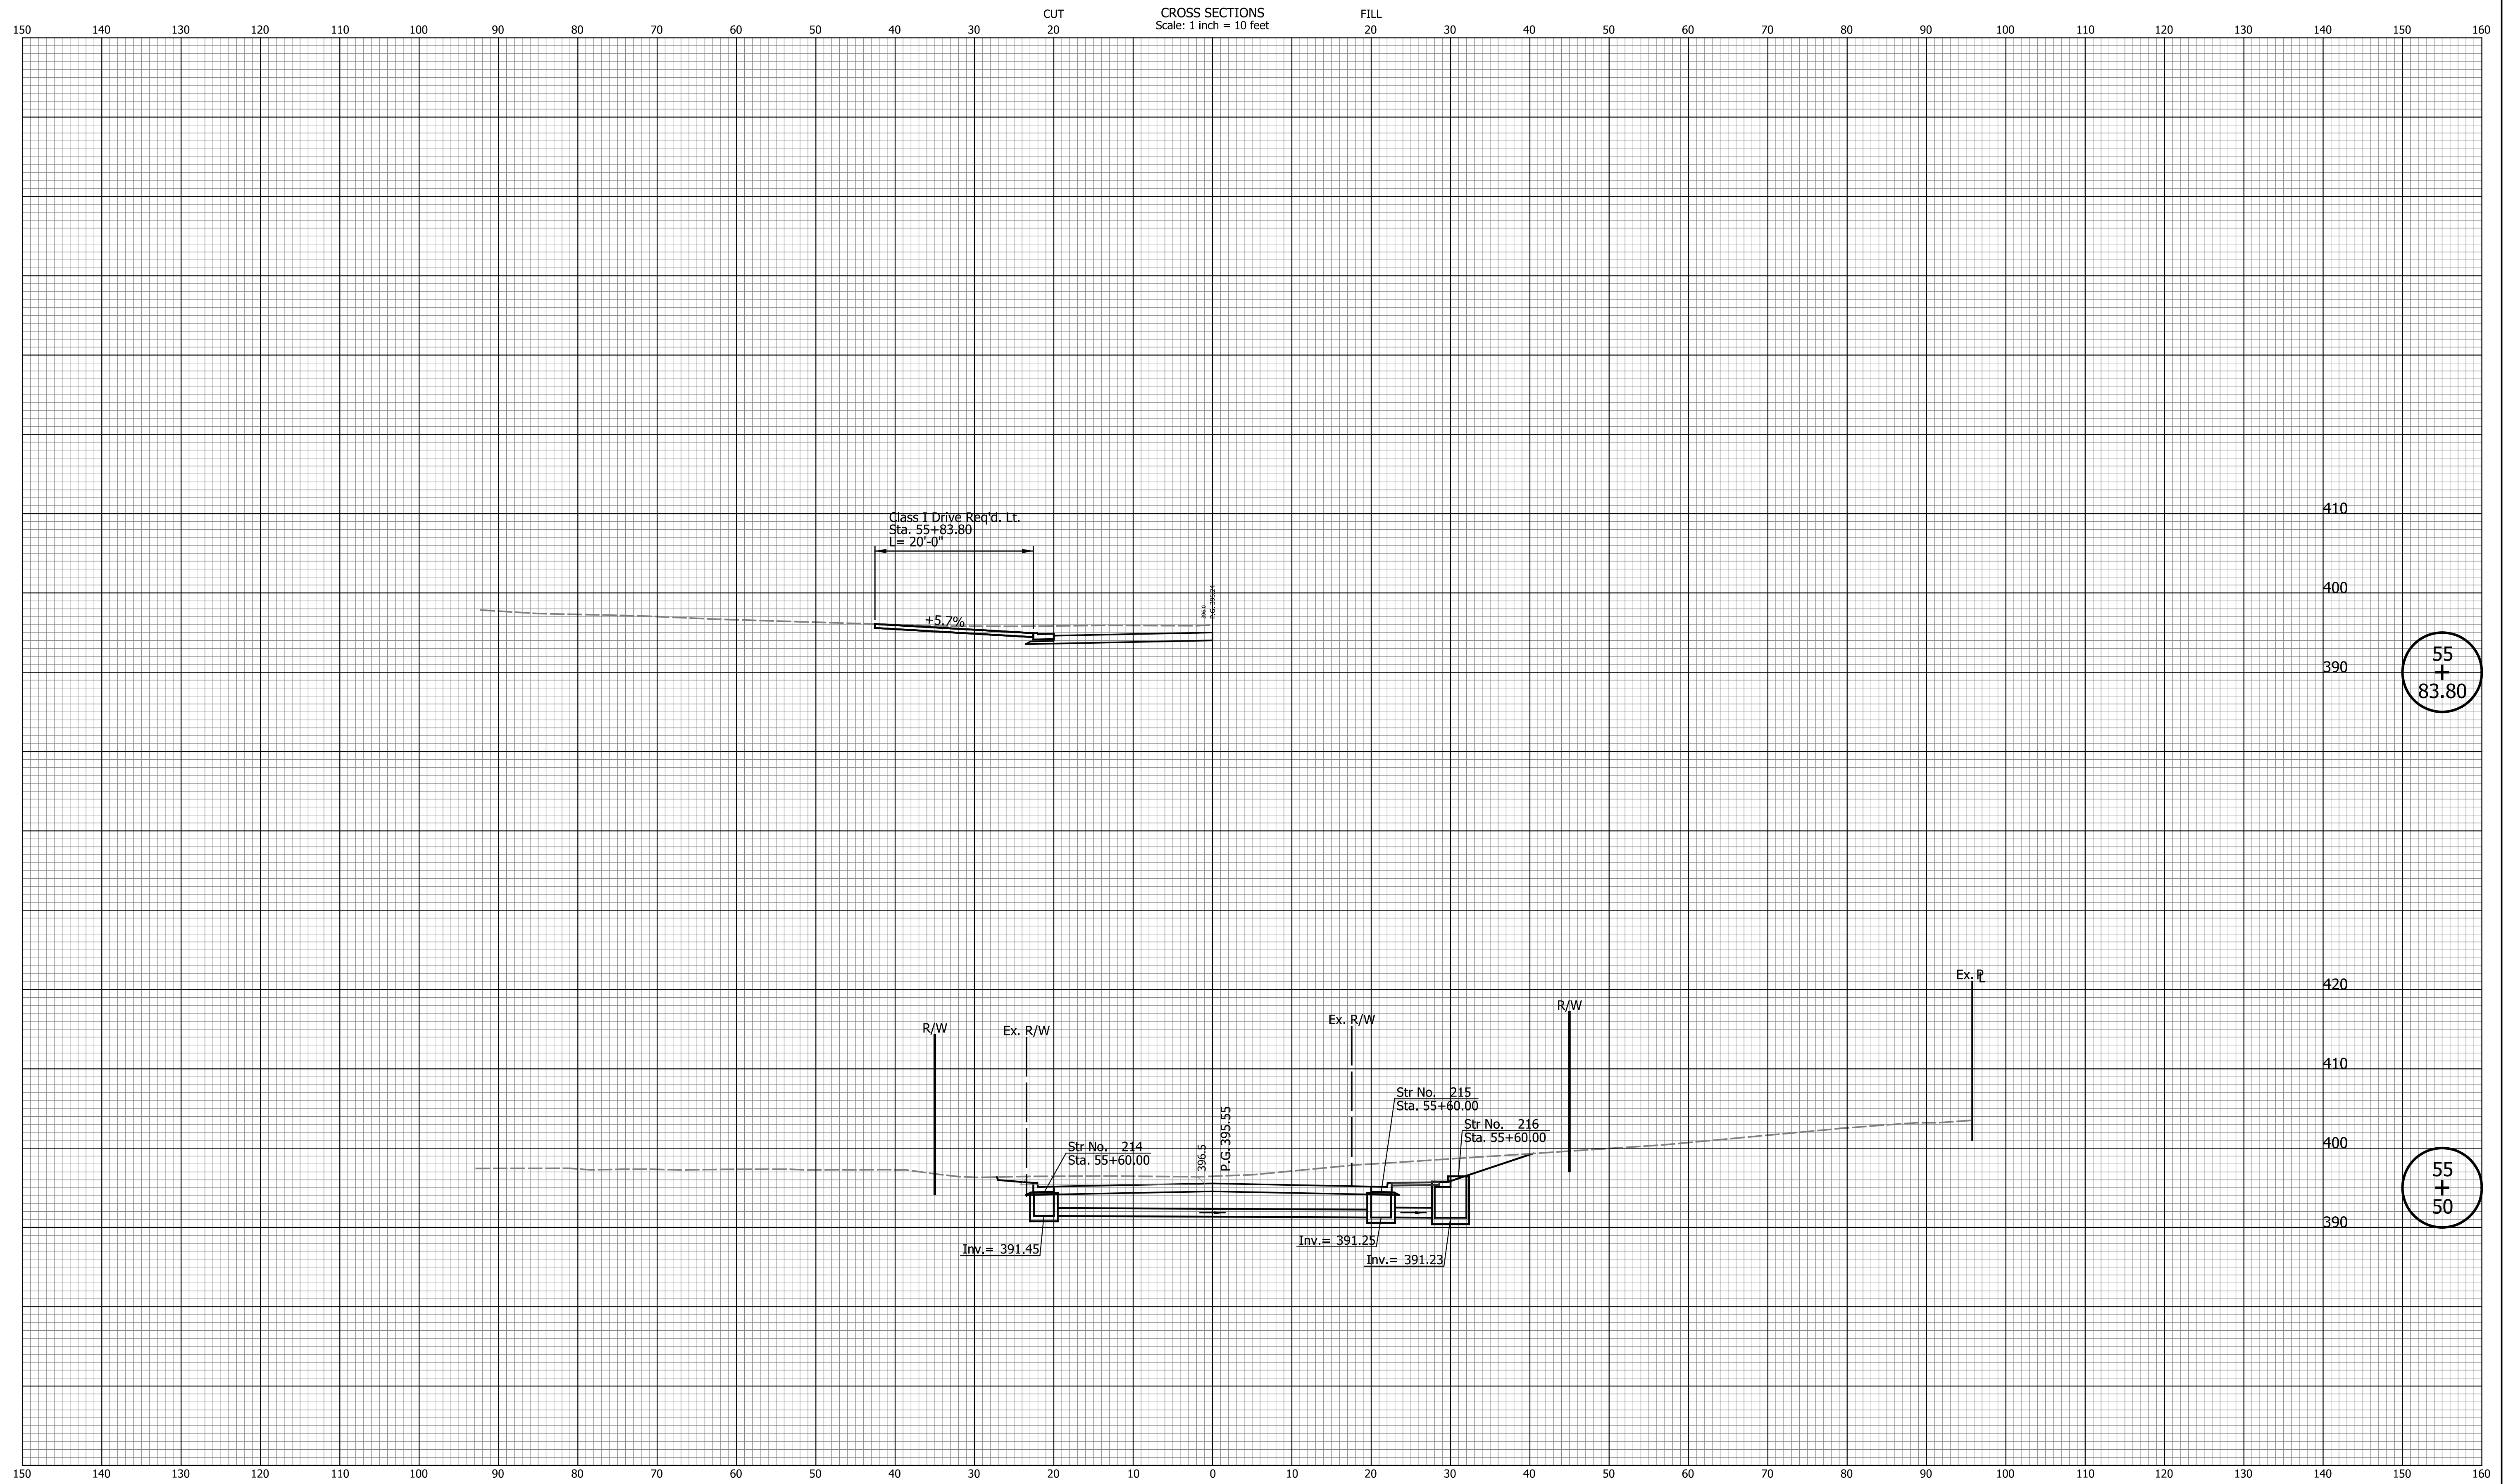CROSS SECTIONS LINE "PR-A"

HORIZONTAL SCALE	BRIDGE FILE
1" = 10'	N/A
VERTICAL SCALE	DESIGNATION
1" = 10'	2002538
SURVEY BOOK	SHEETS
N/A	103 of 117
CONTRACT	PROJECT
R-43470	2002538

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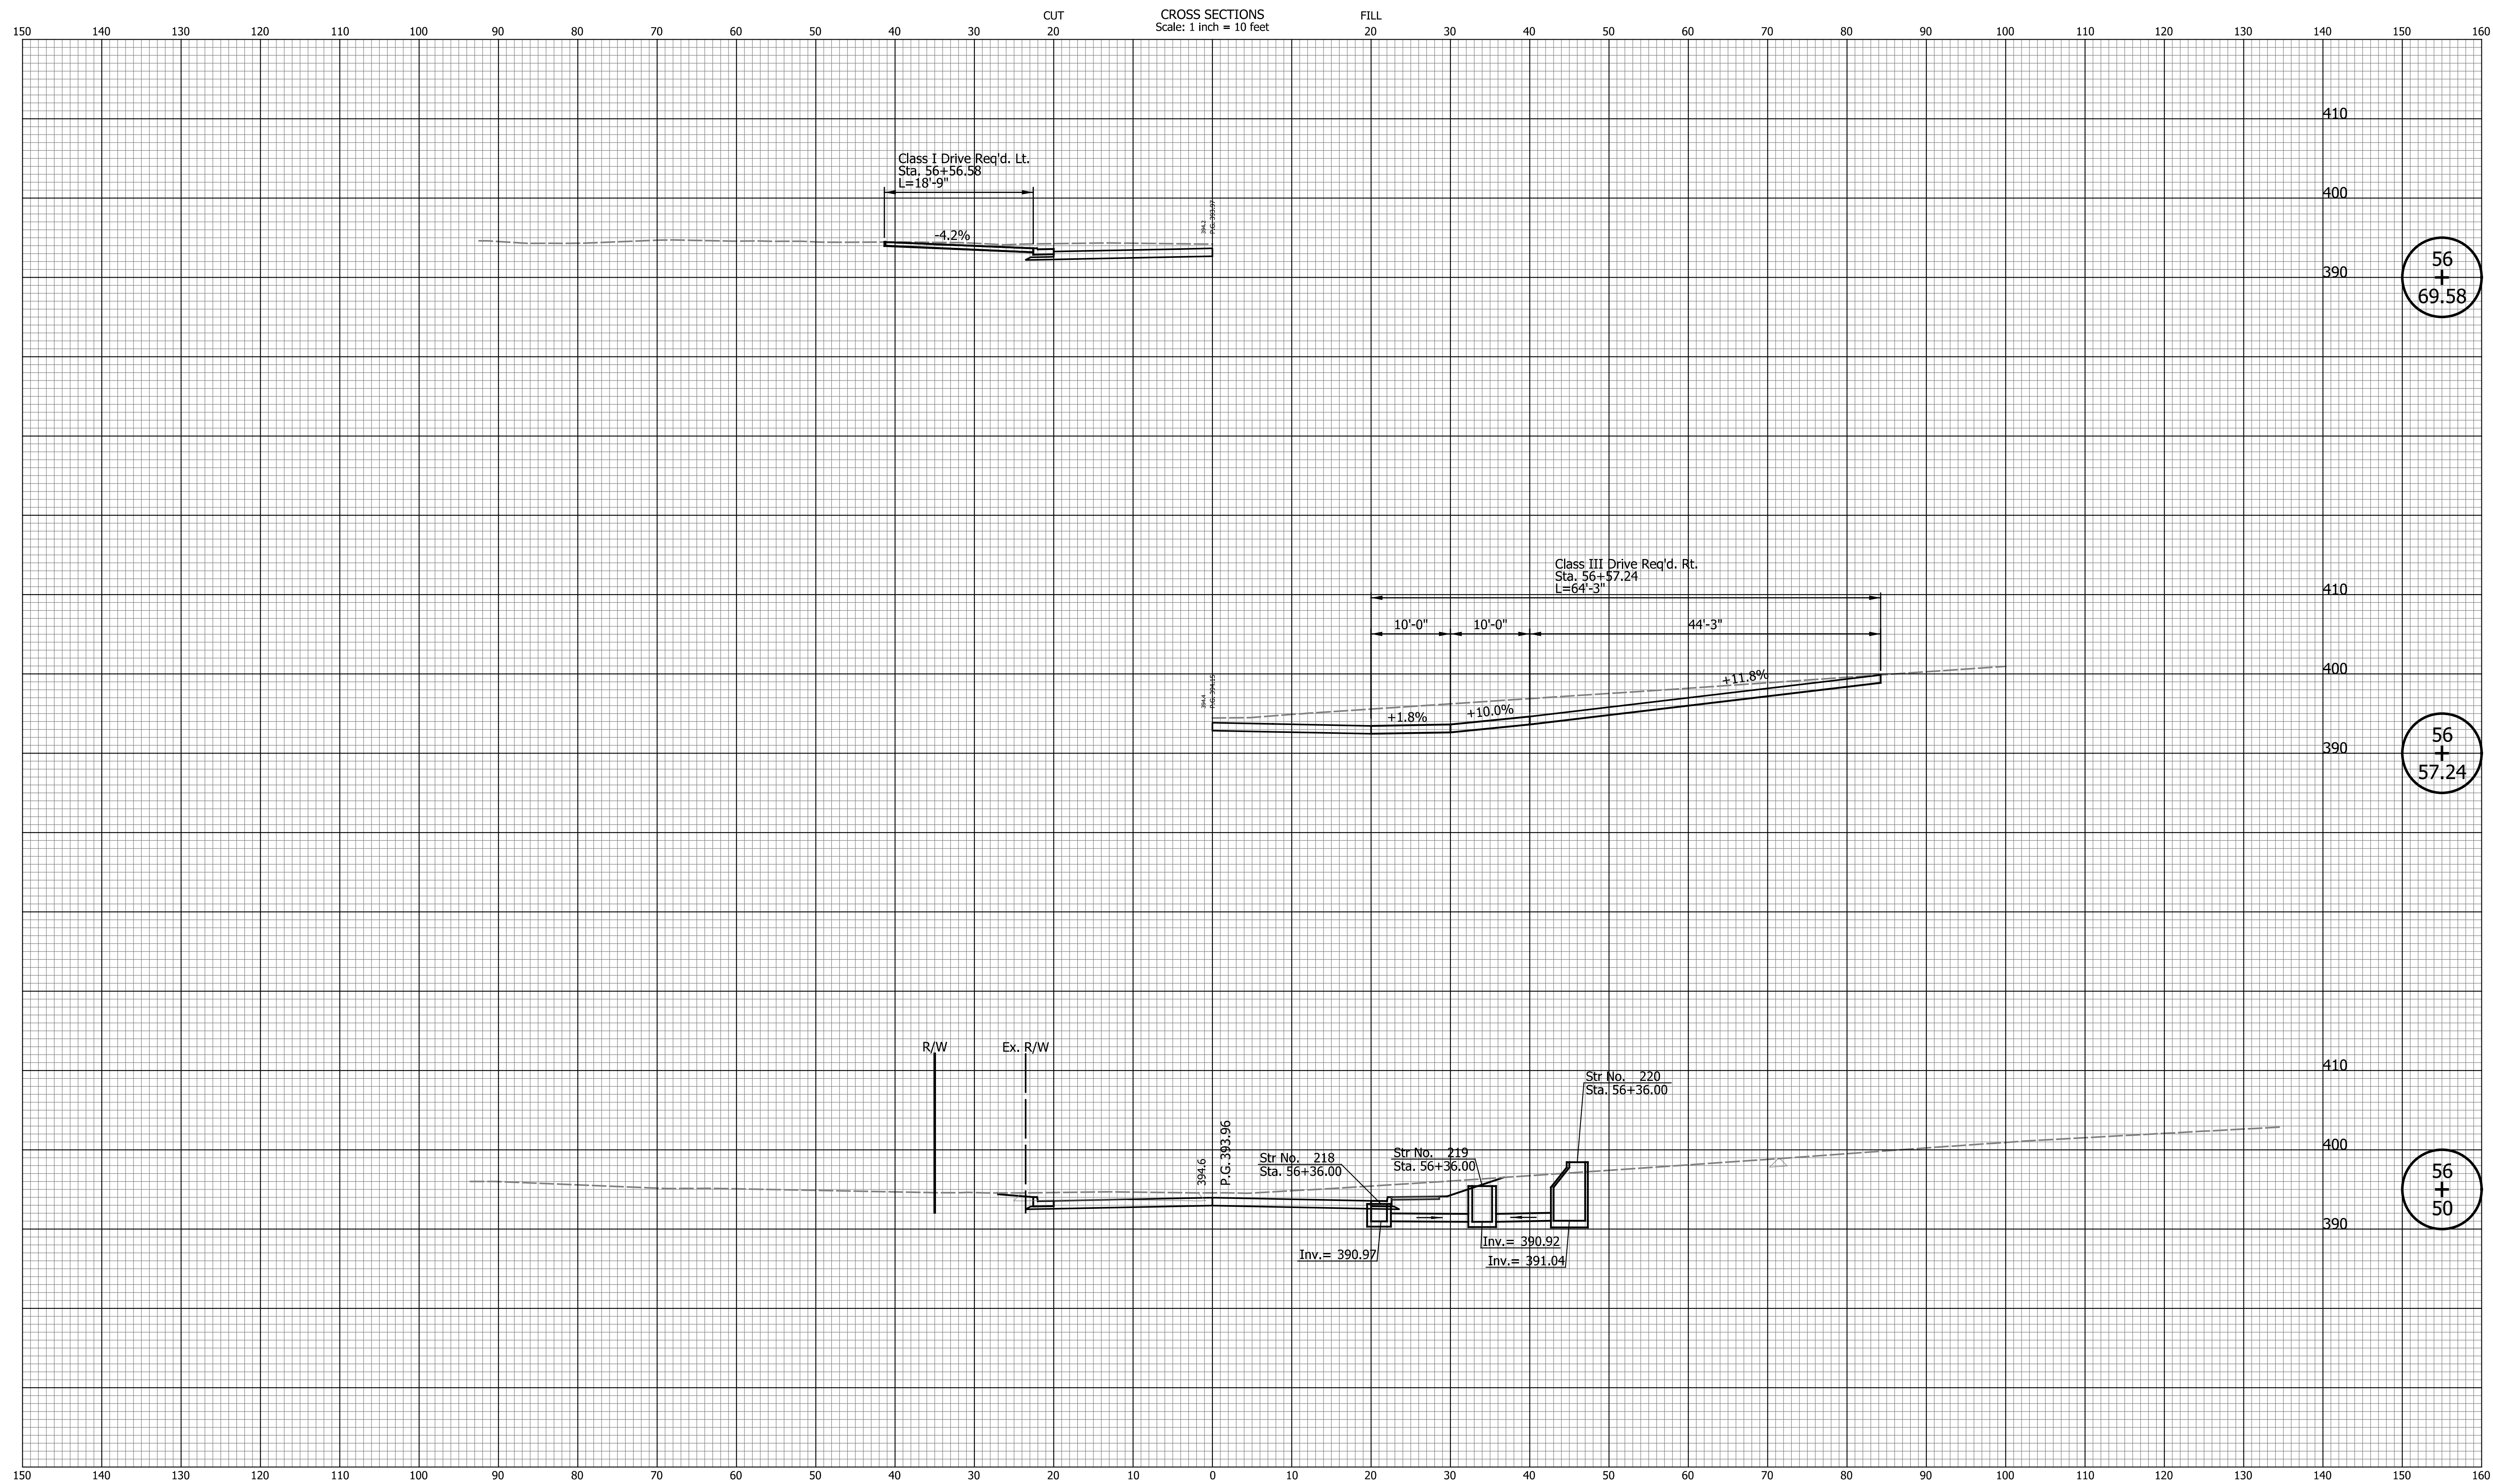
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INDIANA DEPARTMENT OF TRANSPORTATION

CROSS SECTIONS LINE "PR-A"

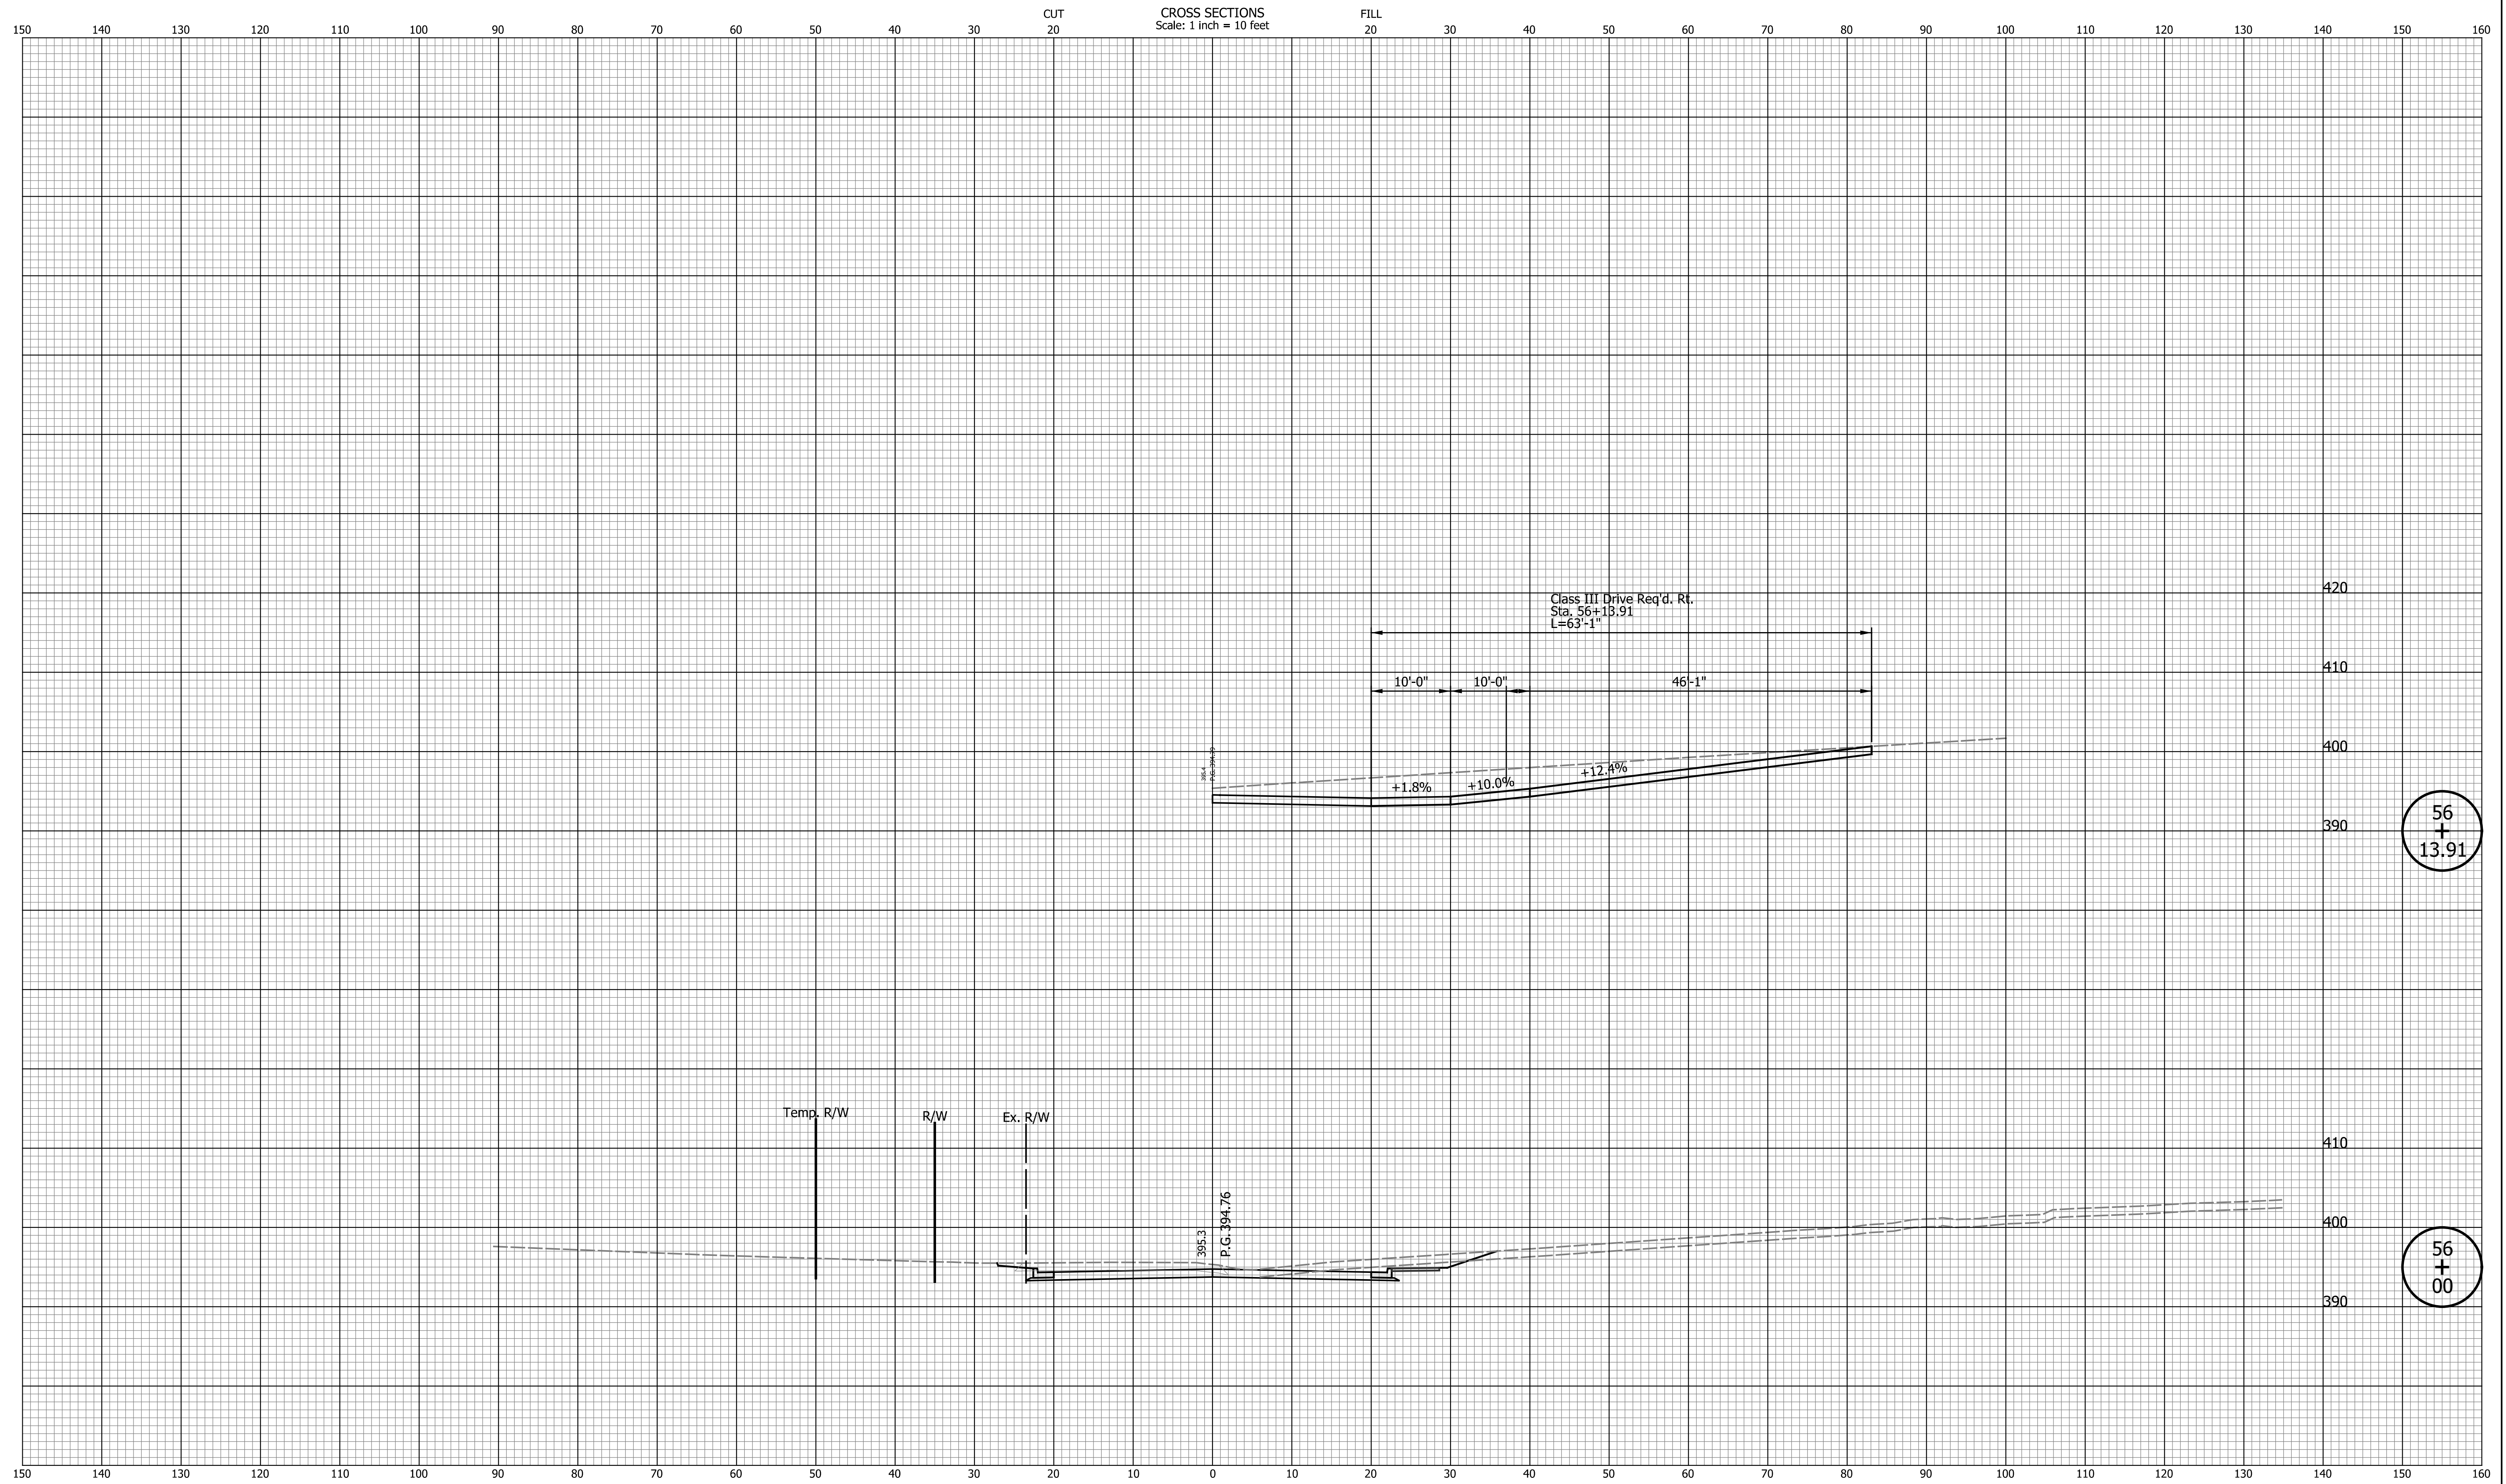HORIZONTAL SCALE	BRIDGE FILE
1" = 10'	N/A
VERTICAL SCALE	DESIGNATION
1" = 10'	2002538
SURVEY BOOK	SHEETS
N/A	104 of 117
CONTRACT	PROJECT
R-43470	2002538



DATE	REVISION


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INDIANA DEPARTMENT OF TRANSPORTATION

CROSS SECTIONS LINE "PR-A"

HORIZONTAL SCALE	BRIDGE FILE
1" = 10'	N/A
VERTICAL SCALE	DESIGNATION
1" = 10'	2002538
SURVEY BOOK	SHEETS
N/A	105 of 117
CONTRACT	PROJECT
R-43470	2002538

Indiana State

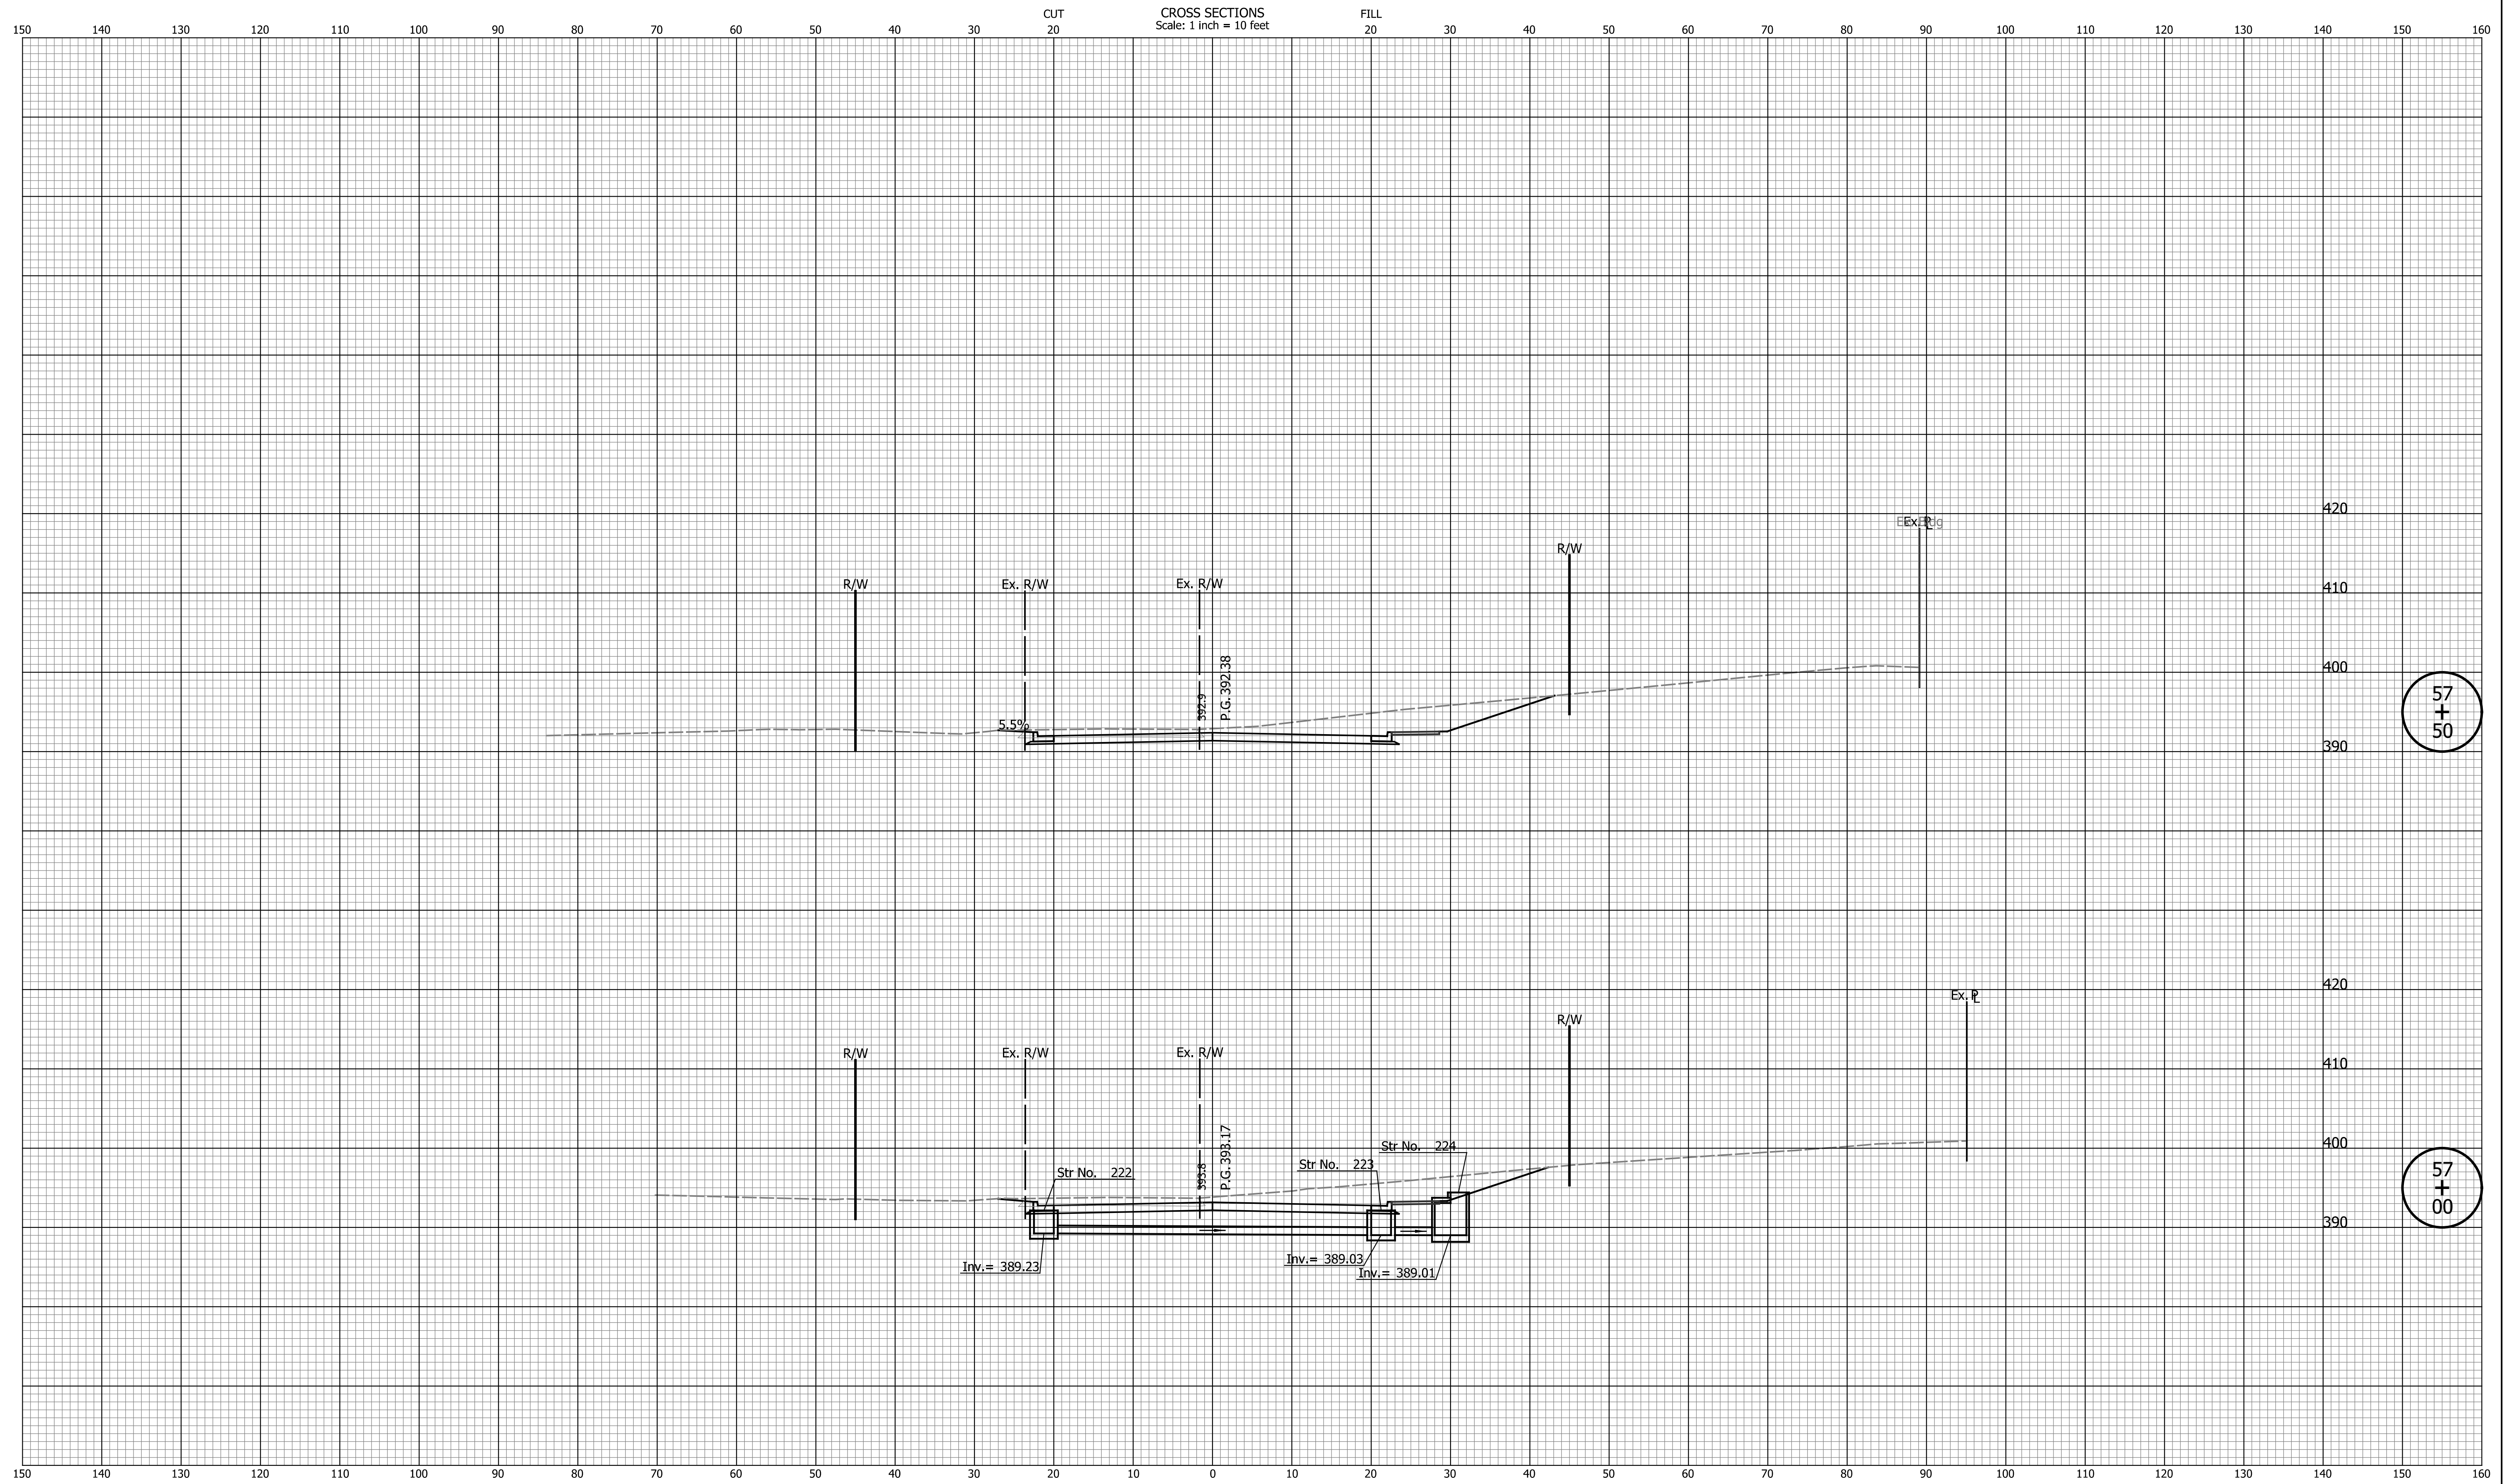

DATE	REVISION


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INDIANA DEPARTMENT OF TRANSPORTATION

CROSS SECTIONS LINE "PR-A"

HORIZONTAL SCALE 1" = 10'	BRIDGE FILE N/A
VERTICAL SCALE 1" = 10'	DESIGNATION 2002538
SURVEY BOOK N/A	SHEETS 106 of 117
CONTRACT R-43470	PROJECT 2002538

Indiana State

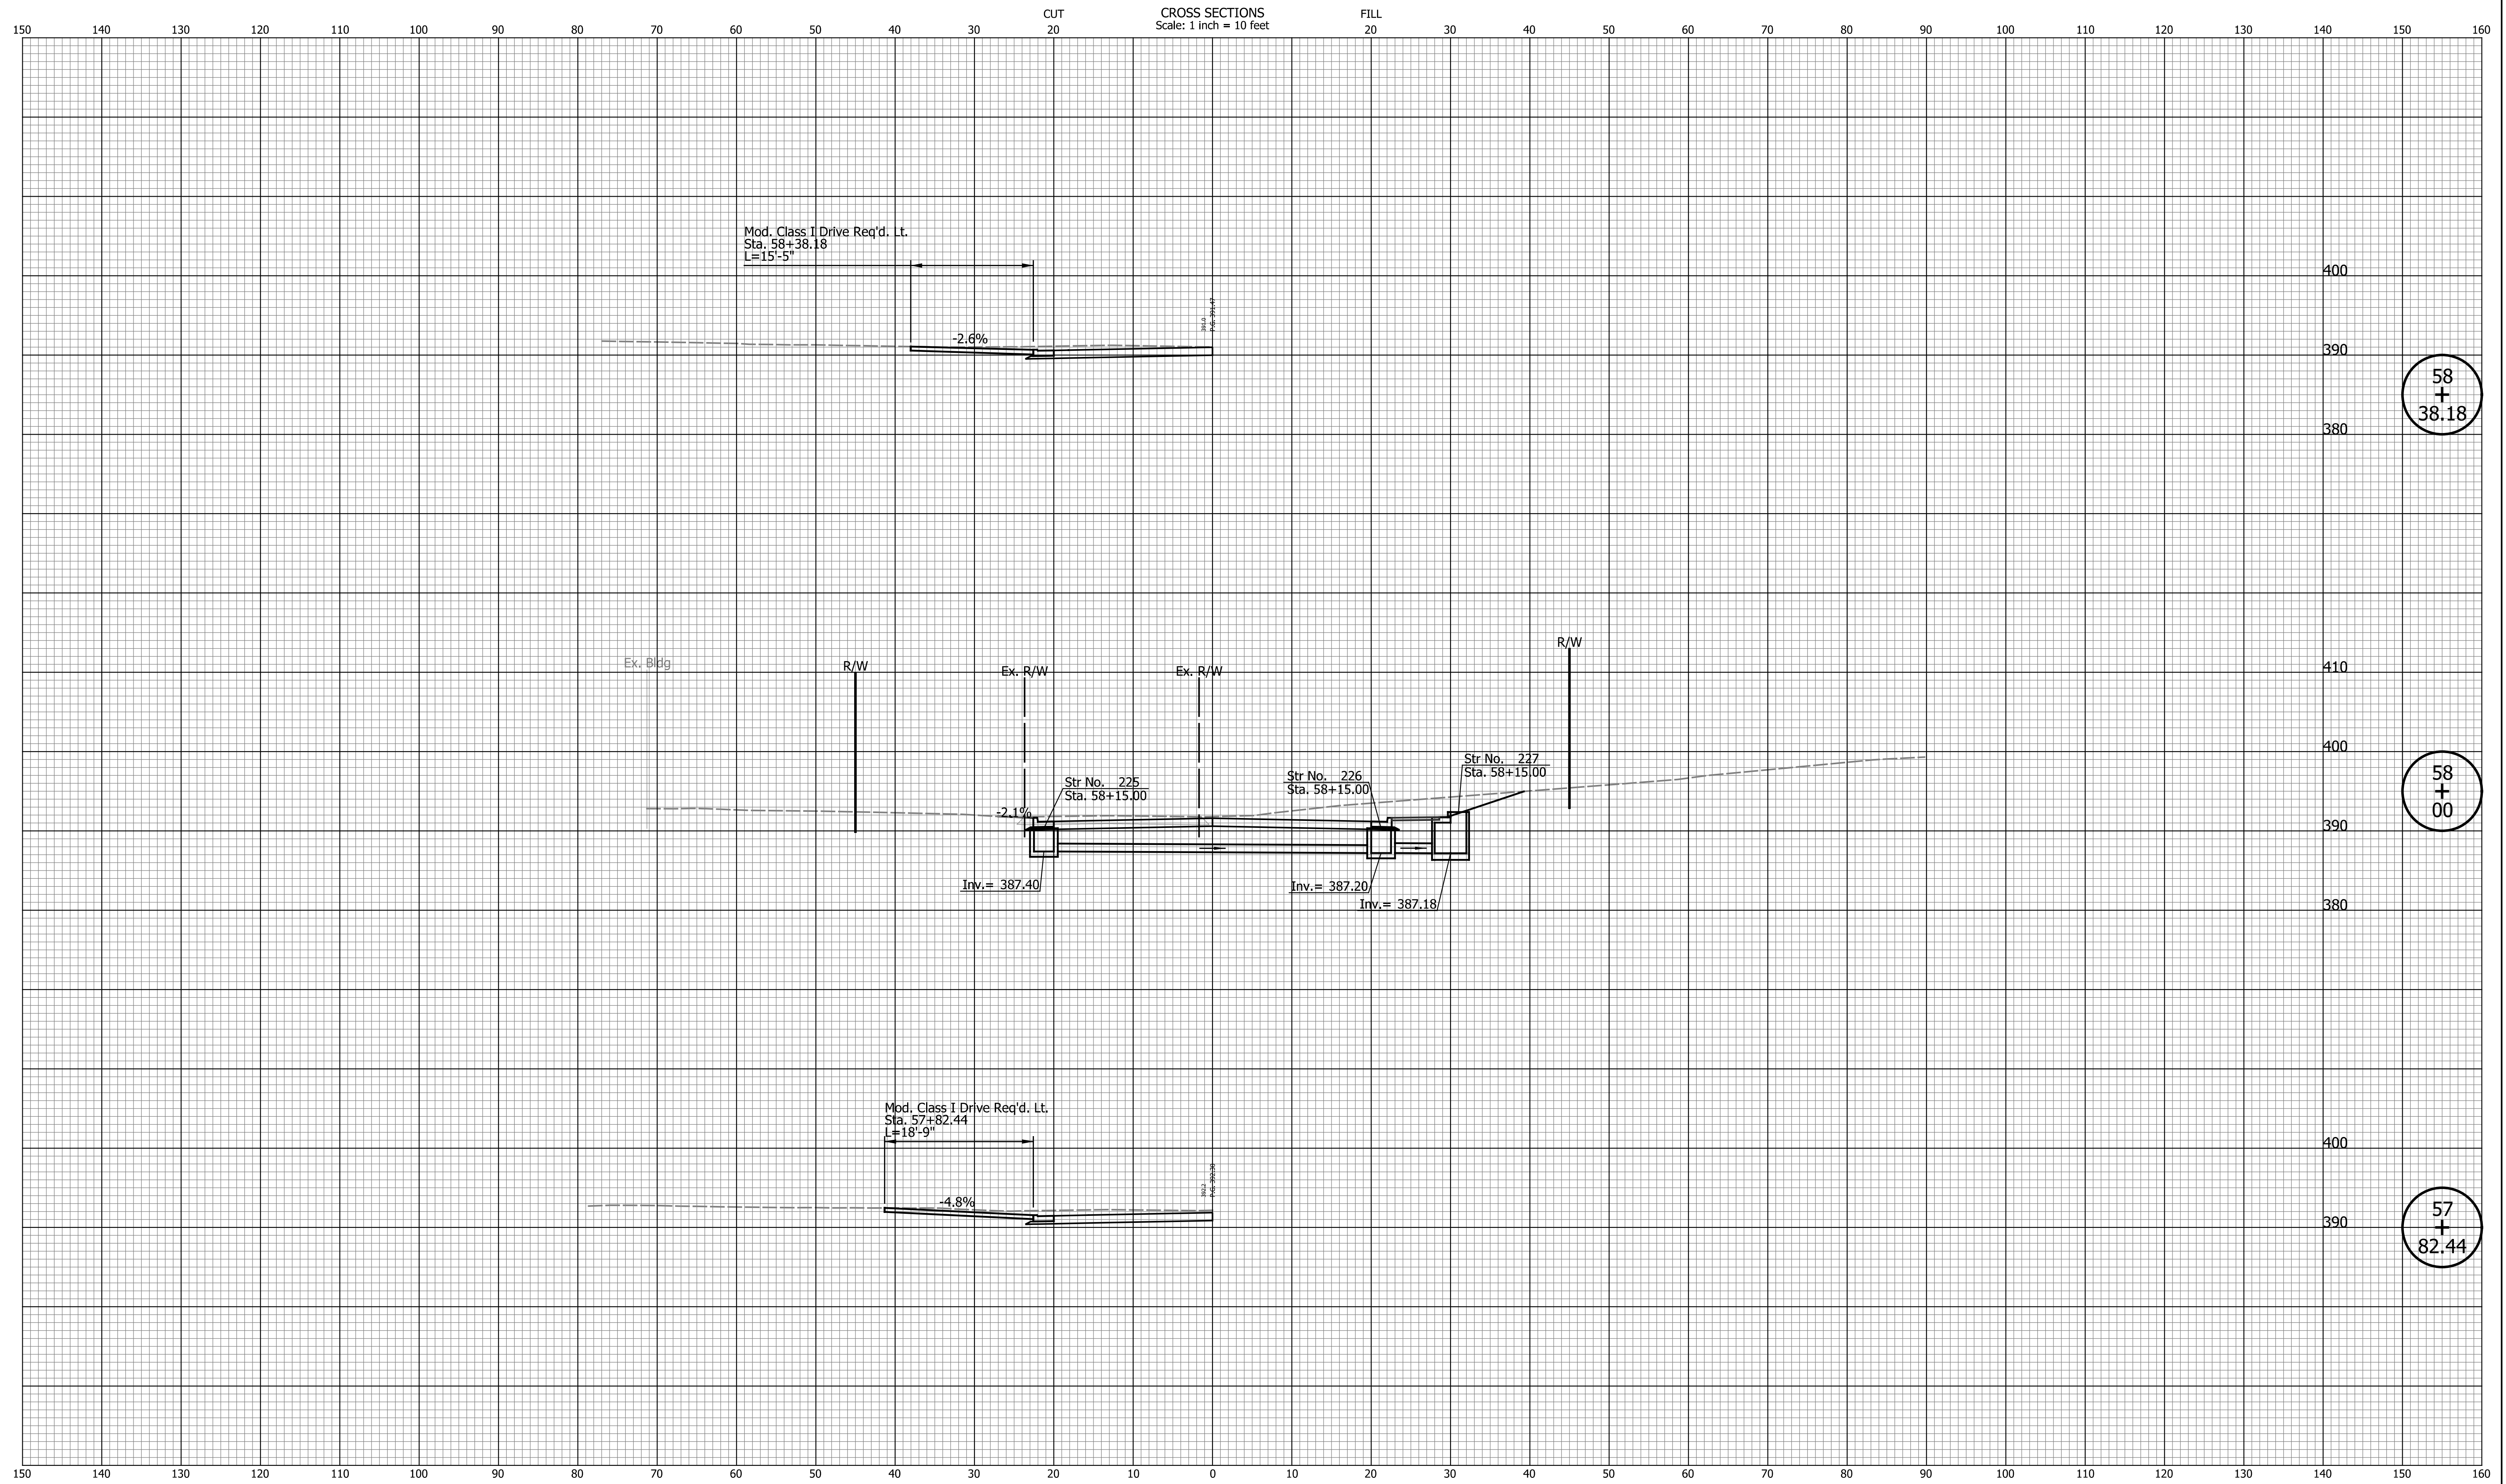

DATE	REVISION


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DESIGNED: JAB	DRAWN: EAK	
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INDIANA DEPARTMENT OF TRANSPORTATION

CROSS SECTIONS LINE "PR-A"

HORIZONTAL SCALE	BRIDGE FILE
1" = 10'	N/A
VERTICAL SCALE	DESIGNATION
1" = 10'	2002538
SURVEY BOOK	SHEETS
N/A	107 of 117
CONTRACT	PROJECT
R-43470	2002538

Indiana State

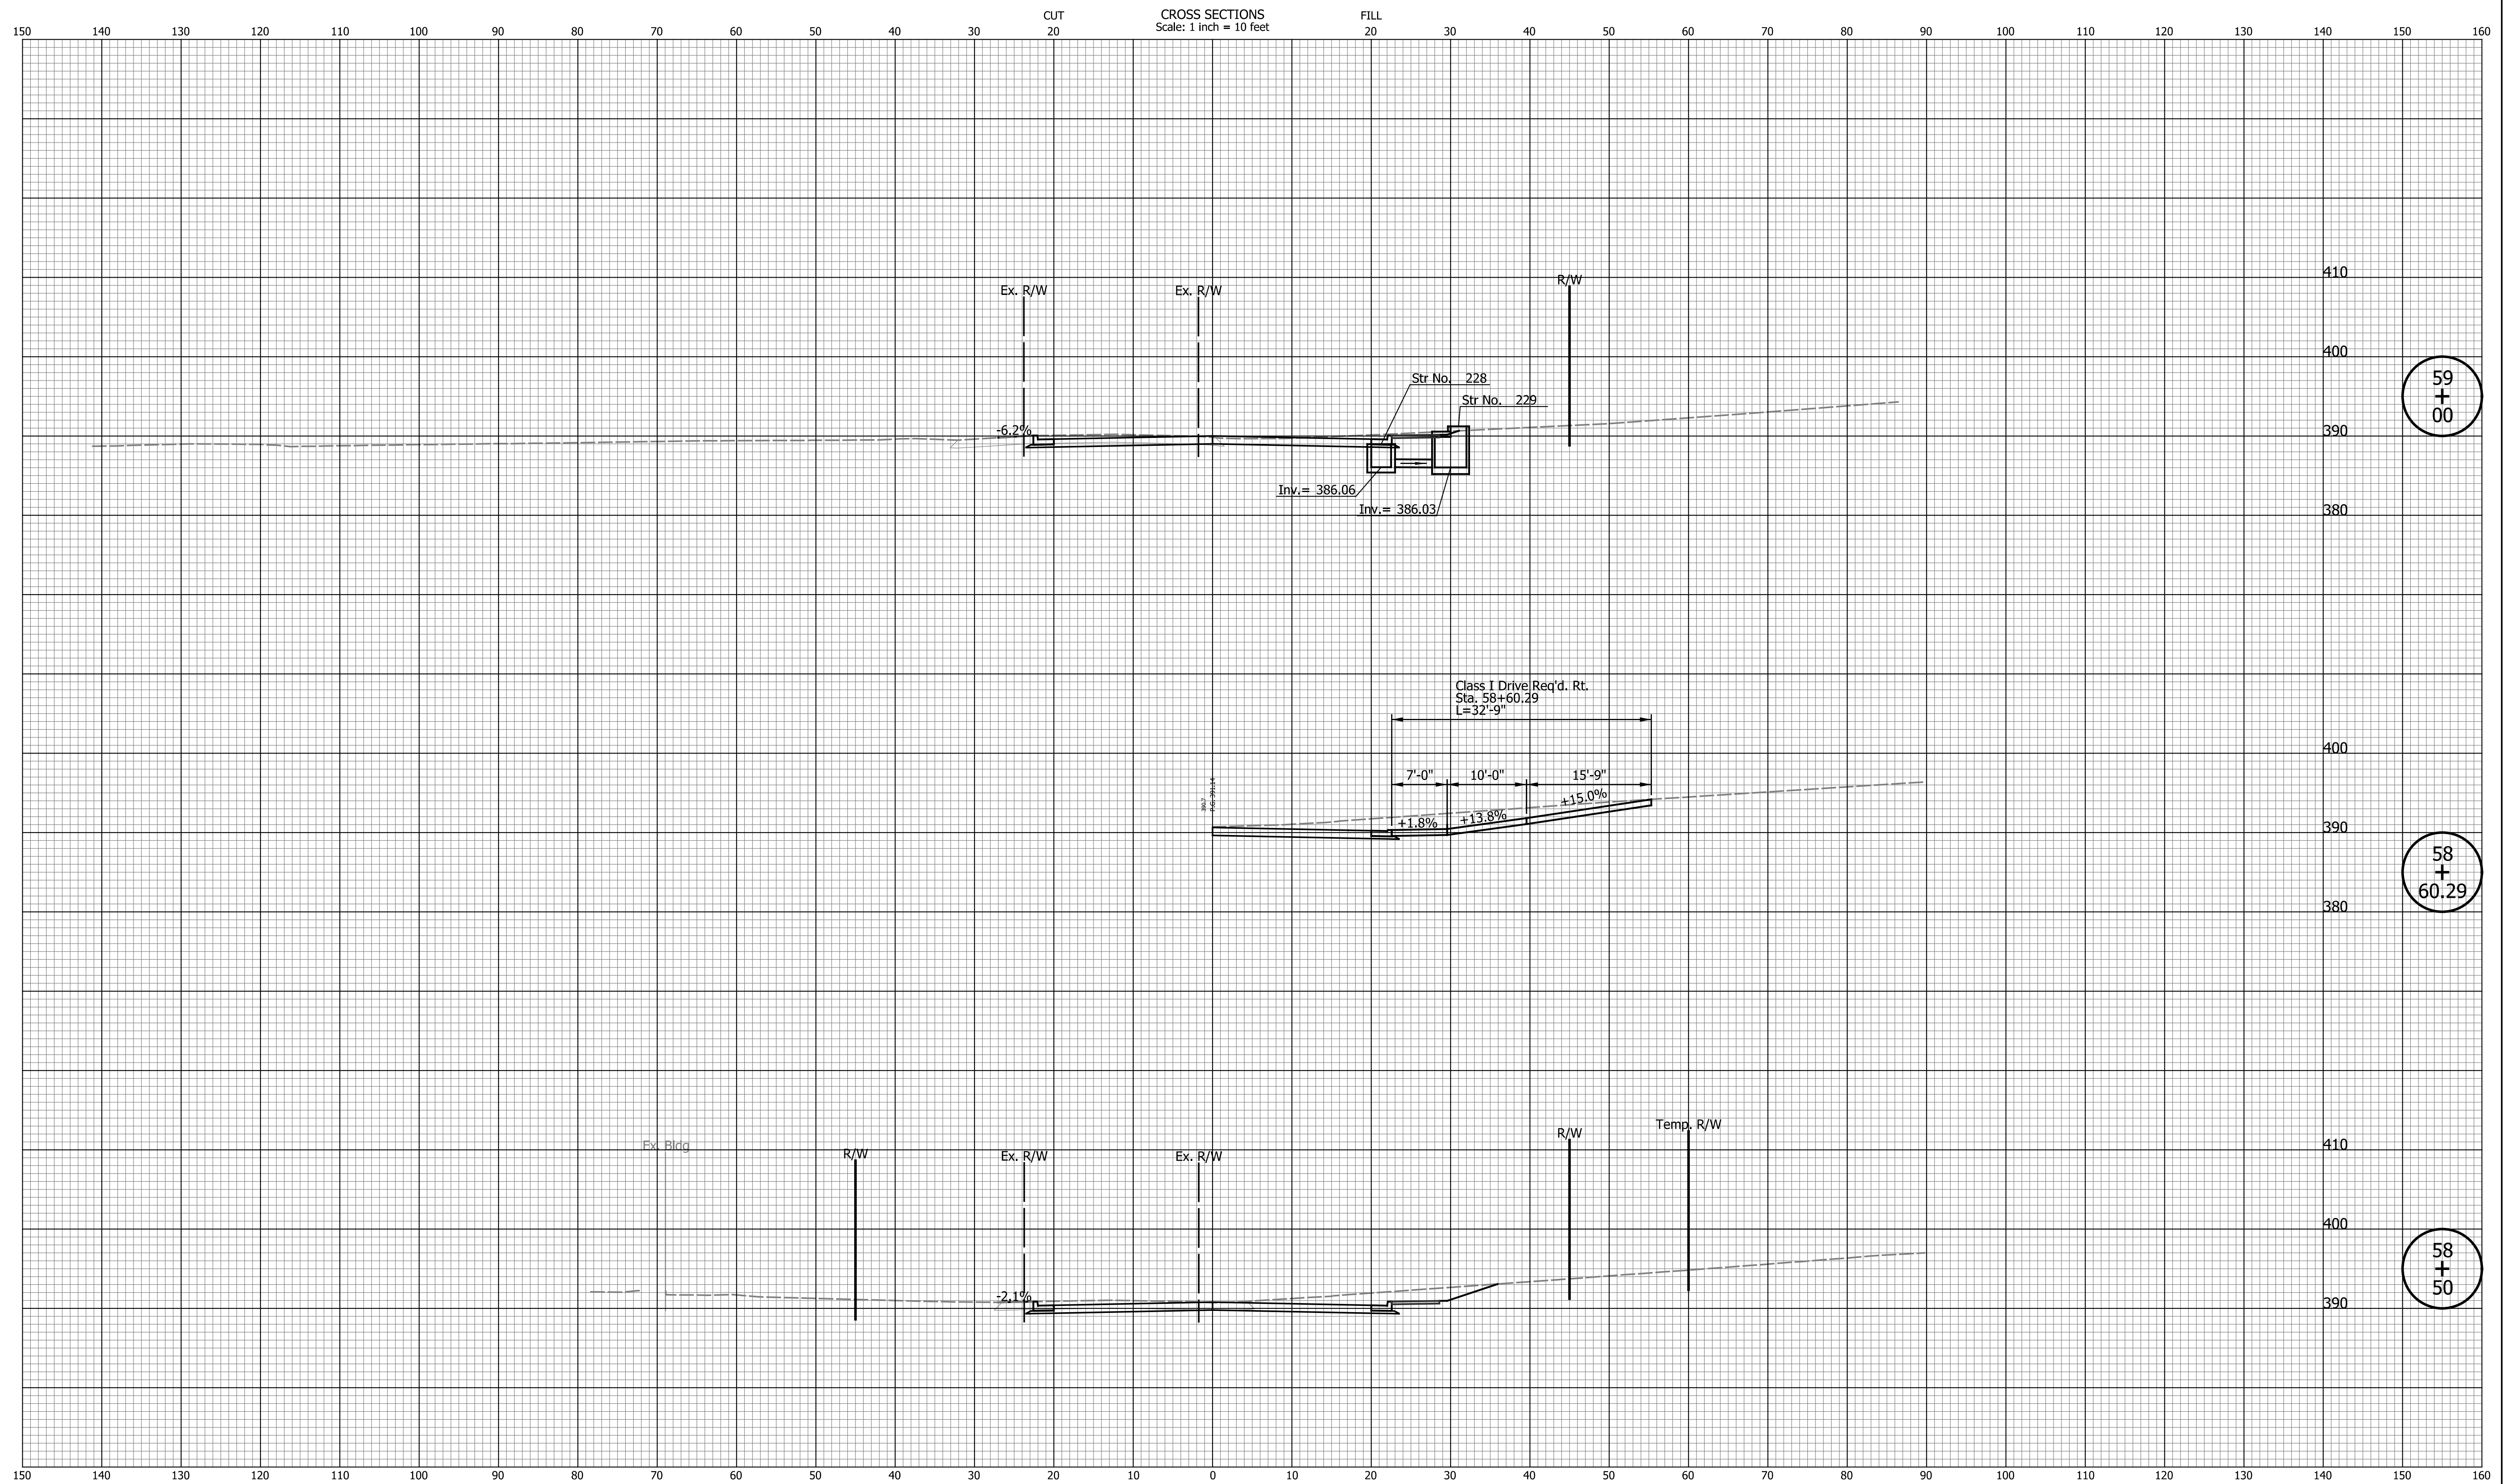

59
+
00

58
+
60.29

58
+
50

DATE	REVISION


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DESIGNED: JAB	DRAWN: EAK	
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INDIANA DEPARTMENT OF TRANSPORTATION

CROSS SECTIONS LINE "PR-A"

HORIZONTAL SCALE	BRIDGE FILE
1" = 10'	N/A
VERTICAL SCALE	DESIGNATION
1" = 10'	2002538
SURVEY BOOK	SHEETS
N/A	108 of 117
CONTRACT	PROJECT
R-43470	2002538

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59
+
66.54

59
+
50

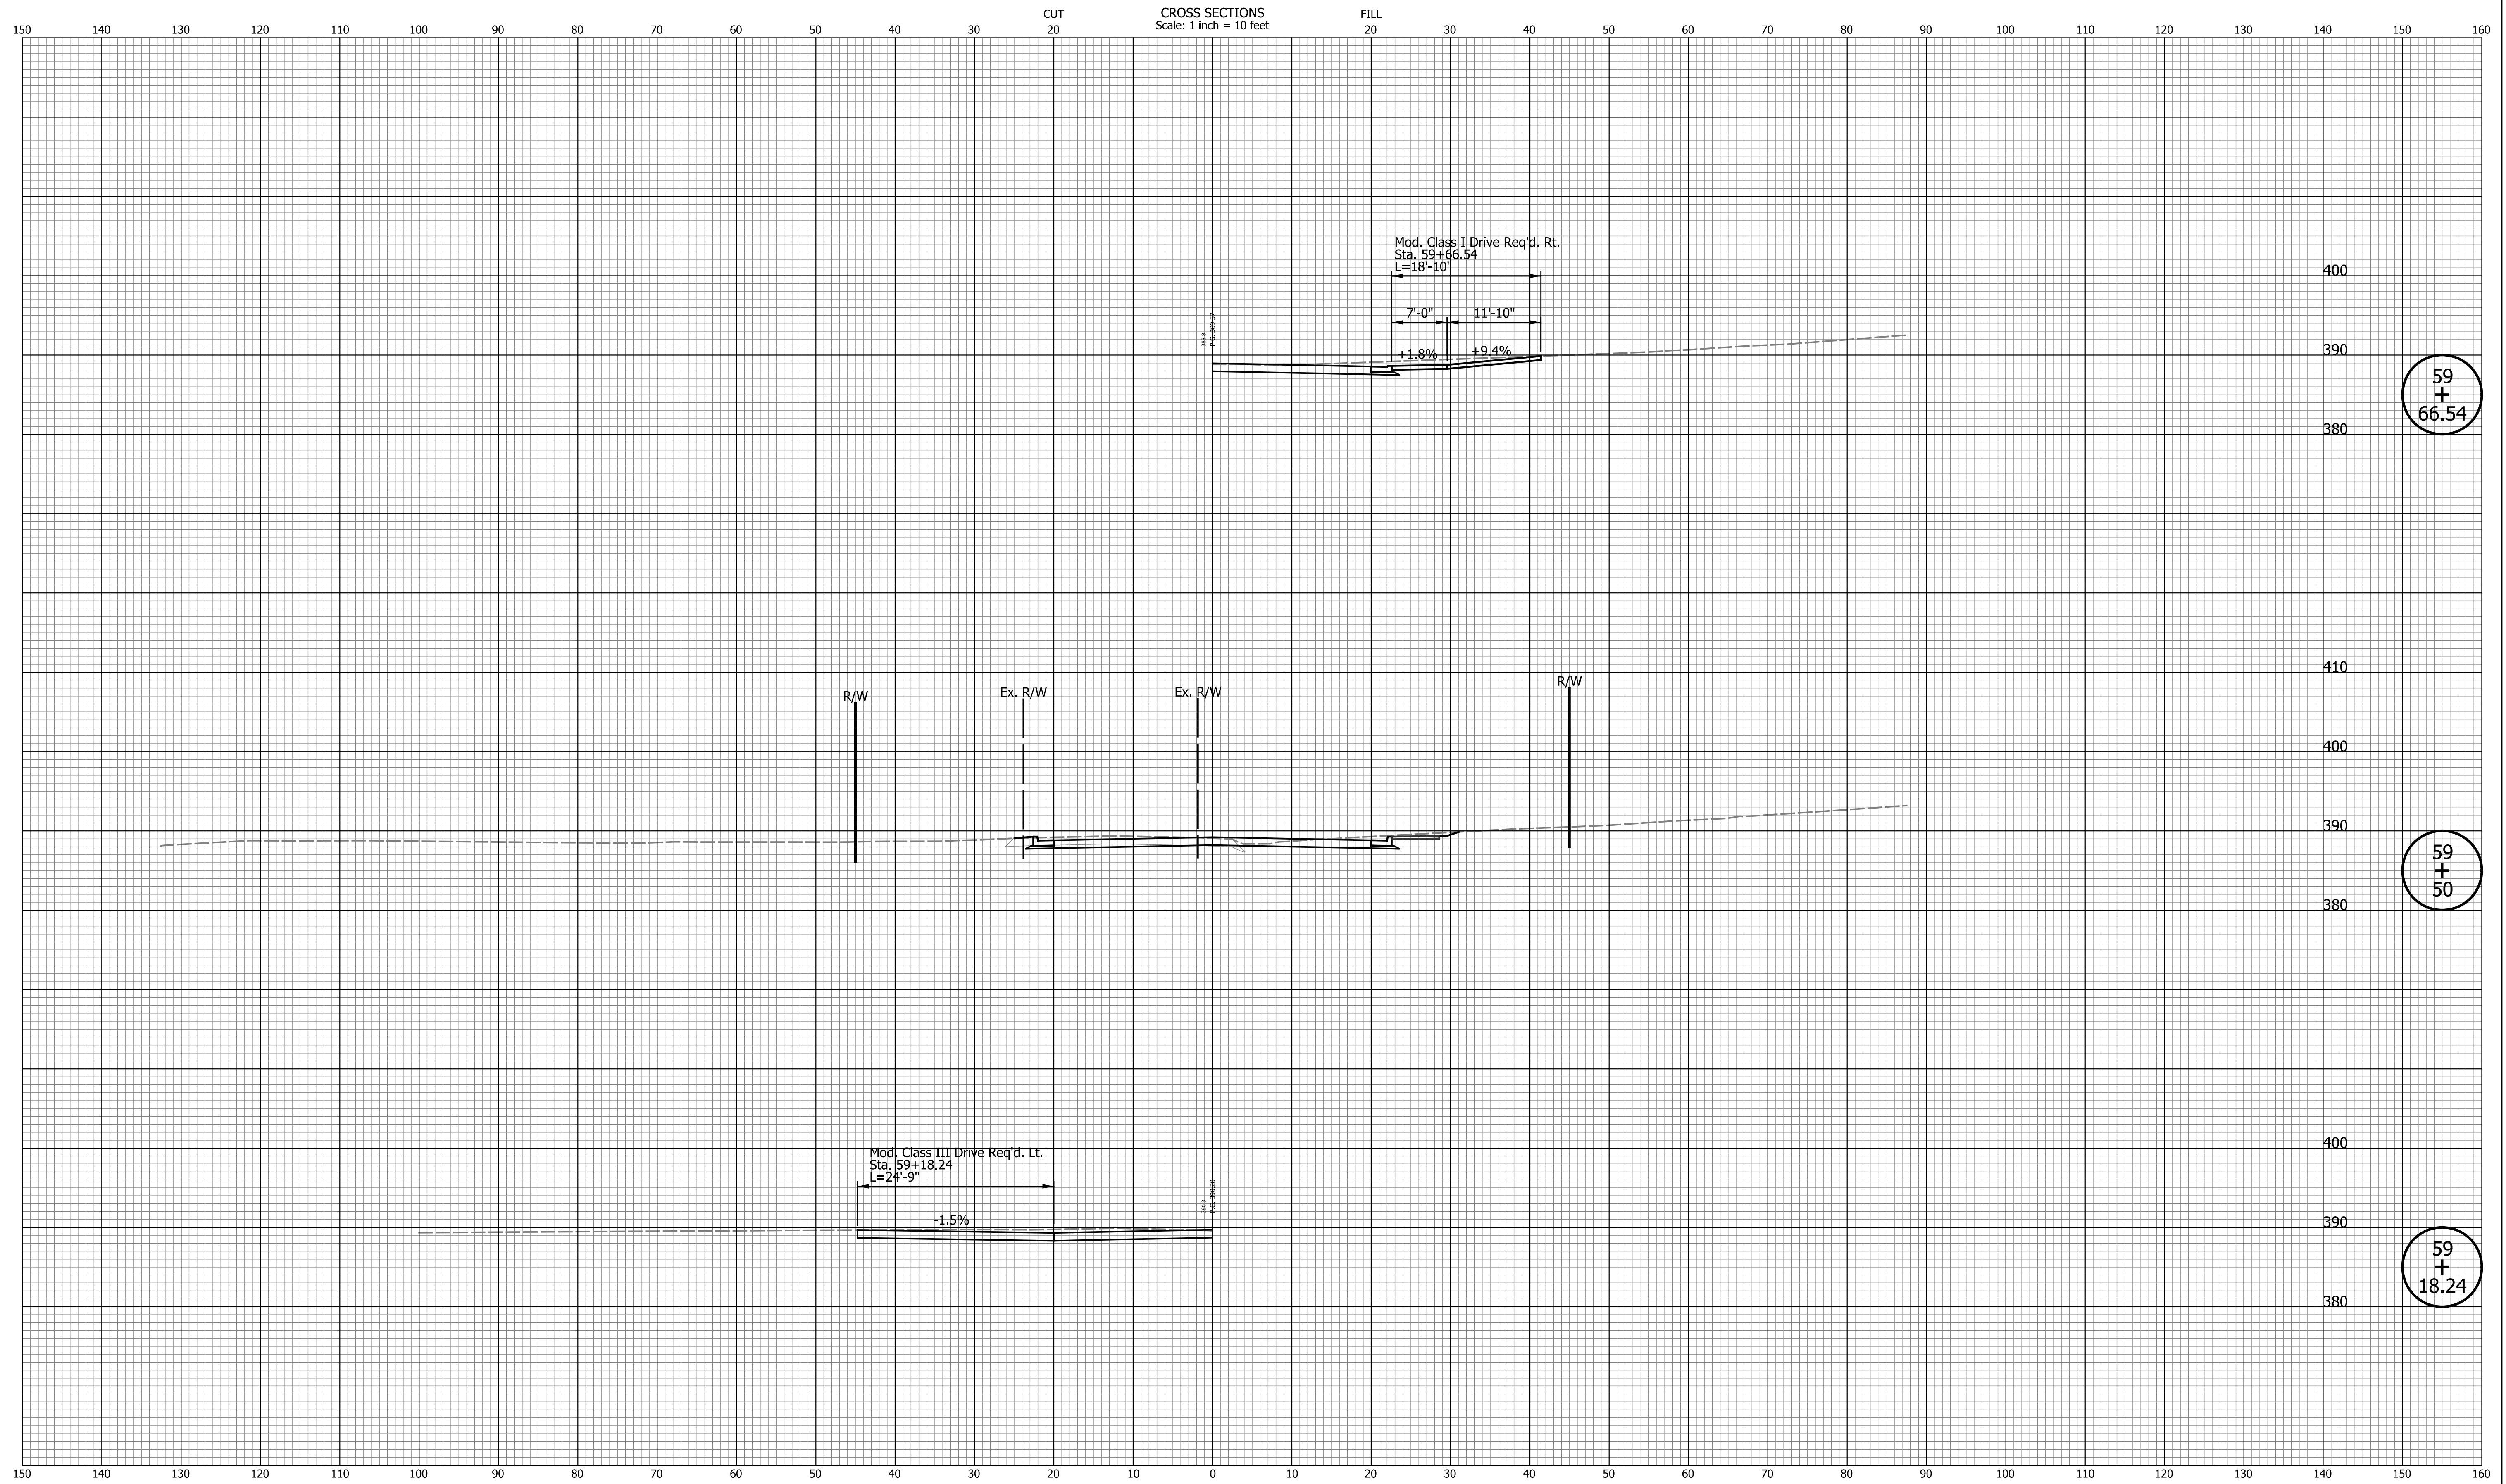59
+
18.24


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DESIGNED: JAB	DRAWN: EAK	
CHECKED: TMS	CHECKED: TMS	

INDIANA DEPARTMENT OF TRANSPORTATION

CROSS SECTIONS LINE "PR-A"

HORIZONTAL SCALE	BRIDGE FILE
1" = 10'	N/A
VERTICAL SCALE	DESIGNATION
1" = 10'	2002538
SURVEY BOOK	SHEETS
N/A	109 of 117
CONTRACT	PROJECT
R-43470	2002538

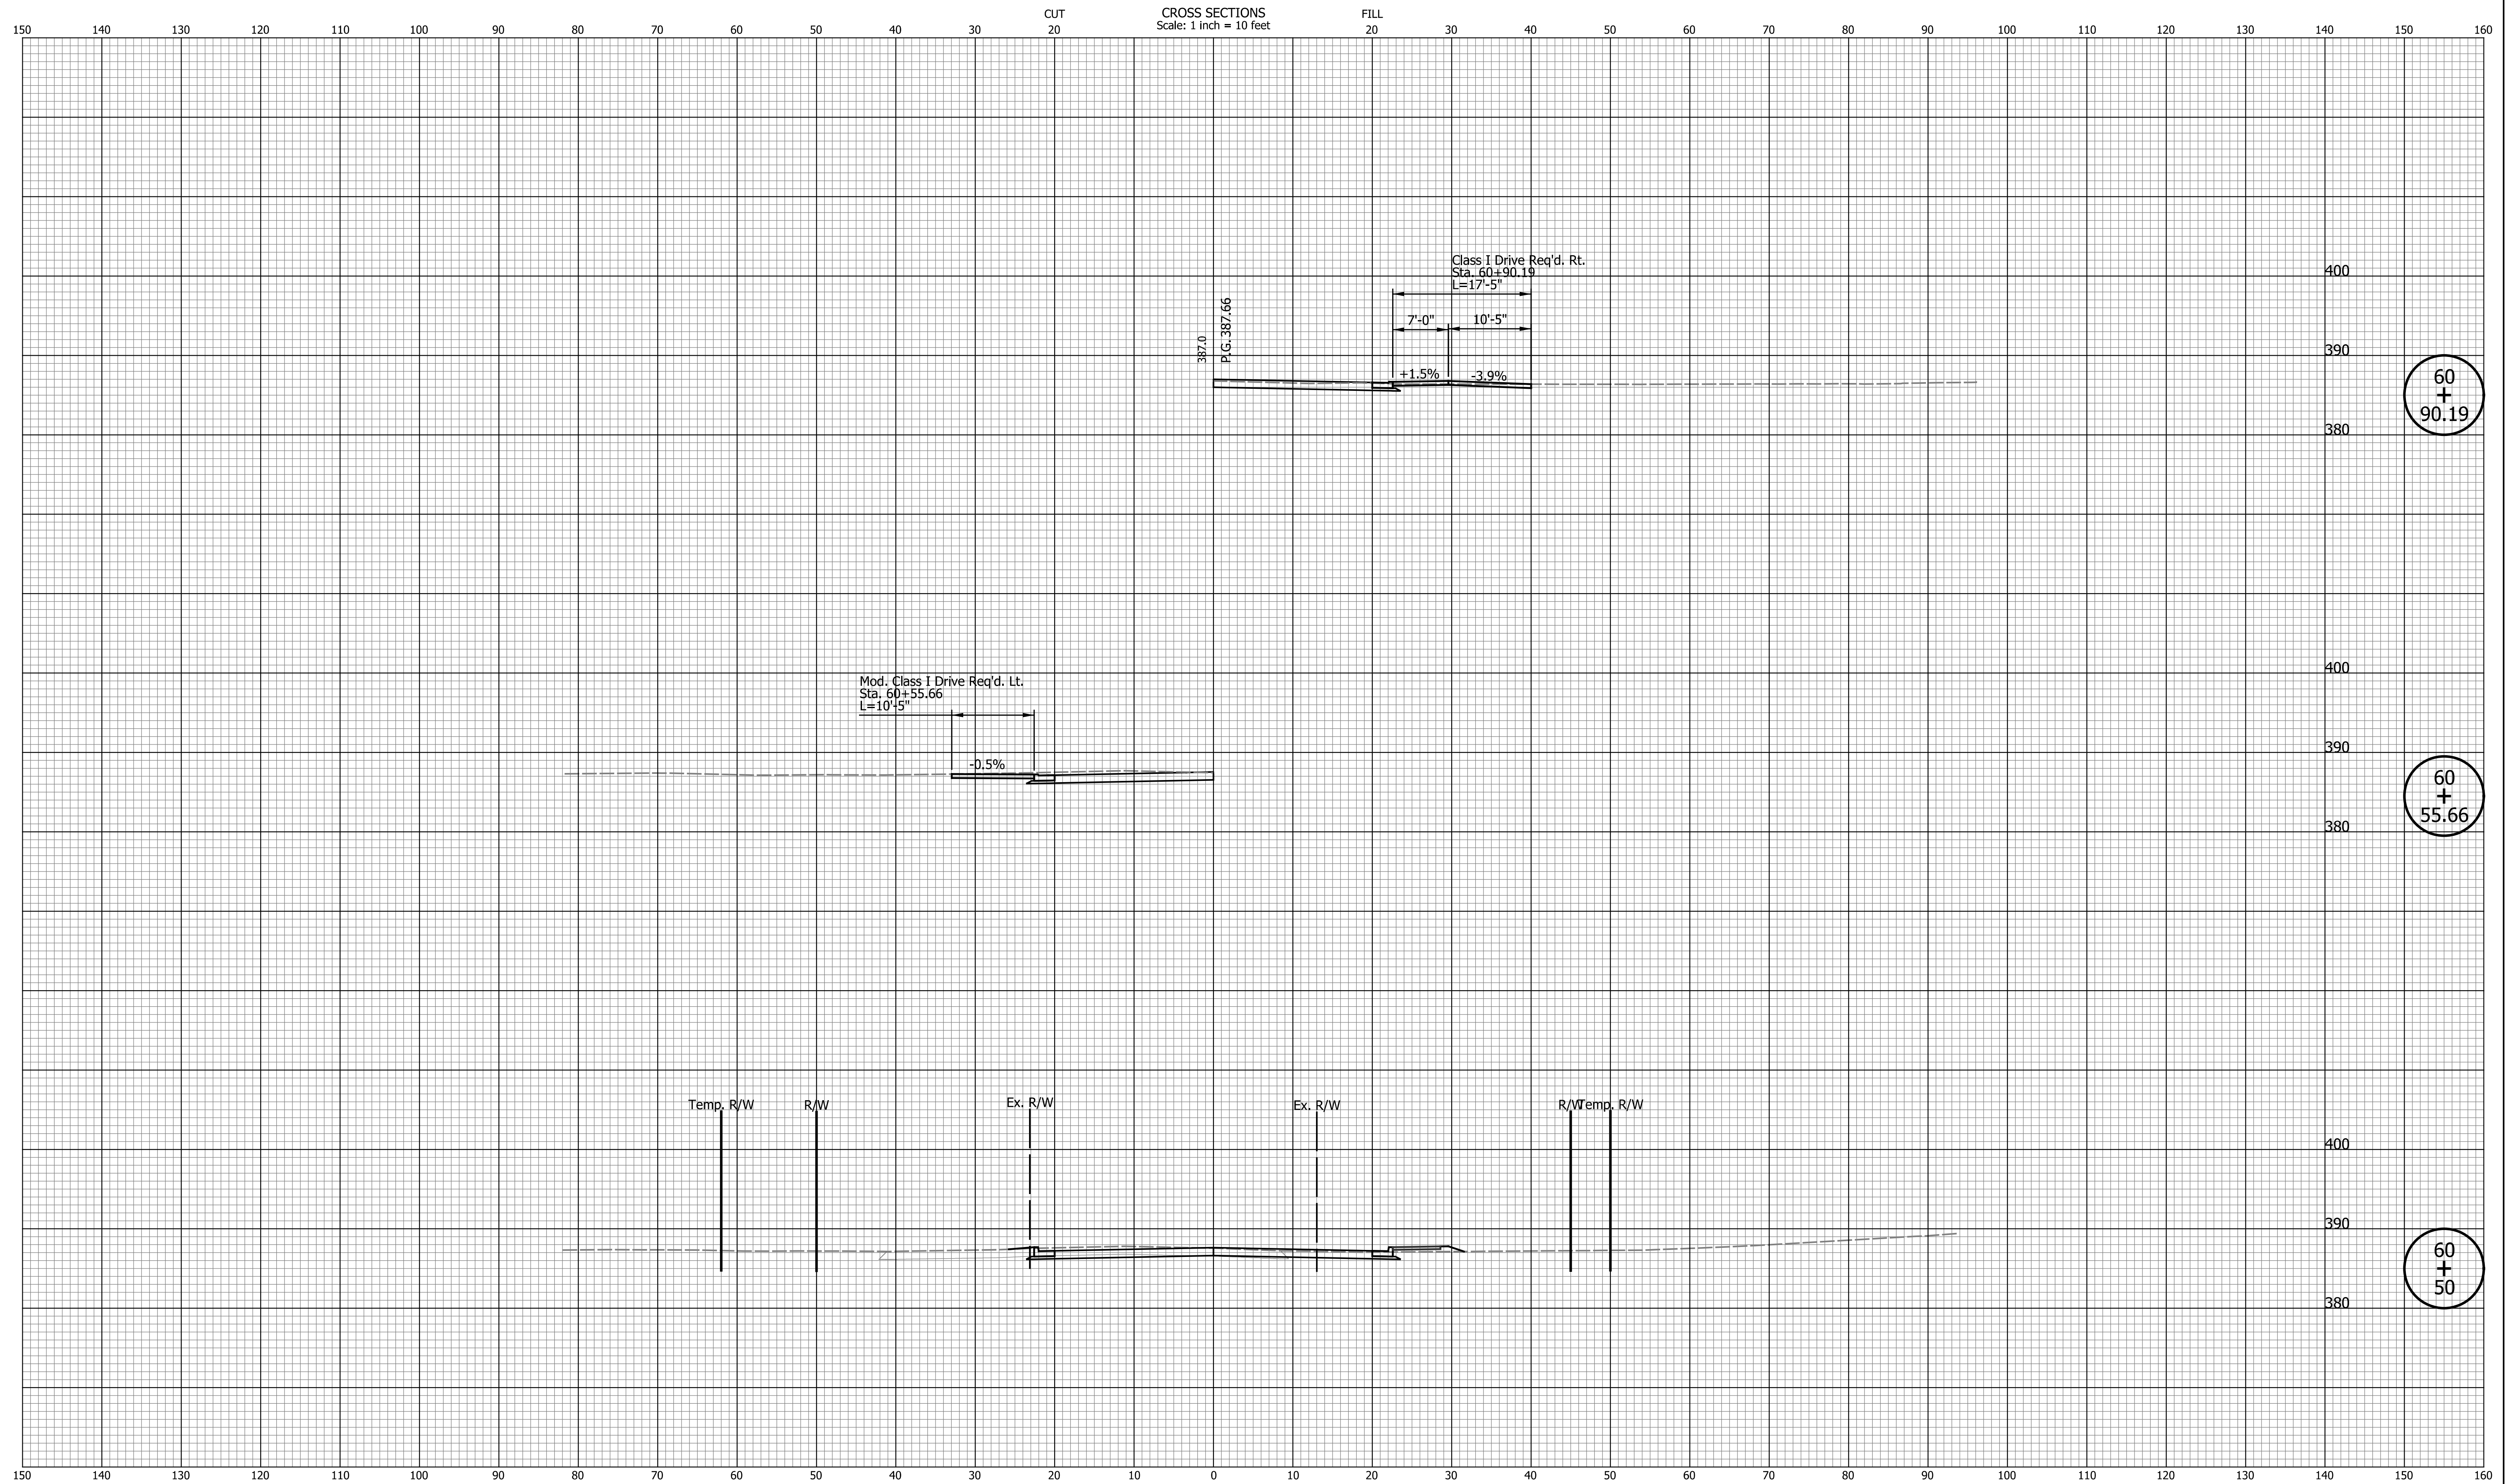

DATE	REVISION


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DESIGNED: JAB	DRAWN: EAK	
CHECKED: TMS	CHECKED: TMS	

INDIANA DEPARTMENT OF TRANSPORTATION

CROSS SECTIONS LINE "PR-A"

HORIZONTAL SCALE	BRIDGE FILE
1" = 10'	N/A
VERTICAL SCALE	DESIGNATION
1" = 10'	2002538
SURVEY BOOK	SHEETS
N/A	111 of 117
CONTRACT	PROJECT
R-43470	2002538

Indiana State

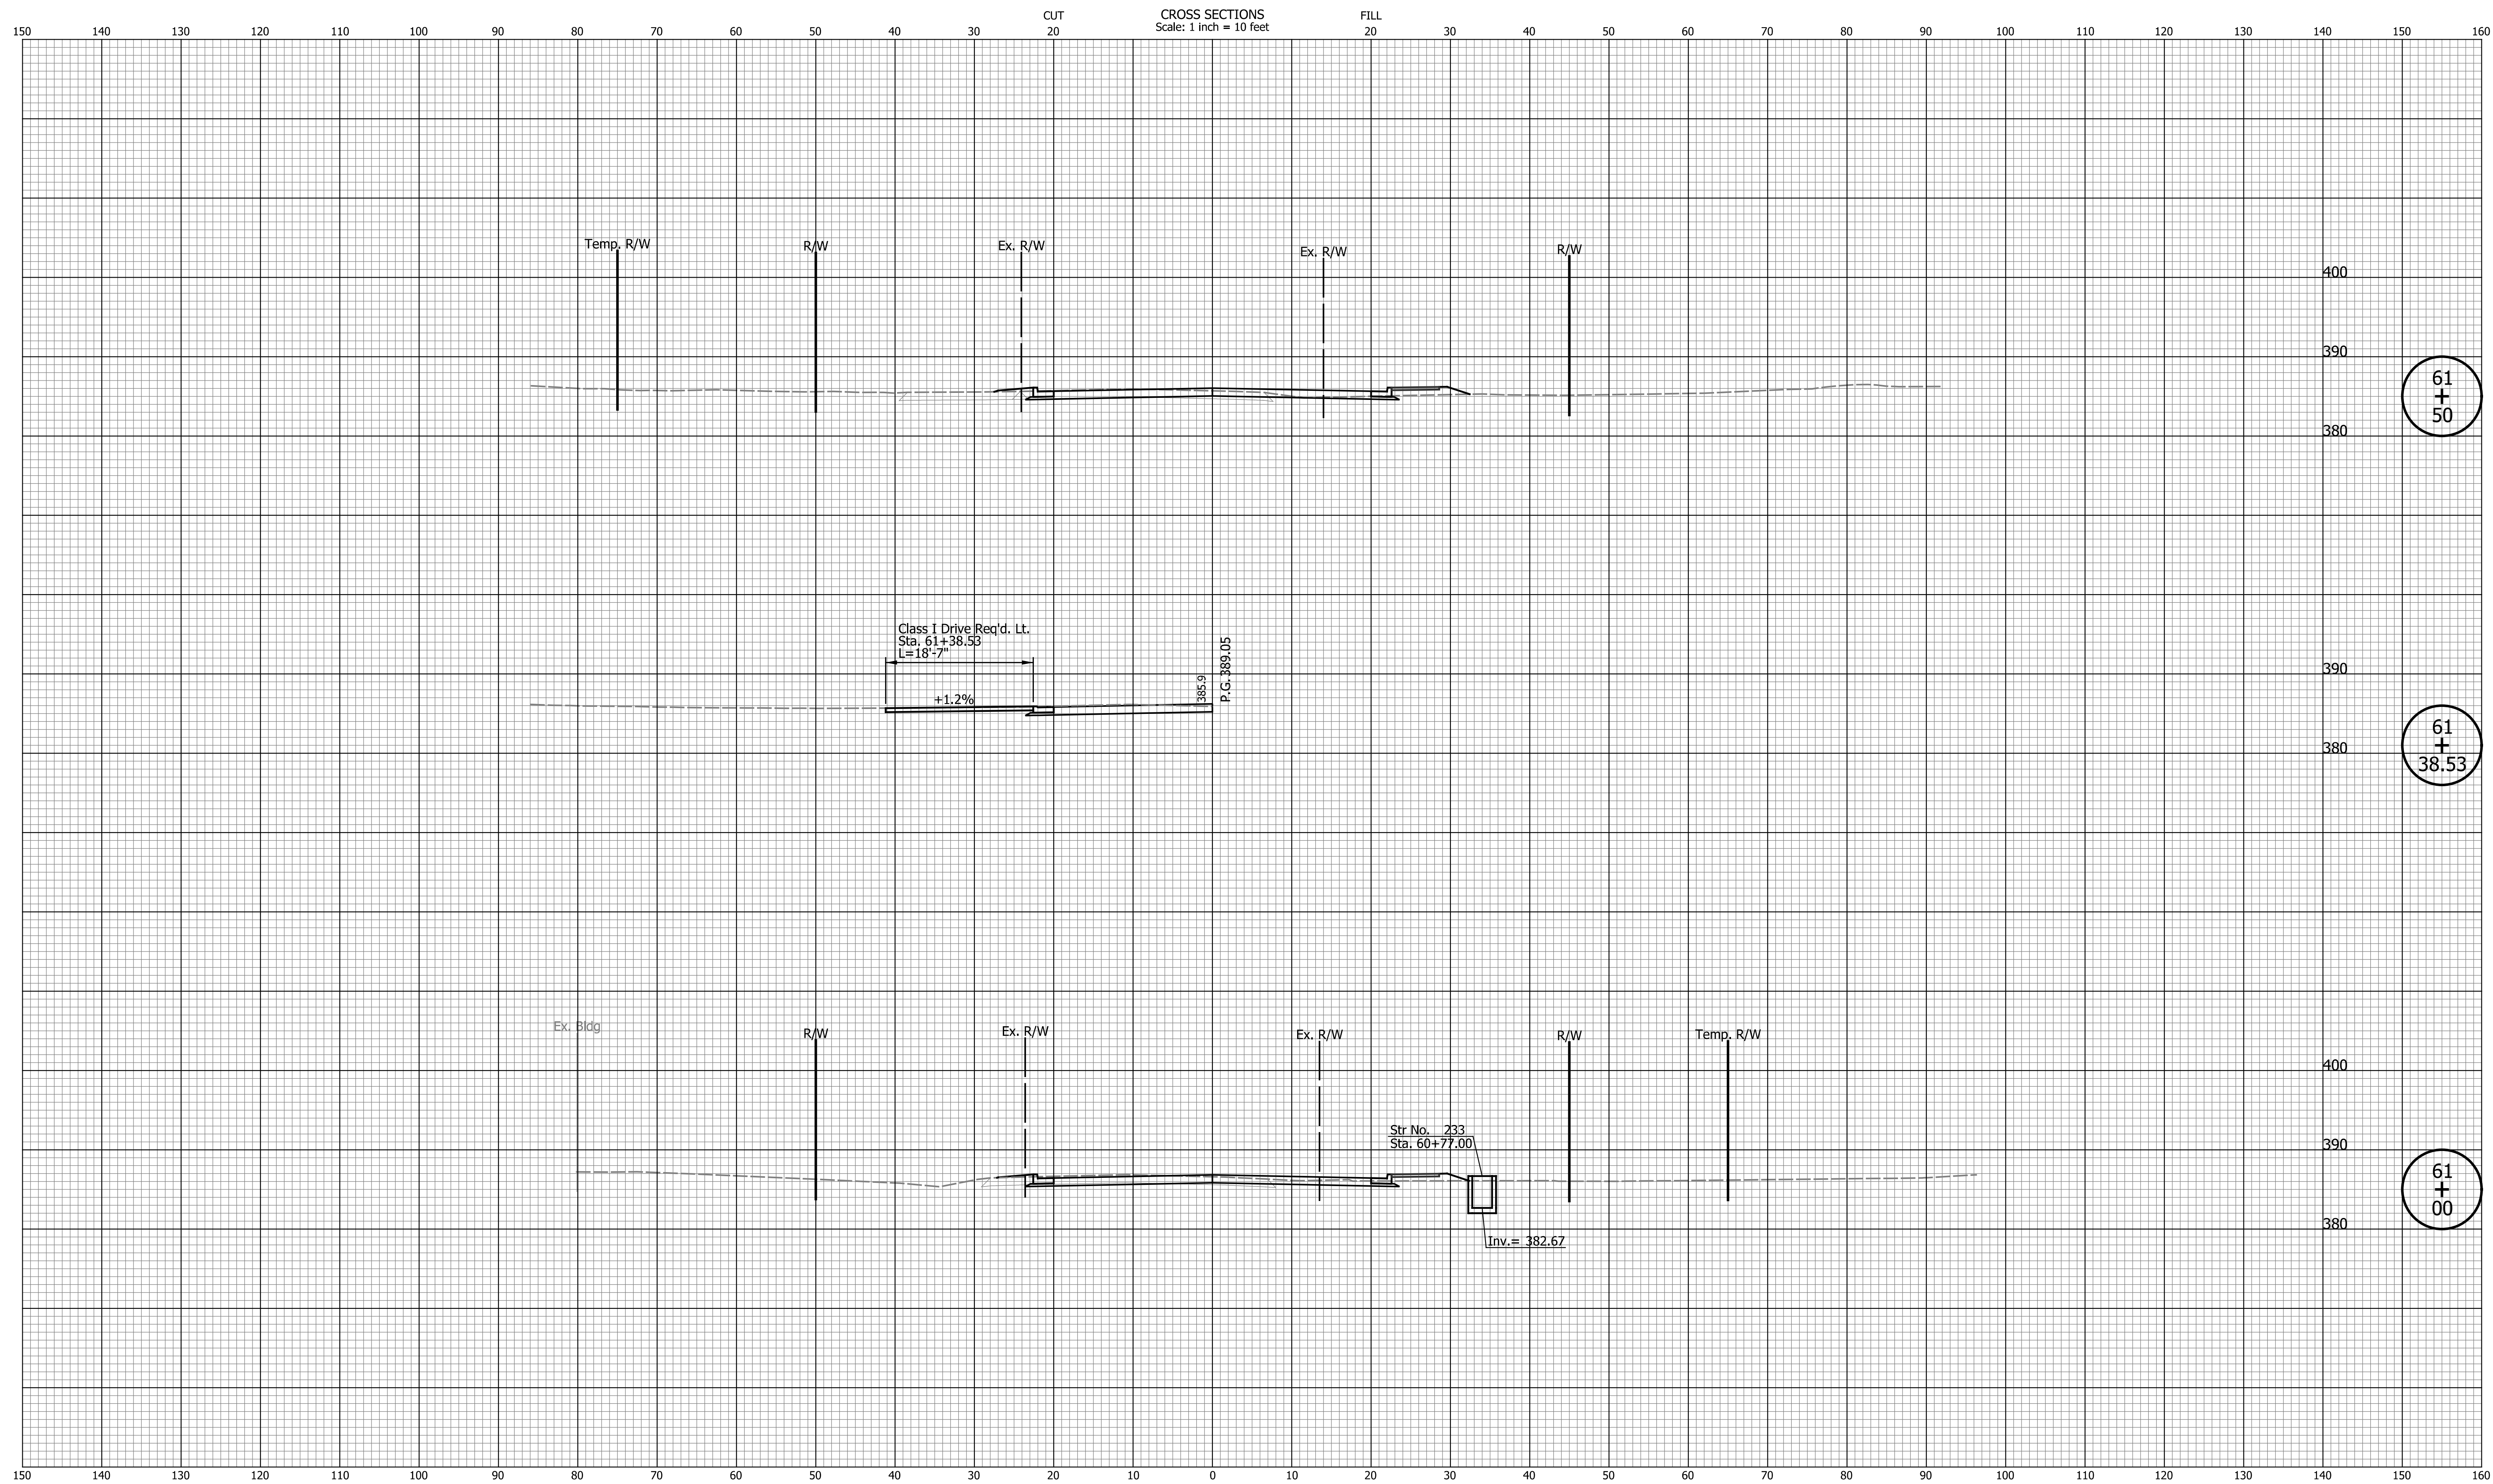


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RECOMMENDED FOR APPROVAL _____	DESIGN ENGINEER _____	DATE _____
DESIGNED: _____ JAB _____	DRAWN: _____ EAK _____	
CHECKED: _____ TMS _____	CHECKED: _____ TMS _____	

INDIANA DEPARTMENT OF TRANSPORTATION

CROSS SECTIONS LINE "PR-A"

HORIZONTAL SCALE 1" = 10'	BRIDGE FILE N/A
VERTICAL SCALE 1" = 10'	DESIGNATION 2002538
SURVEY BOOK N/A	SHEETS 112 of 117
CONTRACT R-43470	PROJECT 2002538

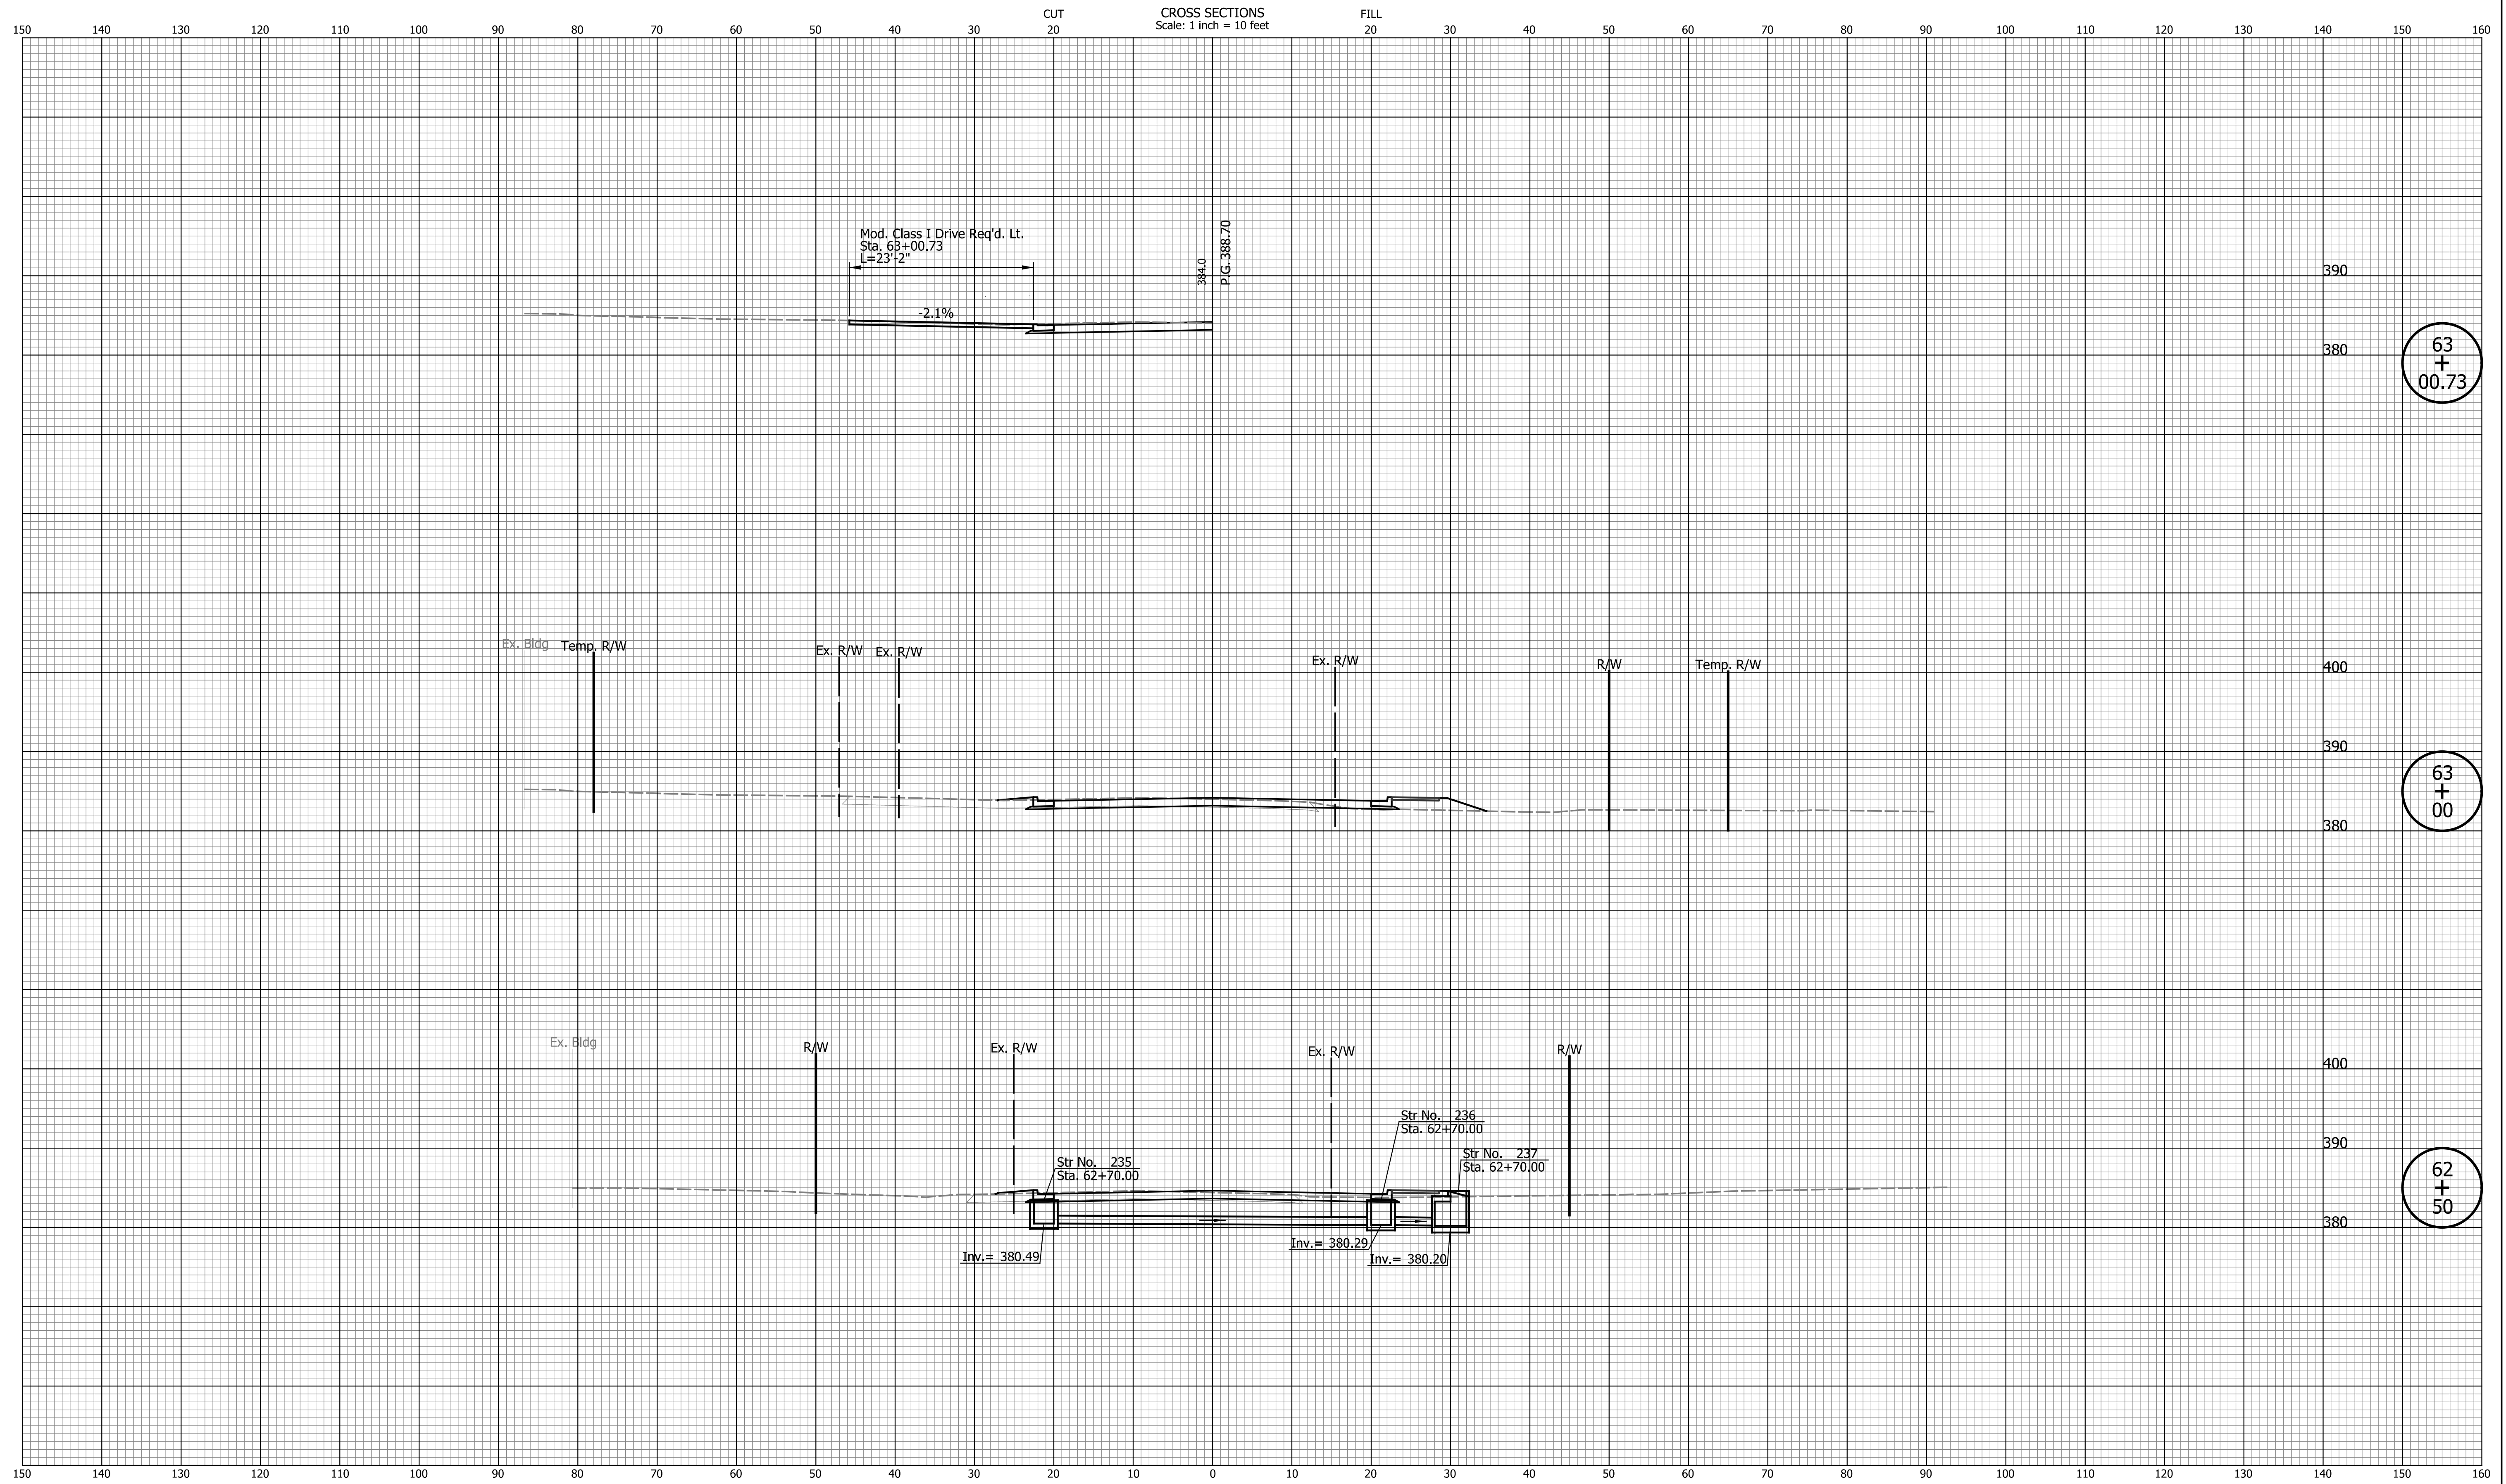


DATE	REVISION

RECOMMENDED FOR APPROVAL	DESIGN ENGINEER	DATE
DESIGNED: JAB	DRAWN: EAK	
CHECKED: TMS	CHECKED: TMS	

INDIANA DEPARTMENT OF TRANSPORTATION

CROSS SECTIONS LINE "PR-A"

HORIZONTAL SCALE	BRIDGE FILE
1" = 10'	N/A
VERTICAL SCALE	DESIGNATION
1" = 10'	2002538
SURVEY BOOK	SHEETS
N/A	114 of 117
CONTRACT	PROJECT
R-43470	2002538

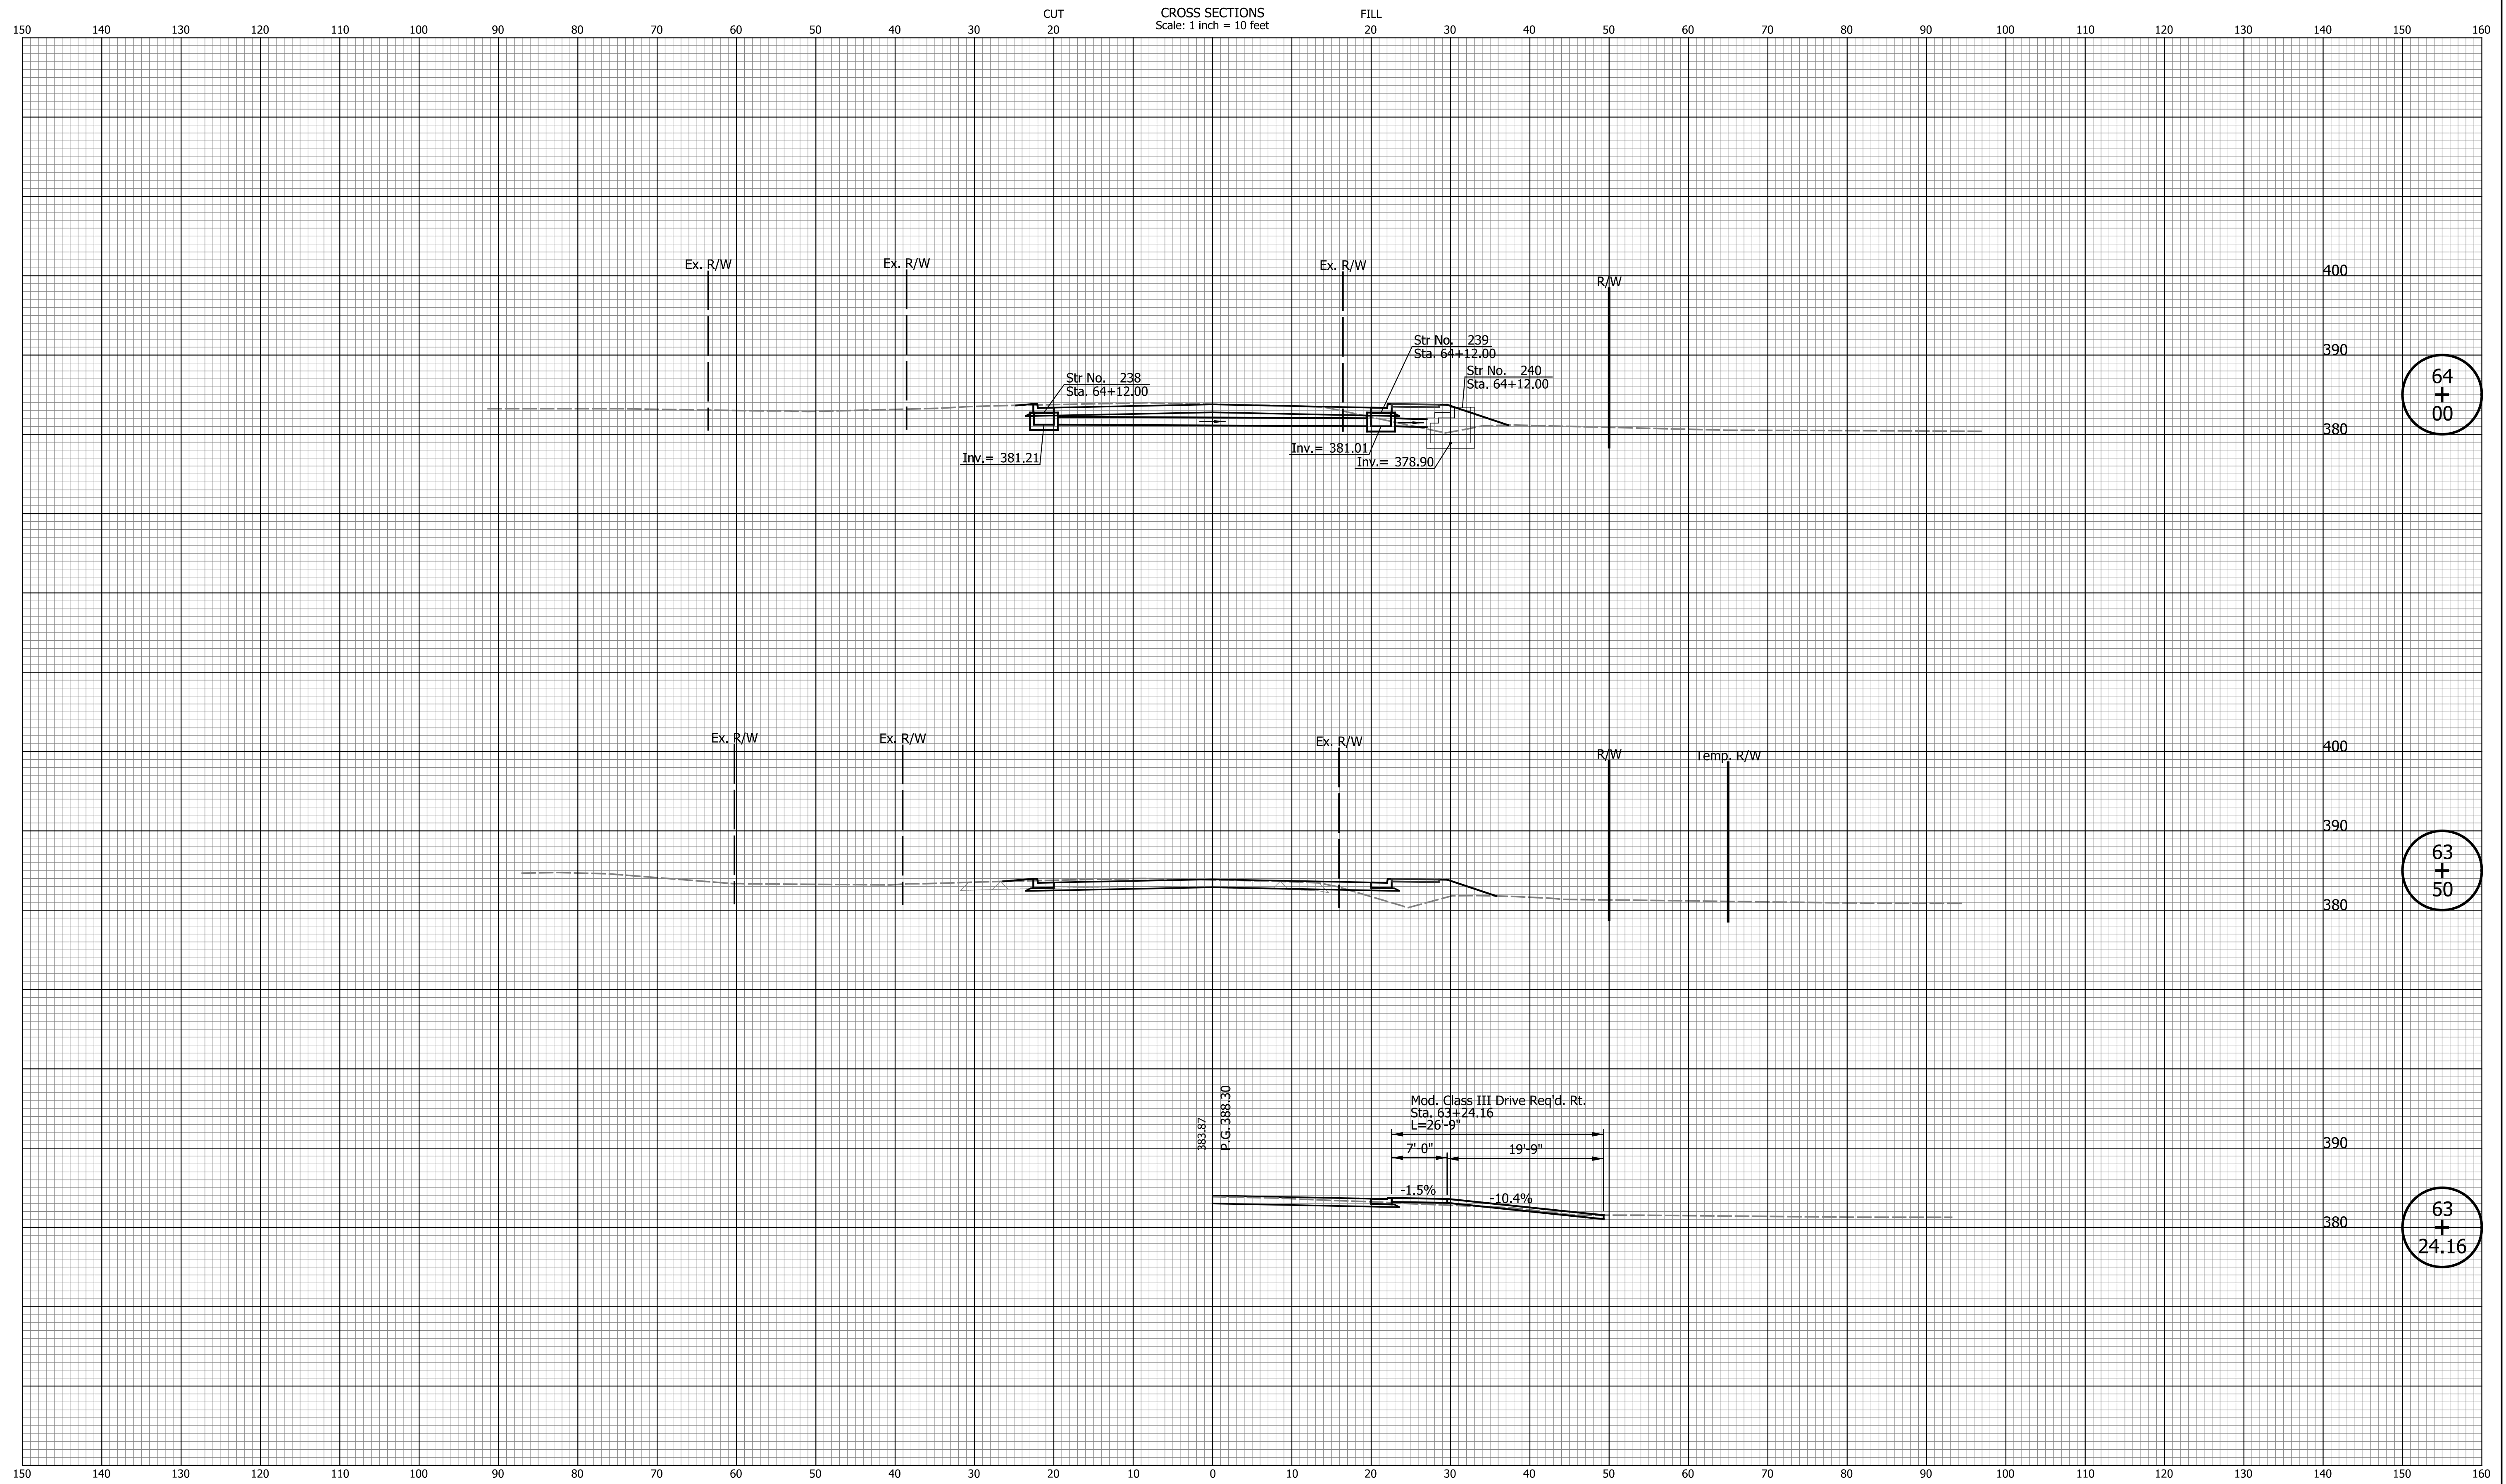

64
+
00

63
+
50

63
+
24.16


DATE	REVISION

RECOMMENDED FOR APPROVAL _____	DESIGN ENGINEER _____ DATE _____
DESIGNED: _____ JAB _____	DRAWN: _____ EAK _____
CHECKED: _____ TMS _____	CHECKED: _____ TMS _____

INDIANA DEPARTMENT OF TRANSPORTATION	
CROSS SECTIONS LINE "PR-A"	

HORIZONTAL SCALE 1" = 10'	BRIDGE FILE N/A
VERTICAL SCALE 1" = 10'	DESIGNATION 2002538
SURVEY BOOK N/A	SHEETS 115 of 117
CONTRACT R-43470	PROJECT 2002538

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DATE	REVISION

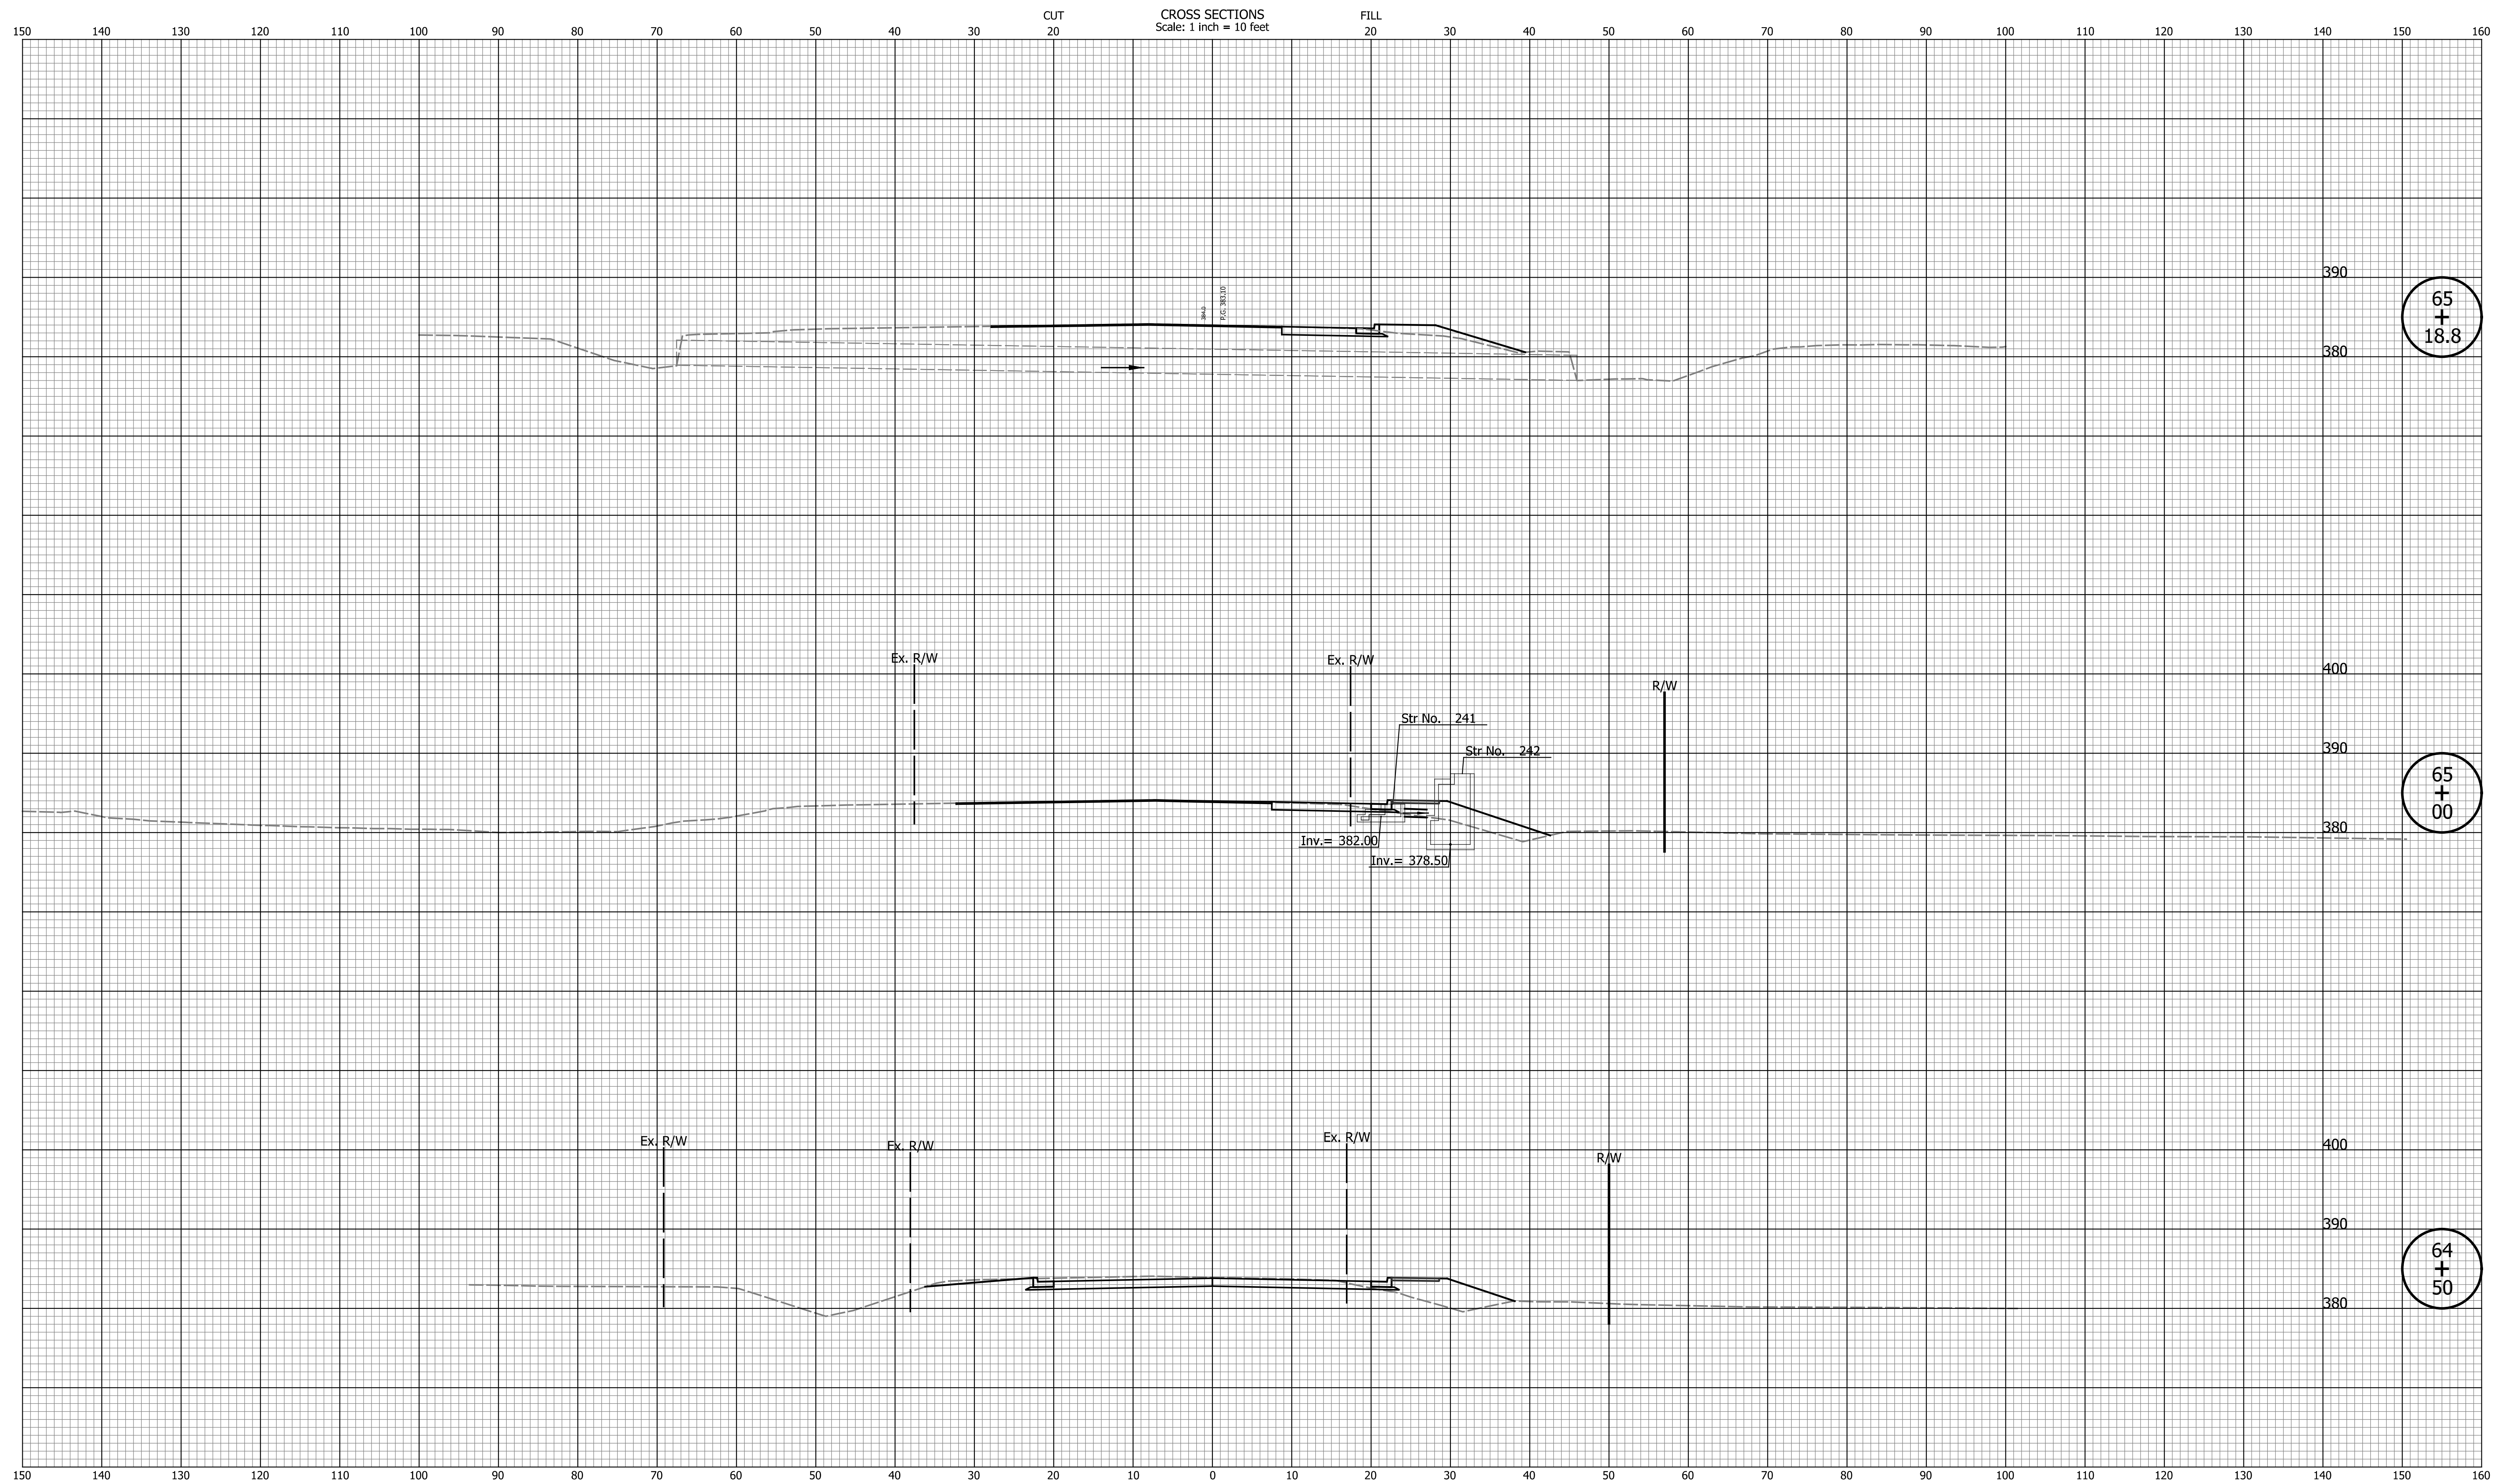RECOMMENDED FOR APPROVAL	DESIGN ENGINEER	DATE
DESIGNED: JAB	DRAWN: EAK	
CHECKED: TMS	CHECKED: TMS	

INDIANA DEPARTMENT OF TRANSPORTATION

CROSS SECTIONS LINE "PR-A"

HORIZONTAL SCALE	BRIDGE FILE
1" = 10'	N/A
VERTICAL SCALE	DESIGNATION
1" = 10'	2002538
SURVEY BOOK	SHEETS
N/A	116 of 117
CONTRACT	PROJECT
R-43470	2002538

